GENERAL NOTES:

THE FOLLOWING NOTES SHALL APPLY THROUGHOUT. EXCEPTIONS ARE SPECIFICALLY NOTED ON EACH DRAWING.

1. ALL WORK OF THIS CONTRACT SHALL BE DONE IN ACCORDANCE WITH THE LATEST EDITION OF THE 2014 NEW YORK CITY BUILDING CODE AND REGULATIONS OF OTHER AGENCIES HAVING JURISDICTION ON THE WORK OF THIS CONTRACT.

2. DRAWINGS ARE NOT BE SCALED. USE DIMENSIONS ONLY. ALL DIMENSIONS AND CONDITIONS SHOWN AND ASSUMED ON THE DRAWINGS MUST BE VERIFIED AT THE SITE BY THE CONTRACTOR BEFORE ORDERING ANY MATERIAL OR DOING ANY WORK. ANY DISCREPANCIES IN THE DRAWINGS AND SPECIFICATIONS SHALL BE REPORTED TO THE AUTHORITY. NO CHANGE IN DRAWINGS OR SPECIFICATIONS IS PERMISSIBLE WITHOUT THE WRITTEN CONSENT OF THE ARCHITECT/ENGINEER. NO WORK SHALL PROCEED UNTIL SUCH DISCREPANCY HAS BEEN RECTIFIED.

3. ALL WORK ON THESE DRAWINGS SHALL BE CONSIDERED NEW WORK WHETHER STATED OR NOT EXCEPT WHERE SPECIFICALLY NOTED AS "EXISTING TO REMAIN".

4. COORDINATION OF ALL WORK UNDER THIS CONTRACT SHALL BE MAINTAINED TO ENSURE THE QUALITY AND TIMELY COMPLETION OF THE WORK/PROJECT.

5. THE CONTRACTOR SHALL DISCONNECT AND/OR REMOVE ANY EXISTING PLUMBING, ELECTRICAL FIXTURES, WIRE CONDUITS, OR OTHER WORK WHICH MIGHT INTERFERE WITH THE WORK OF THIS CONTRACT. AFTER NEW WORK IS COMPLETED, THE DISCONNECTED OR REMOVED ITEMS SHALL BE REINSTALLED BY THE CONTRACTOR AT THE SAME LOCATION OR AT NEW LOCATION AS DIRECTED. FURNISH ALL NECESSARY NEW MATERIALS/HARDWARE FOR COMPLETION OF WORK.

6. THE CONTRACTOR SHALL PATCH AND REPAIR ALL DAMAGED OR EXPOSED SURFACES DUE TO CONTRACT WORK. ALL NEWLY INSTALLED, PATCHED WORK AND ALL AFFECTED AREAS SHALL BE PAINTED. ALL PAINTING WORK SHALL BE PERFORMED TO COVER THE ENTIRE HORIZONTAL OR VERTICAL SURFACE TO THE CLOSEST CORNER IN ALL FOUR DIRECTIONS. COLOR TO MATCH EXISTING CONDITIONS.

7. THE CONTRACTOR SHALL FURNISH AND INSTALL NEW MATERIALS AT NO ADDITIONAL COST TO THE AUTHORITY FOR THE FOLLOWING CONDITIONS:

a) ANY EXISTING WORK THAT HAS BEEN REMOVED OR DAMAGED IN ORDER TO PERFORM THE CONTRACT WORK. b) TO FURNISH THE WORK OF THIS CONTRACT IN WORKMANLIKE MANNER.

8. THE CONTRACTOR SHALL BE RESPONSIBLE FOR ADEQUATELY BRACING AND PROTECTING ALL WORK DURING CONSTRUCTION AGAINST DAMAGE, BREAKAGE, COLLAPSE, DISTORTIONS AND OFF ALIGNMENTS ACCORDING TO CODES AND STANDARDS OF GOOD PRACTICE.

9. THE CONTRACTOR SHALL INCLUDE ALL PREPATORY AND ASSOCIATED SUPPLEMENTARY WORK TO PROVIDE A COMPLETE AND FINISHED INSTALLATION.

10. WHERE MANUFACTURER'S NAMES AND PRODUCT NUMBERS ARE INDICATED ON DRAWINGS, IT SHALL BE CONSTRUED TO MEAN THE ESTABLISHMENT OF QUALITY AND PERFORMANCE STANDARDS OF SUCH ITEMS. ALL OTHER PRODUCTS MUST BE SUBMITTED TO THE ARCHITECT FOR APPROVAL BEFORE THEY SHALL BE DEEMED EQUAL.

11. FIRESTOPPING SHALL BE INSTALLED AT ALL PENETRATIONS OF FIRE RATED CONSTRUCTION AS PER SPECIFICATIONS.

12. SIZE OF MASONRY UNITS AND WOOD MEMBERS ON PLANS, BUILDING ELEVATIONS AND SECTIONS ARE SHOWN AS NOMINAL SIZE.

13. DIMENSIONS ON PLANS ARE INDICATED FROM SURFACE TO SURFACE BETWEEN WALLS, PARTITIONS AND OTHER ITEMS EXCLUSIVE OF FINISHES.

14. PROVIDE GUARDS, RAILS, BARRICADES, FENCES, SIDEWALK SHEDS, CATCH PLATFORMS, DECKING, NIGHT LIGHTING, ETC., AS REQUIRED BY THE 2014 NEW YORK CITY BUILDING CODE, SECTION 3307.3 AND AS REQUIRED TO PROVIDE ADEQUATE PROTECTION. ALSO, COMPLY WITH SECTION S01500, S011535 AND S01900 OF THE SPECIFICATION.

15. THE CONTRACTOR SHALL KEEP WORK SITE FREE FROM DEBRIS AND ACCUMULATED REFUSE, AND SHALL HAVE SOLE RESPONSIBILITY FOR PROTECTING ALL DANGEROUS AREAS FROM ENTRY BY UNAUTHORIZED PARTIES. SITE SHALL BE LEFT BROOM CLEAN AT THE END OF EACH WORKING DAY.

16. THE CONTRACTOR SHALL MAINTAIN FREE AND UNOBSTRUCTED ACCESS FROM ALL ADJACENT SPACES INTO THE EXISTING FIRE STAIRS TO OUTSIDE OF THE BUILDING AT ALL TIMES.

17. WHERE INDICATED OR REQUIRED TO PERFORM THE WORK, PACK, PROTECT AND RELOCATE BOOKS, MATERIALS, FURNITURE, CABINETS, ETC. TO DESIGNATED LOCATIONS WITHIN THE BUILDING AND RETURN ITEMS UPON COMPLETION OF WORK OR WHEN DIRECTED BY THE AUTHORITY.

18. THE CONTRACTOR SHALL, UNLESS OTHERWISE PROVIDED IN THE CONTRACT DOCUMENTS, SECURE AND PAY FOR REQUIRED INSPECTIONS, PERMIT(S), FEES, LICENSE AND INSPECTIONS NECESSARY FOR THE PROPER EXECUTION OF THE WORK.

19. THERE WILL BE NO CHANGE IN USE, EGRESS OR OCCUPANCY BECAUSE OF THE WORK UNDER THIS

20. ADDITIONAL NOTES WHICH ARE APPLICABLE TO THIS PROJECT MAY BE FOUND THROUGHOUT THE CONTRACT

21. CONTRACTOR TO ERECT CODE COMPLIANT SIDEWALK SHED ON ADJOINING NYCHA PROPERTY AT WEST SIDE OF BUILDING'S WEST WALL. SIDEWALK SHED SHALL HAVE CODE COMPLIANT LIGHTING.

CONTRACTOR SHALL SECURE PERMISSION FROM NYCHA AND PROVIDE ALL PERMITS REQUIRED.

22. CONTRACTOR TO PROVIDE FULL HEIGHT PIPE SCAFFOLSING INSIDE THE NORTH ELEVATION STAIR RECESS TO ACCESS THE BRICK REPLACEMENT WORK AT THE NORTH BULKHEAD AS SHOWN ON DRAWINGS A085 AND A406. PIPE SCAFFOLD TO START AT SECOND FLOOR ROOF AND RUN TO TOP OF NORTH BULKHEAD. THE PIPE SCAFFOLD IS TO HAVE DEBRIS SAFETY NETTING. THE PIPE SCAFFOLD SHALL HAVE PLANKS AT ALL FLOOR LEVELS. PROVIDE STAIRS TO ACCESS PLANKS AT ALL LEVELS. NO OTHER TYPE OF SCAFFOLDING IS ACCEPTABLE. THE PIPE SCAFFOLD SHALL BE CONSTRUCTED PRIOR TO WORK ON THE NORTH BULKHEAD AND BE MAINTEINED UNTIL THE PROJECT IS SUBSTANTIALLY COMPLETE AND SIGNED BY THE ARCHITECT/ENGINEER OF RECORD. THE CONTRACTOR SHALL PROVIDE TEMPORARY LIMIT STOPS AT UPPER AND LOWER SAHES OF ALL WINDOWS, WHICH ARE ACCESSIBLE FROM THE SCAFFOLDING THE DAY BEFORE ERECTING THE PIPE SCAFFOLDING. THE TEMPORARY STOPS SHALL BE ELIMINATED AFTER THE PIPE SCAFFOLDING IS REMOVED. FILL AND SEAL AREAS OF REMOVED ANCHORS.

23. CONTRACTOR TO ERECT CODE COMPLIANT SIDEWALK SHED AT MAIN ENTRANCE ON MANGIN STREET. SIDEWALK SHED SHALL HAVE CODE COMPLIANT LIGHTING.

24. PROVIDE PROJECT INFORMATION SIGNAGE MEETING REQUIREMENTS OF SECTION BC 3301.9.

25. CONCRETE FOR SLABS, RAMPS & OTHER WORK TO BE NORMAL WEIGHT CONCRETE fc=4000 PSI WITH W/C=

26. ALL EQUIPMENT AND MATERIALS ARE TO BE STORED OUT OF EGRESS PATHS INCLUDING EGRESS ACCESS TO ROOF. ALL EQUIPMENT AND MATERIAL STORAGE ARE TO BE COORDINATED WITH SCHOOL, AND ARE NOT TO OBSTRUCT WITH SCHOOL FUNCTIONS OR FIRE SAFETY.

SPECIAL INSPECTIONS

SPECIAL INSPECTIONS REQUIRED IN ACCORDANCE WITH CHAPTER 17 AND THE APPLICABLE SECTIONS OF THE NYC CONSTRUCTION CODE ARE LISTED IN THE FOLLOWING TABLES:

THE CONTRACTOR MUST NOTIFY THE ARCHITECT OR ENGINEER FOR SPECIAL INSPECTIONS AT LEAST 72 HOURS BEFORE THE SPECIFIC WORK COMMENCES.

THE "AUTHORITY" SHALL BE RESPONSIBLE FOR THE FOLLOWING SPECIAL INSPECTIONS:

MASONRY 1704.5 1704.32 POST-INSTALLED ANCHORS (BB#2014-018, 2014-019)

ABBREVIATIONS:

Α			1.1		
AB.	_	AB OVE	Н		
AcT.		ACOUSTICAL TILE	H.C.	-	HUNG CEILING
	_		HGT.	_	HEIGHT
A.D.	-	ACCESS DOOR	H.M.	_	
ADJ.	_	ADJAC ENT	HORIZ.	_	HORIZONTAL
A.F.F.	_	ABOVE FINISHED FLOOR	H.P.		HIGH POINT
A.F.G.	_	ABOVE FINISHED GRADE			
ALUM.	_	ALUMINUM	H.R.	_	HAND RAIL
			HR.	-	- HOUR
APP'D.	-	APPROVED			
ARCH.	_	ARC HITEC T			
AUD.	_	AUDITORIUM			INCIDE DIAMETED
AVG.	_	AVERAGE	I.D.	_	INSIDE DIAMETER
	_		I.G.	-	
@	-	AT	I.S.	_	INTERMEDIATE SCHOOL
			INSUL.	_	
В			114302.		114302/11014
BD.		– BOARD	1		
BLD'G		BUILDING	J		
			J.H.S.	-	JUNIOR HIGH SCHOOL
BM. B.O. B.O.C./B.C. B.O.W./B.W. BR					
B.0.	-		K		
B.O.C./B.C.	_	BOTTOM OF CURB	KP.	_	KICKPLATE
B.O.W./B.W.	_	BOTTOM OF WALL	Nr.	_	RICKFLAIL
BR.		– BRONZE			
B.S.			L		
	_	BRONZE SADDLE	L.	-	LEADER
B.S.&A.		 BOARD OF STANDARDS 	LAV.	_	LAVATORY
		AND APPEALS	LOCK		LOCKER
B.U.R.	_	BUILT UP ROOFING			
С			L.P.		- LOW POINT
		CADINET	L.S.		- LIMESTONE
CAB'T.	_		LT.	_	LIGHT
C.B.	_		L.W.	_	- LIGHT WEIGHT
CAFE.	_	CAFETERIA	L.W.C.	_	LIGHT WEIGHT CONCRETE
CEM'T.	_	CEMENT	L.W.O.		EIOITI WEIOITI OONOKETE
CL CL	_		М		
			M./MA./MTL.	_	METAL
C.I.		- CAST IRON	MAT.	_	MATERIAL
CLAD'G		- CLADDING			
C.J.	_	CONTROL JOINT	MAX.	-	
C.L./CLOS.		CLOSET	MECH.	-	MECHANICAL
C.J. C.L./CLOS. CL'G/CEIL'G	_	CEILING	M.F.	_	METAL FURRING
000,000		COLUMN	MIN.	_	
COL.	_		M.O.	_	
CORR.	-				
CONT/CONTIN.		CONTINUOUS	M.S.	-	METAL STRIP
CONC.	_	CONCRETE			
CONV	_	CONCRETE CONVECTOR CLASSROOM CERAMIC TILE	N		
CONV.		CLACCROOM	N.	_	NORTH
C.R.	_	CLASSROUM	N D		NOMINAL DIAMETED
С.Т.	_	CERAMIC TILE	N.D.	_	NOMINAL DIAMETER
			N.I.C.	-	NOT IN CONTRACT
D			NO./ #	-	NORTH NOMINAL DIAMETER NOT IN CONTRACT NUMBER NOMINAL NOT TO SCALE
UB \UICD BU		 DISPLAY BOARD DOUBLE DUST CHUTE DEPARTMENT OF ENVIRONMENTAL PROTECTION 	NOM.	_	NOMINAL
עם./עוטר. פע.		- DISPLAT DUARD	NTS	_	NOT TO SCALE
DBT.	_	DOORTE	11.1.5.		NOT TO SCALL
D.C.	_	DUST CHUTE			
D.E.P.	_	DEPARTMENT OF	O		
		FNVIRONMENTAL	O.C.	-	ON CENTER
		PROTECTION	O.D.	_	OUTSIDE DIAMETER
DECON		DECONTANINATION LINE	OFC	_	OFFICE
DECON.		- DECONTAMINATION UNIT	OB'C /OBEN'C		ON CENTER OUTSIDE DIAMETER OFFICE - OPENING
DEPT.	_	DEPARIMENT	OF G./ OPEN G.	_	- OPENING
DFE		 DESIGN FLOOD ELEVATION 	Р		
D.H.	_	DOUBLE HUNG	P PART. PERF. PL./PLAS. PL./PROP. LINE		DADTITION
DIA		DIAMETER	PARI.	_	PARTITION
DIM.		DIMENSION	PERF.	_	PERFORATED
DIM.	_	DIMENSION	PL./PLAS.	-	PLASTER
DISP.	_	DISPENSER	PL./PROP. LINE	_	PROPERTY LINE
DN.	_	DOWN	PNT	_	PAINT
D.O.S.	_	DEPARTMENT OF	D.T.		DDECCUDE TDEATED
		SANITATION	P.1.	_	PRESSURE IREATED
ND		DOOP	PI. C.B.	_	PAINTED CONCRETE
UN. DT: /DCT	_	DEPARTMENT OF ENVIRONMENTAL PROTECTION DECONTAMINATION UNIT DEPARTMENT DESIGN FLOOD ELEVATION DOUBLE HUNG DIAMETER DIMENSION DISPENSER DOWN DEPARTMENT OF SANITATION DOOR DETAIL DRAWING DEGREES			PAINT PRESSURE TREATED PAINTED CONCRETE BLOCK PUBLIC SCHOOL PAINTED
DIL./DET.	_	DETAIL	P.S.	_	PUBLIC SCHOOL
DWG./DRAW'G	_	DRAWING	PTD	_	DAINTEN
•	_	DETAIL DRAWING DEGREES	. ιυ.		DITIC UD MINITIC
E			工	_	PLUS OR MINUS
E.	_	EAST	_		
FJ /FYP IT	_	EXPANSION JOINT	R		
E. JEIEN/		FLEVATION	r.	_	RADIUS RADIATOR REFLECTED CEILING PLAN REFLECTED
LL./ LLEV.	_	ELECTRIC	RAD	_	RADIATOR
ELEU.	_	ELECTRIC	R C D	_	REFLECTED CELLING
ENCL.	-	ENCLOSURE	п.∪.г.	_	NEILLOILD GEILING
ENT.	_	ENTRANCE	555		PEEL FO TED
EQ.	_	EQUAL	KEFL.	_	KEFLECTED
FOLIIP	_	FOLUPMENT	REINF.		
EQUII.		ETO ETEDA	REQU'D/REO'D	_	REQUIRED
LIG.	_	LIGHTUAN	RFV	_	RFVFAI
EXP.	_	EAST EXPANSION JOINT ELEVATION ELECTRIC ENCLOSURE ENTRANCE EQUAL EQUIPMENT ETC ETERA EXPANSION — EXISTING	DI.		REQUIRED REVEAL ROOM ROUGH OPENING
EXIST./EXT'G./E	XG	EXISTING	ΓM.	_	NOUM
•			K.U.	_	ROUGH OPENING
F			RUB.	_	RUBBER
r F.		FIXED			
			S		
		FURRED CEILING	S.	_	SINK OR SOUTH
F.D./FL.DR.		FLOOR DRAIN	S.A.C.	_	SUSPENDED
FIN.		- FINISH	5		ACOUSTICAL CEILING
FIXT.	_	FIXTURE	CVD		
FL./FLR.	_	FLOOR	SAD.	_	SADDLE
			SCHED.	-	- SCHEDULE
FLASH'G.	_	FLASHING	SECT.	_	SECTION
F.P.	-	FIREPROOFING	SH./SHELV'G	_	0=
FR.	_	FRAME	SHT.	_	SHEET
F.T.		- FLUSH TREAD		_	
			SIM.	-	SIMILAR
F.V.S.	_	FLUSH VINYL	SL.	_	SLEEVE
		SADDLE	SP.	_	START POINT/SPACE
_			SPEC.	_	SPECIFICATION
G					
GA.	_	GAUGE	SQ.FT./S.F.	-	- SQUARE FEET
GALV.	_	GALVANIZED	S.S./ST. STL.	_	STAINLESS STEEL
			STF.	_	STAFF
GB.		- GLAZED BLOCK	STD.	_	STANDARD
G.C.	-	GENERAL CONTRACTOR	STL.	_	
G.I.	_	GALVANIZED IRON			
GL.	_	GLASS	ST.PL.	_	
GR.	_	GRILLE	STOR.	_	STORAGE
			STRUCT./STRU./	STRL	
GYP. BD./GWB.		- GYPSUM BOARD	STUD.	_	STUDENT
			\cup 1 \cup \cup .		0100E111

SOLDER


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SUB ST.


ABBREVIATIONS (cont):

Т		V	
T.	TOILET	V./VIN.	VINYL
T&B	 TOP AND BOTTOM 	V.C.T.	 VINYL COMPOSITION TILE
T.C./T.O.C.	 TOP OF COPING 	VENT.	VENTILATOR
TEL.	TELEPHONE	VERT.	VERTIC AL
TH.	THICKNESS	VEST.	VESTIBULE
T.H.W.N.	 THERMOPLASTIC 	V.I.F.	VERIFY IN FIELD
	POLYVINYLL CHOLRIDE		
	INSULATION WITH	W	
	NYLON JACKET	W.	WEST
T.L.	TEACHER'S LOCKER	W/	– WITH
T.O.S.	 TOP OF SLAB 	WARD	WARDROBE
TR	TREAD	WAINS.	WAINSC OT
T.W./T.O.W.	TOP OF WALL	W.C.	WATER CLOSET
TYP.	TYPICAL	WD.	WOOD
		W.H.	WEEPHOLE
U		W.I.	WROUGHT IRON
U.	UNFINISHED	W.P.	WATERPROOFING
U.O.N.	 UNLESS OTHERWISE 	WT.	WEIGHT
	NOTED		

DRAFTING SYMBOLS:

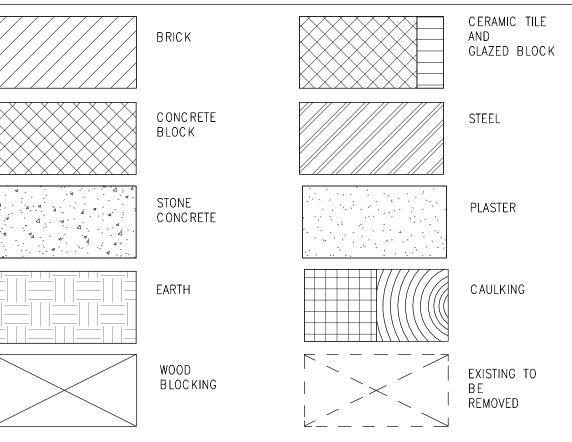

REFERENCE SYMBOLS:

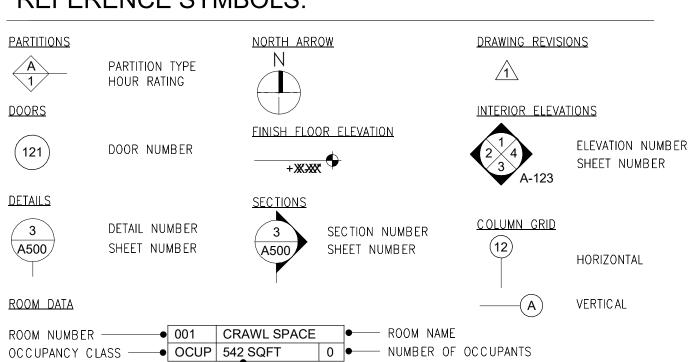

- NET SQUARE FOOTAGE

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Peter McCree

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Design Consultant Management Studio



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Ysrael A. Seinuk **Structural Consultant** 228 East 45th Street / New York, NY 10017 P 212.687.2233 / F 646.487.5555

NOTE: Drawing may be printed at reduced scale

IT IS A VIOLATION OF THE STATE EDUCATION LAW SECTION 7209 (2) FOR ANY PERSON TO ALTER AN ITEM IN ANY WAY UNLESS SUCH PERSON IS ACTING UNDER THE DIRECTION OF A LICENSED PROFESSIONAL ENGINEER, AND THE ENGINEER STAMPS SUCH CHANGES

05/09/2023 ISSUED FOR BID

No. Date Revision Key Plan: BARUCH PLACE 6 STORY BRICK BUILDING

> MANGIN STREET Lot # 25

NASER HAMOUDEH, P.E. SCA Design Manager: JEFFREY RABINER, PE Project Architect/Engineer: JOHN HIGGINS, PE Discipline Lead: GREGORY HERMAN Designer: G. HERMAN / M. VARONA Drawn by: JOHN HIGGINS, PE Checked by: Building ID: Design No or LLW Date:

BARD COLLEGE HS, MANHATTAN WASTE SYSTEM

M097

525 EAST HOUSTON STREET NEW YORK, NY 10002

Block # 325

D019998

GENERAL NOTES -ARCHITECTURAL


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Drawing No.: A001.00

> Sheets in Contract Set: 8 of 42

> > Sheets in DOB Set: 5 of 37

05/09/2023

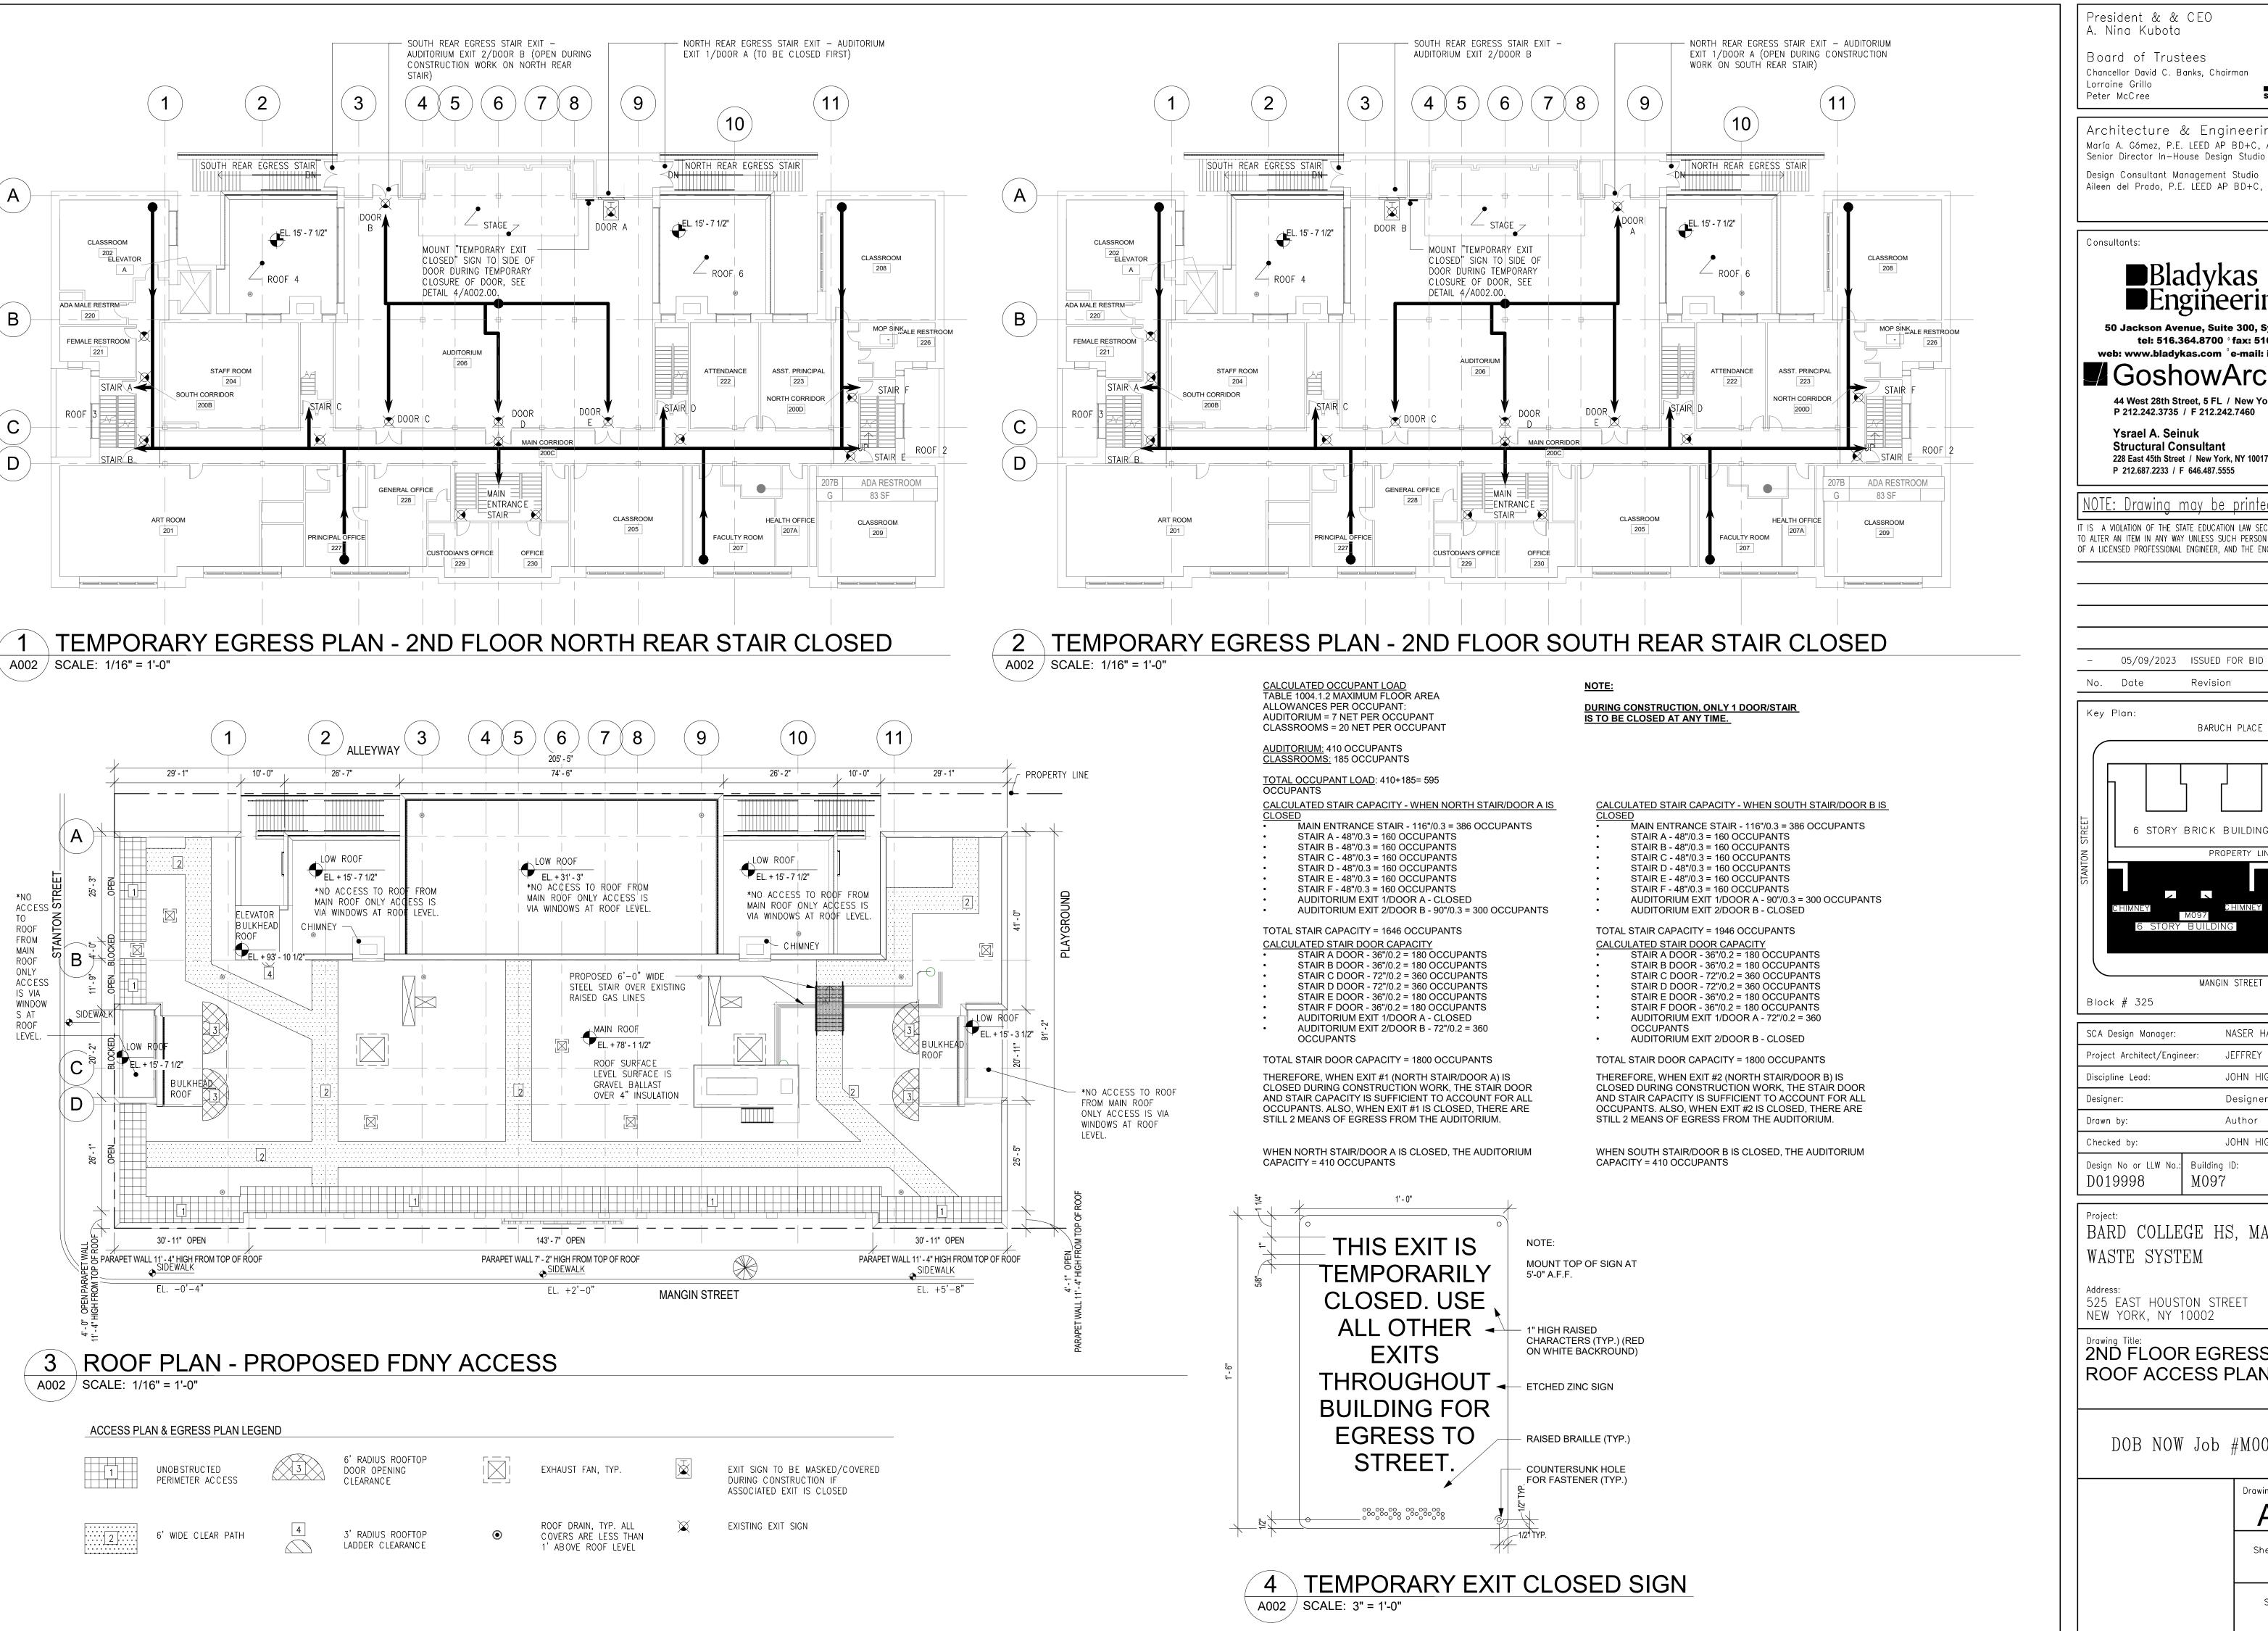

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Key Plan: BARUCH PLACE 6 STORY BRICK BUILDING

Block # 325

MANGIN STREET Lot # 25

	SCA Design Manager:	NASER HAM	OUDEH, P.E.	
	Project Architect/Engine	eer: JEFFREY RA	JEFFREY RABINER, PE	
	Discipline Lead:	JOHN HIGG	NS, PE	
	Designer:	Designer		
	Drawn by:	Author		
	Checked by:	JOHN HIGG	NS, PE	
ſ	Design No or LLW No.:	Building ID:	Date:	

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525 EAST HOUSTON STREET NEW YORK, NY 10002

2ND FLOOR EGRESS PLAN & ROOF ACCESS PLAN


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Drawing No.: A002.00

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05/09/2023 ISSUED FOR BID

 \bigotimes N BARUCH PLACE 6 STORY BRICK BUILDING

Lot # 25 NASER HAMOUDEH, P.E. JEFFREY RABINER, PE Project Architect/Engineer: JOHN HIGGINS, PE GREGORY HERMAN G. HERMAN / M. VARONA

MANGIN STREET

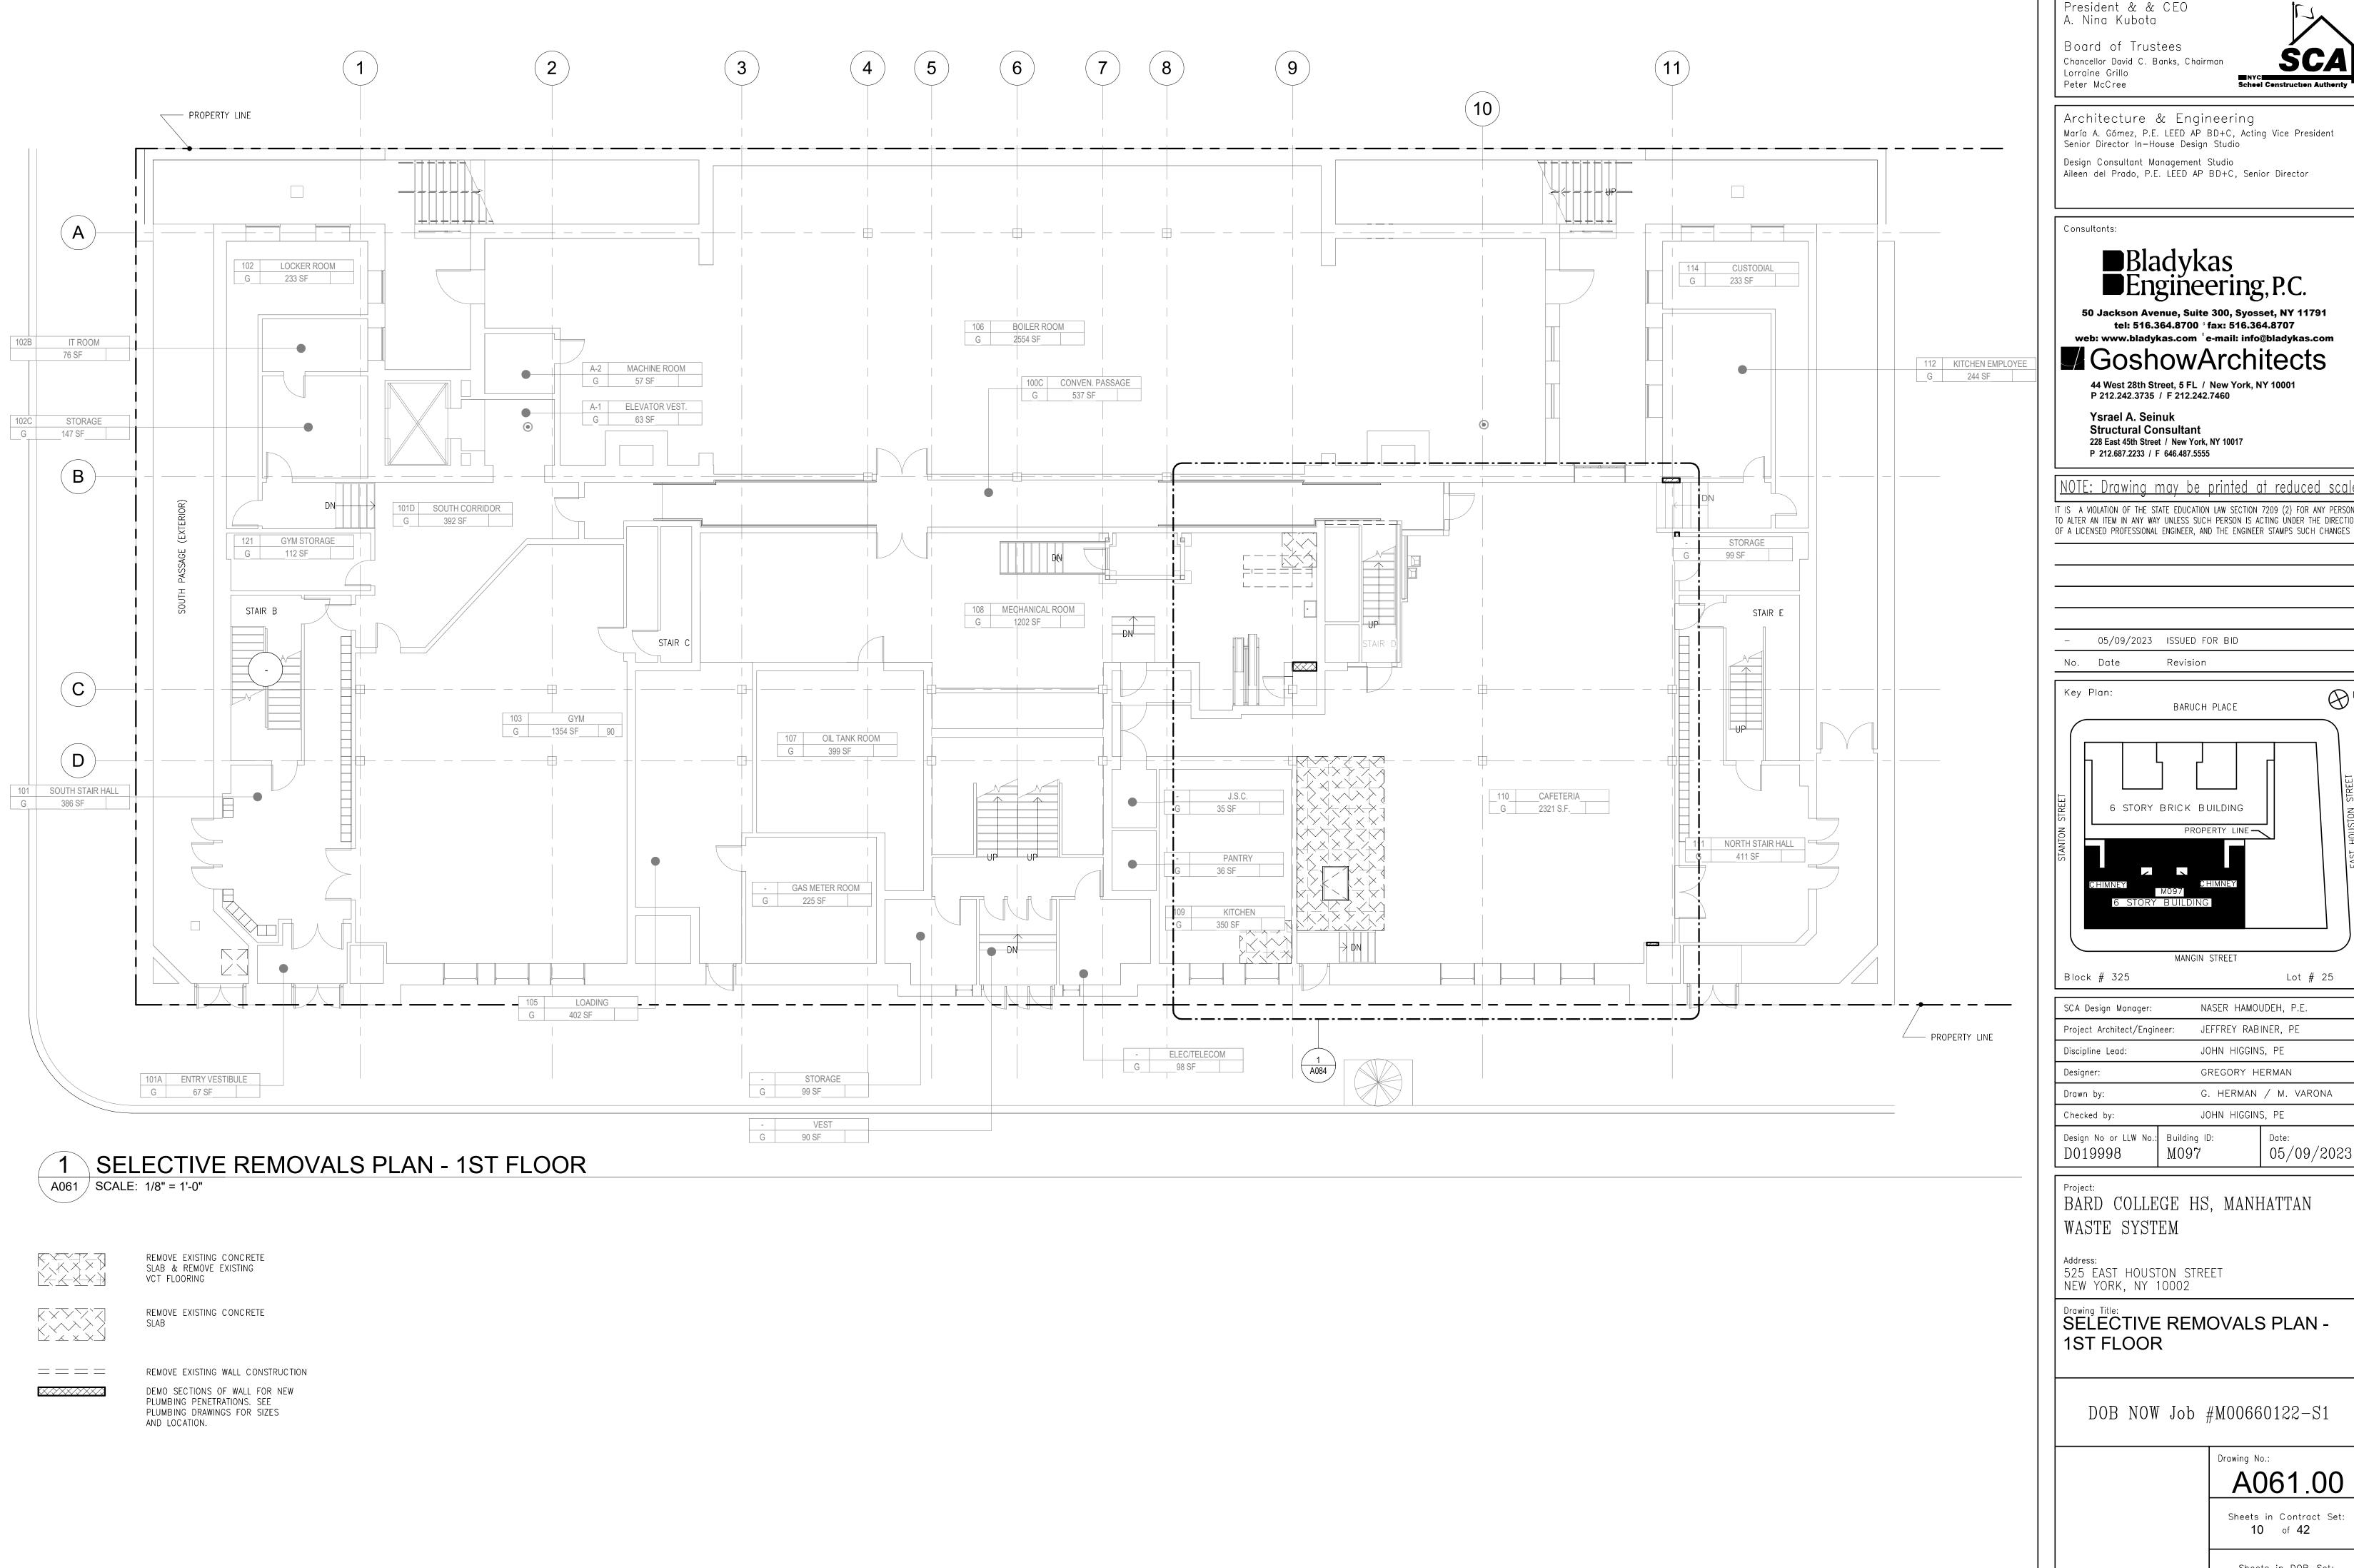JOHN HIGGINS, PE Building ID: Date: M097 05/09/2023

BARD COLLEGE HS, MANHATTAN WASTE SYSTEM

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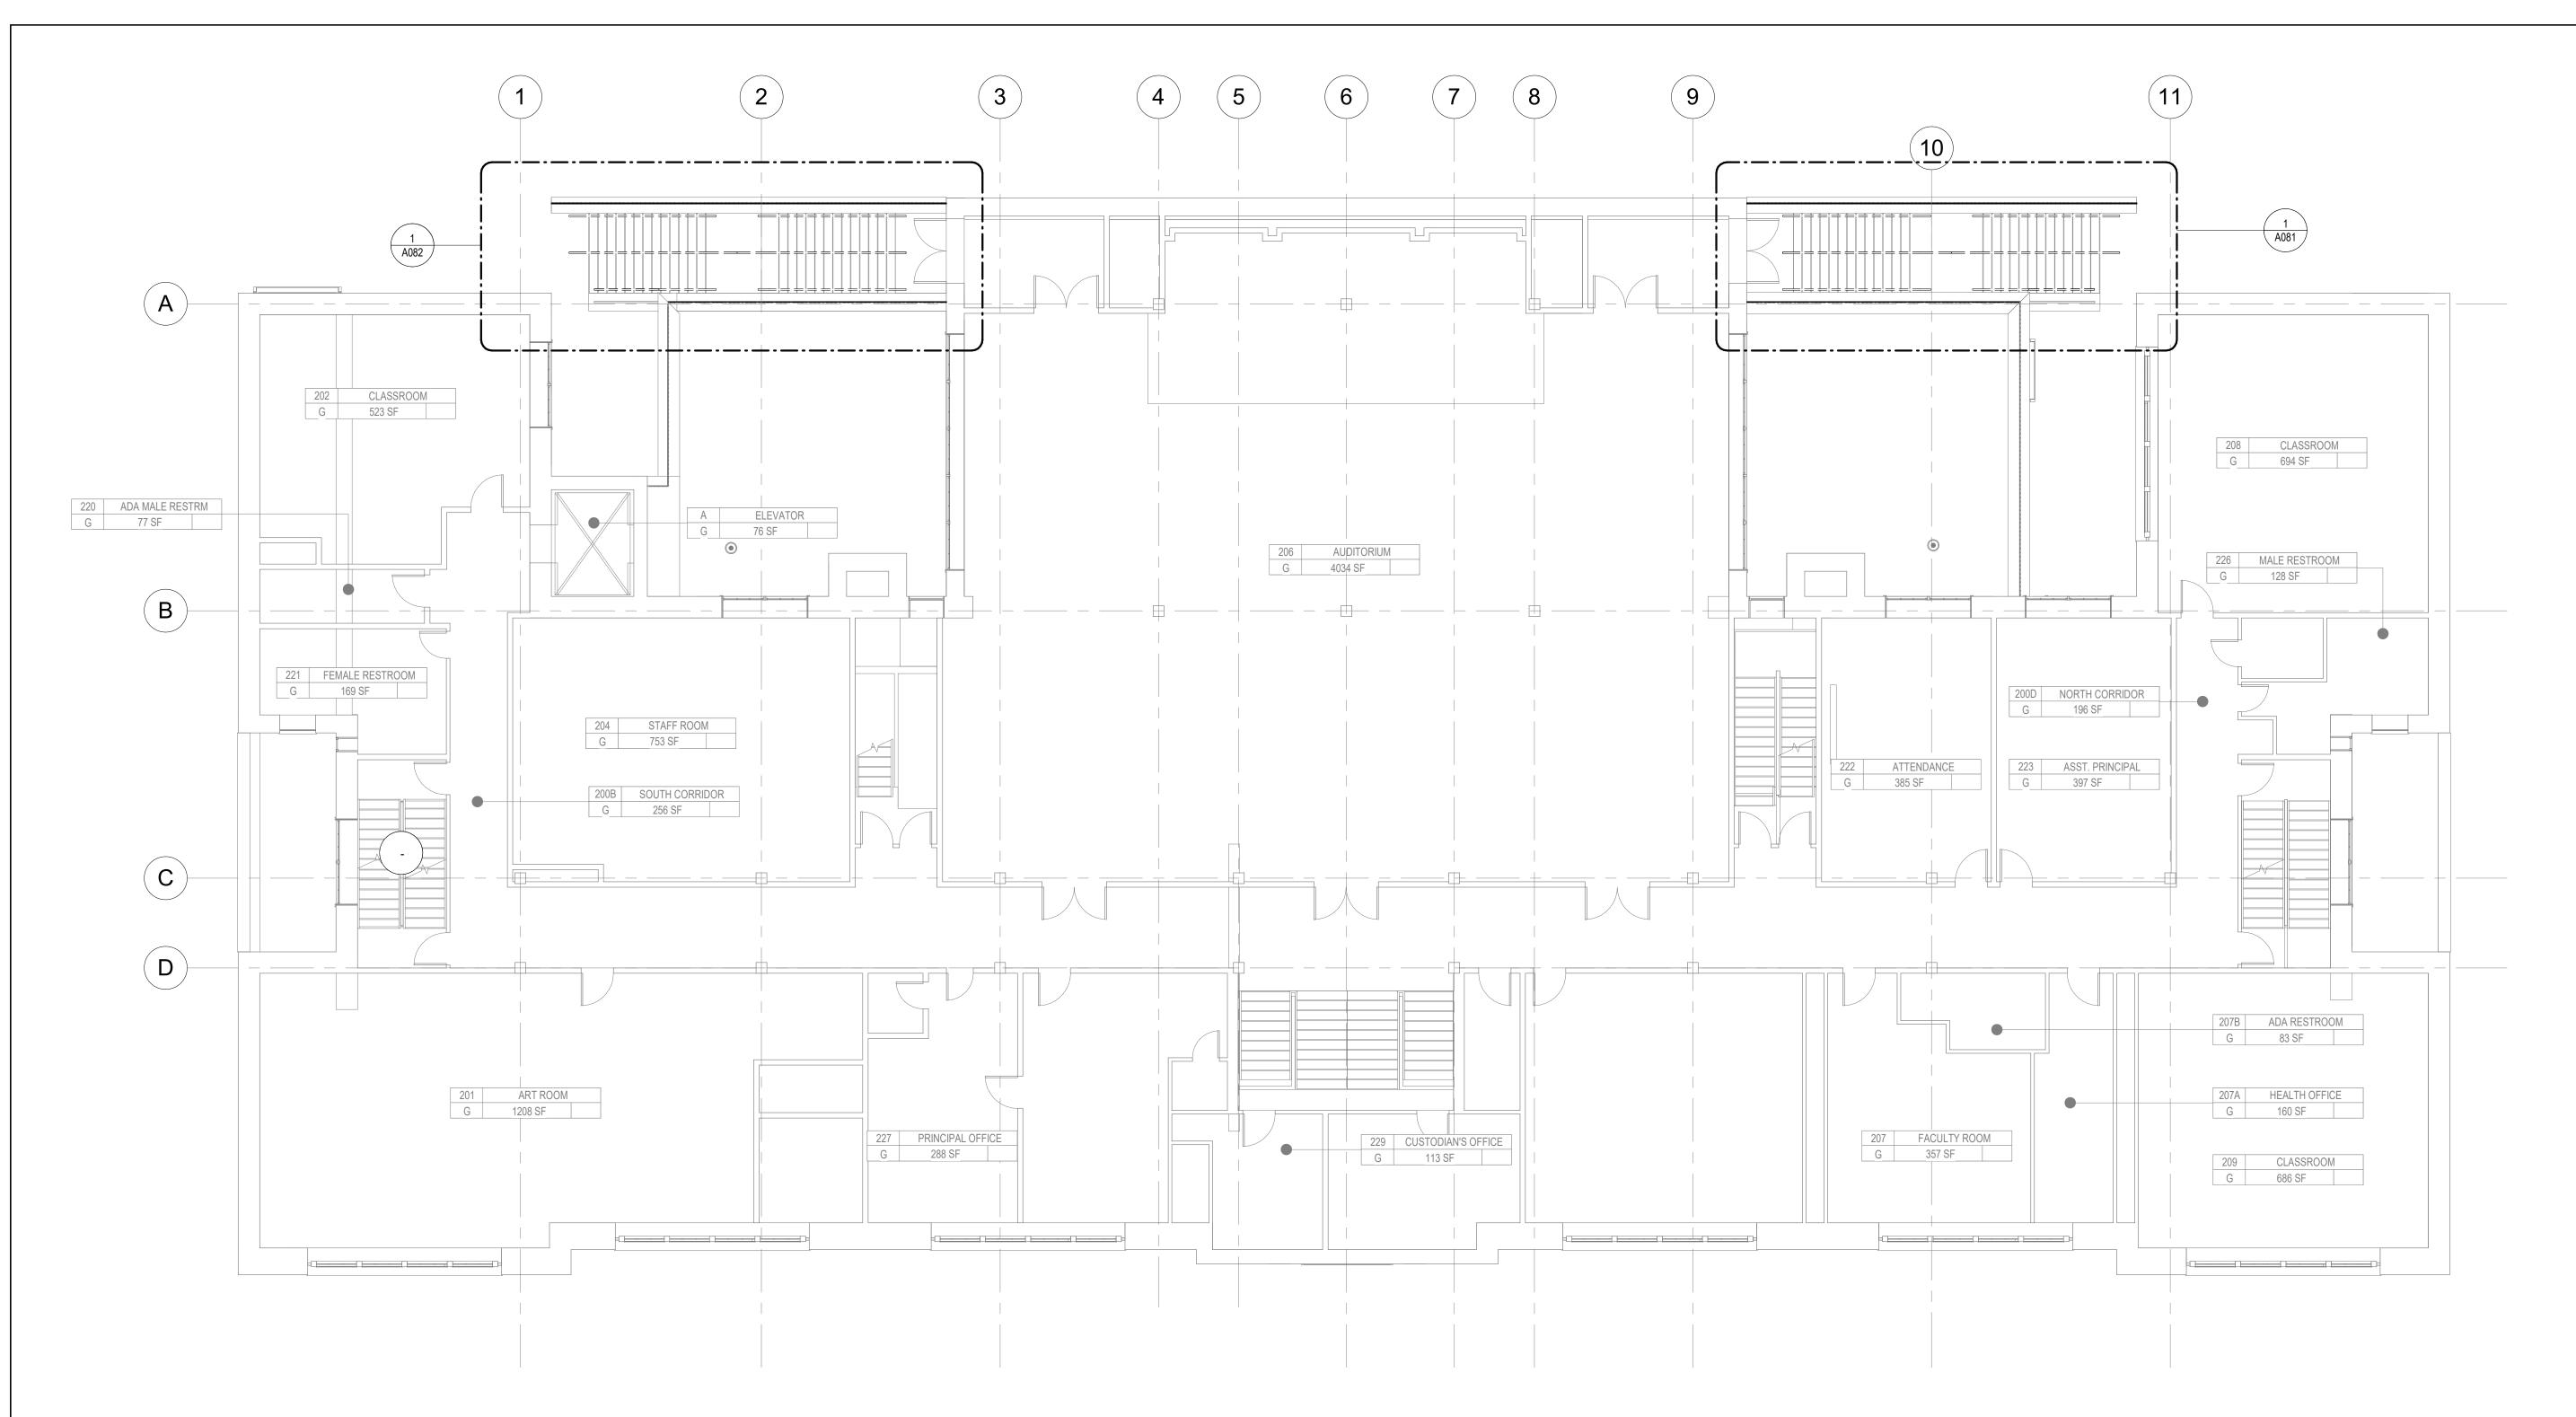
SELECTIVE REMOVALS PLAN -

DOB NOW Job #M00660122-S1

Drawing No.: A061.00

> Sheets in Contract Set: 10 of 42

Sheets in DOB Set: **7** of **37**



2 SELECTIVE REMOVALS PLAN - 2ND FLOOR
A062 SCALE: 1/8" = 1'-0"

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Consulta

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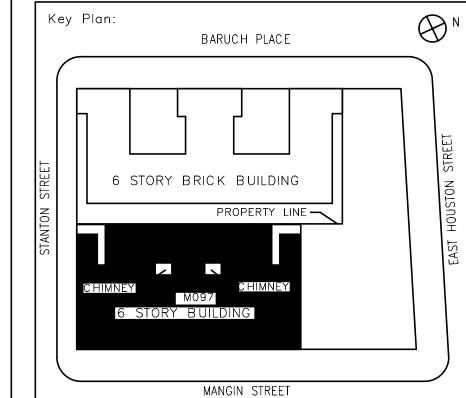
Ysrael A. Seinuk Structural Consultant 228 East 45th Street / New York, NY 10017 P 212.687.2233 / F 646.487.5555

NOTE: Drawing may be printed at reduced scale

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- 05/09/2023 ISSUED FOR BID

No. Date Revision



M. Block # 325

Lot # 25

Date:

05/09/2023

SCA Design Manager:	NASER HAMOUDEH, P.E.	
Project Architect/Engineer:	JEFFREY RABINER, PE	
Discipline Lead:	JOHN HIGGINS, PE	
Designer:	GREGORY HERMAN	
Drawn by:	G. HERMAN / M. VARONA	
Checked by:	JOHN HIGGINS, PE	

BARD COLLEGE HS, MANHATTAN
WASTE SYSTEM

M097

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Design No or LLW No.: Building ID:


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Drawing Title:
SELECTIVE REMOVALS PLAN 2ND FLOOR

DOB NOW Job #M00660122-S1

Drawing No.:
A062.00

Sheets in Contract Set:
11 of 42

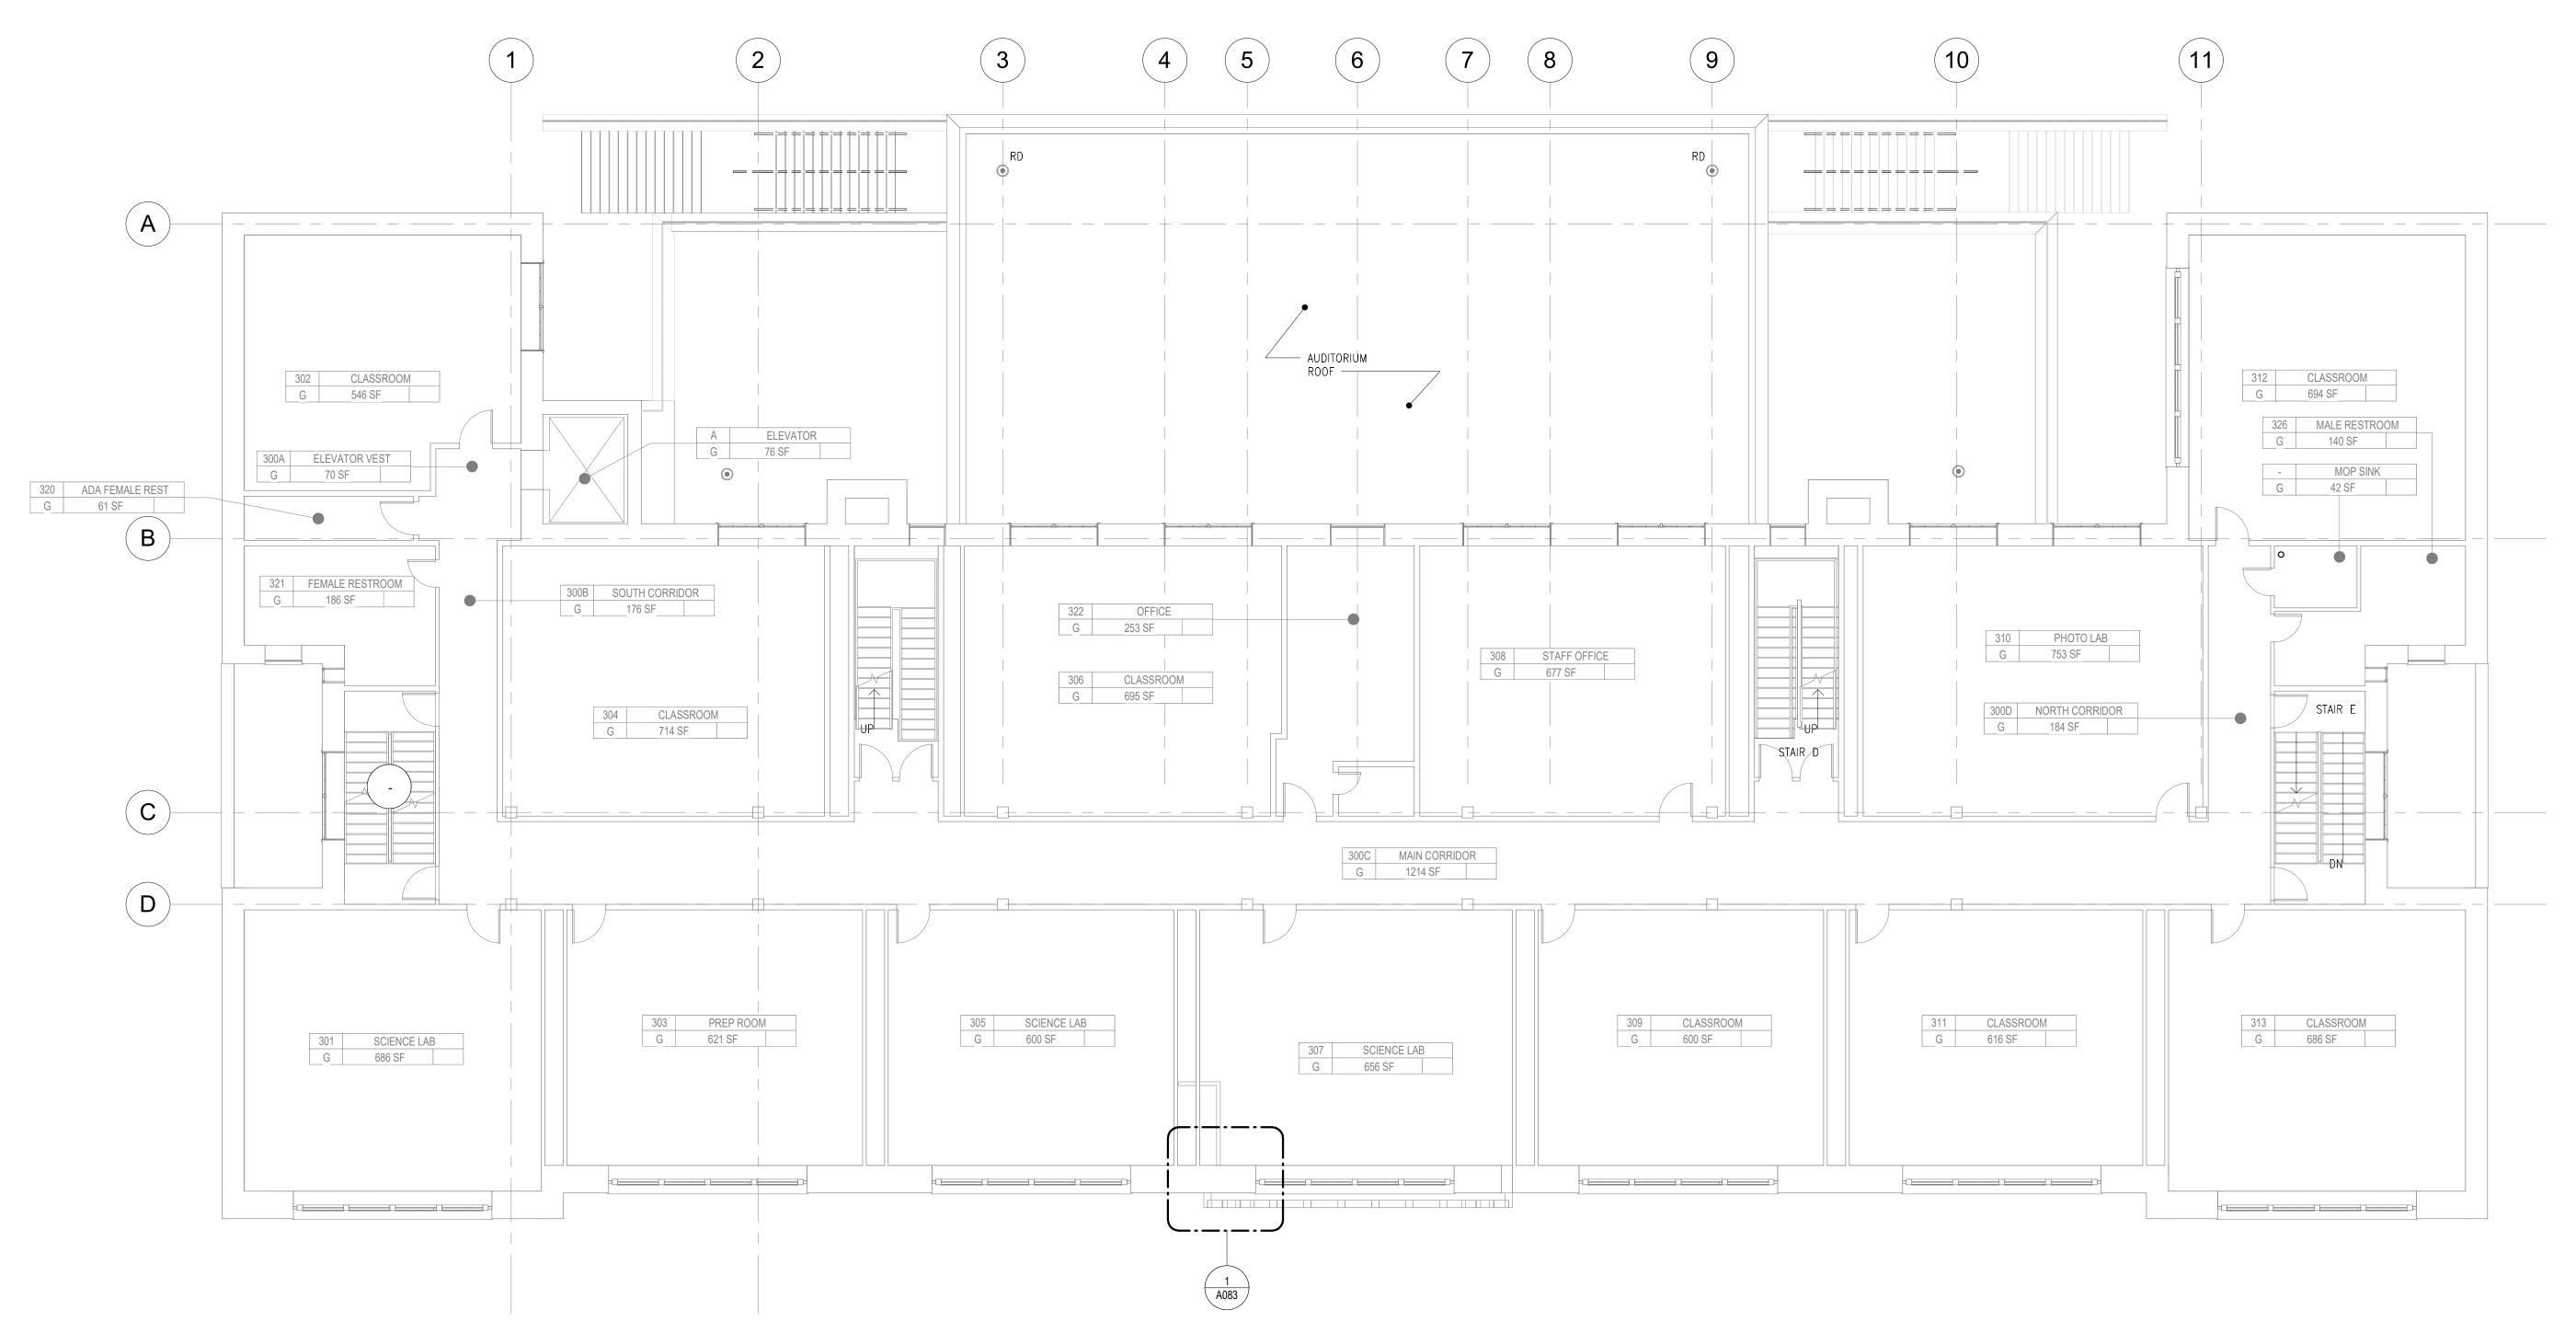

SELECTIVE REMOVALS PLAN - 3RD FLOOR

A063 | SCALE: 1/8" = 1'-0"

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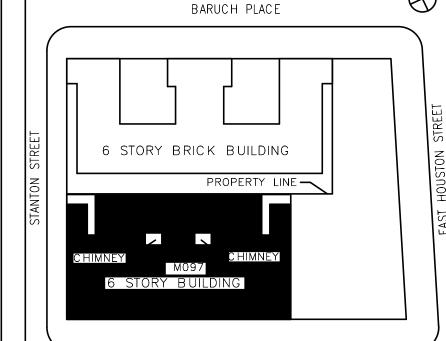
Ysrael A. Seinuk **Structural Consultant** 228 East 45th Street / New York, NY 10017 P 212.687.2233 / F 646.487.5555

NOTE: Drawing may be printed at reduced scale

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05/09/2023 ISSUED FOR BID No. Date Revision

Key Plan:



MANGIN STREET

Block # 325

NASER HAMOUDEH, P.E. SCA Design Manager: JEFFREY RABINER, PE Project Architect/Engineer: JOHN HIGGINS, PE GREGORY HERMAN G. HERMAN / M. VARONA

Lot # 25

JOHN HIGGINS, PE Checked by: Date: Design No or LLW .: Building ID: M097 D019998 05/09/2023

BARD COLLEGE HS, MANHATTAN WASTE SYSTEM

Address: 525 EAST HOUSTON STREET NEW YORK, NY 10002


Drawing Title:
SELECTIVE REMOVALS PLAN -3RD FLOOR

DOB NOW Job #M00660122-S1

Drawing No.: A063.00

Sheets in DOB Set: 9 of **37**

Sheets in Contract Set: **12** of **42**

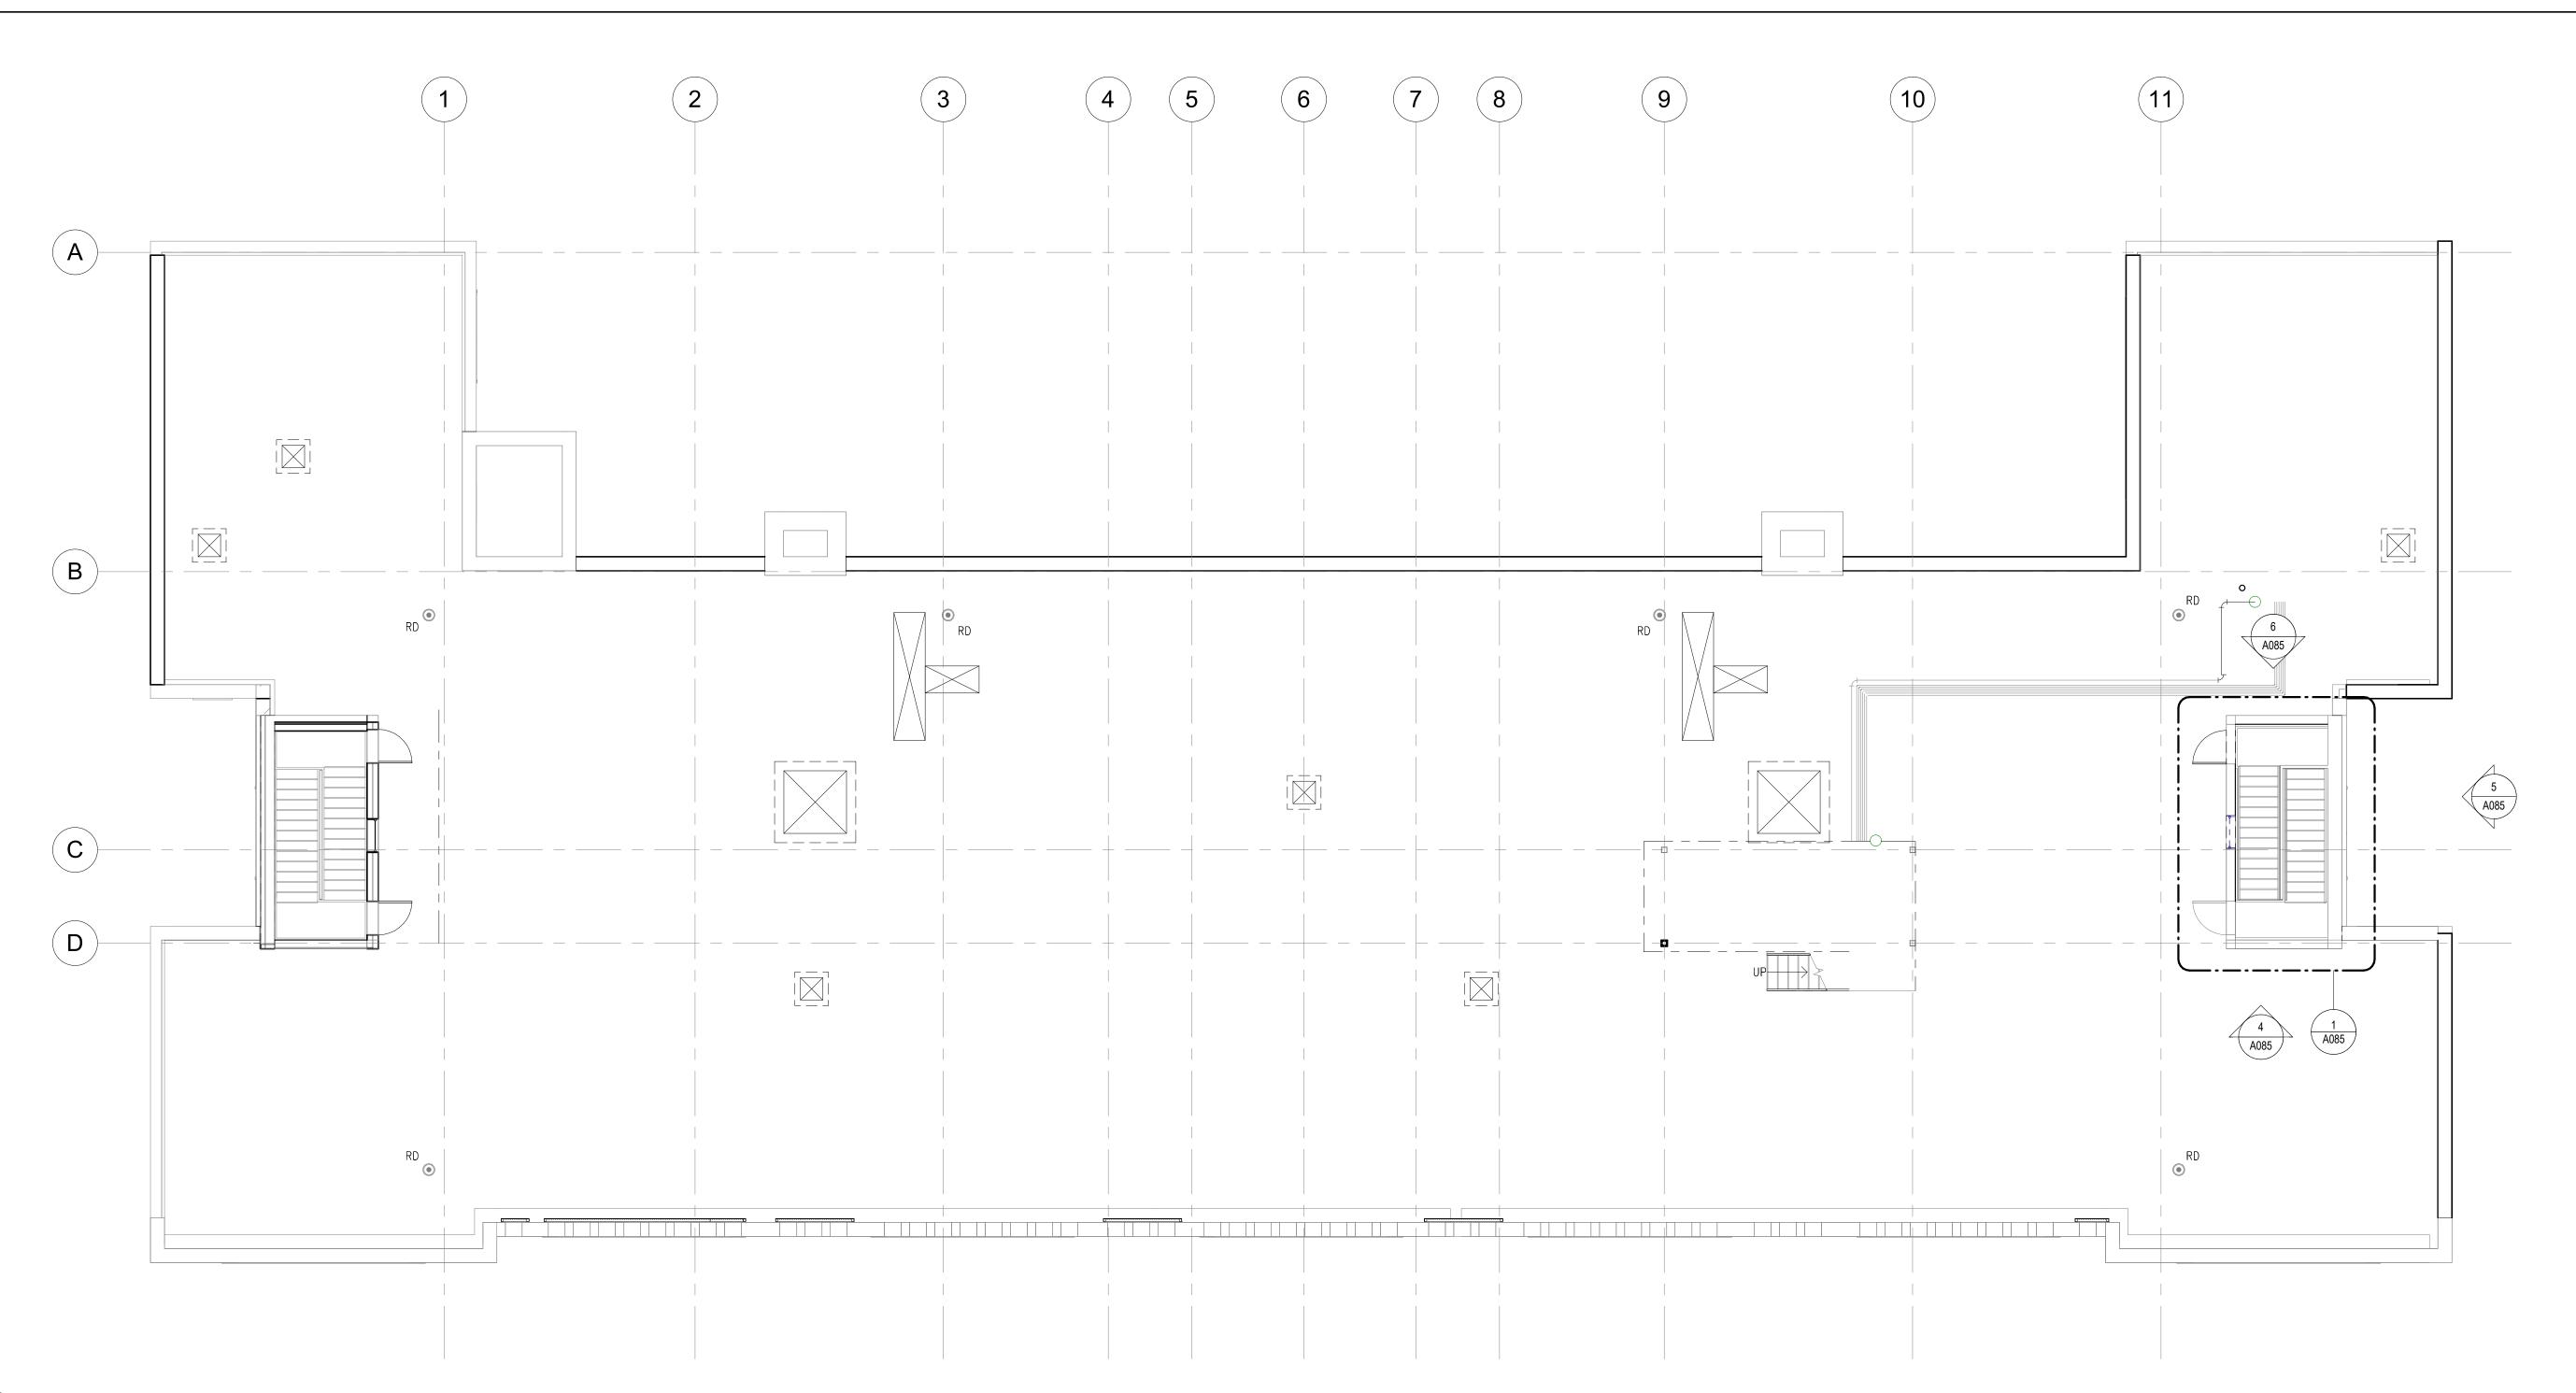

1 SELECTIVE REMOVALS PLAN - ROOF

A064 | SCALE: 1/8" = 1'-0"

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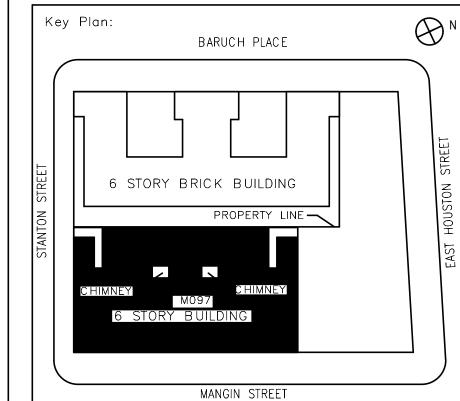
Ysrael A. Seinuk Structural Consultant 228 East 45th Street / New York, NY 10017 P 212.687.2233 / F 646.487.5555

NOTE: Drawing may be printed at reduced scale

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No. Date Revision



Block # 325

NASER HAMOUDEH, P.E. SCA Design Manager: JEFFREY RABINER, PE Project Architect/Engineer: JOHN HIGGINS, PE Discipline Lead: GREGORY HERMAN

JOHN HIGGINS, PE Checked by: Design No or LLW N o.: Building ID: Date: M097 D019998 05/09/2023

BARD COLLEGE HS, MANHATTAN WASTE SYSTEM

Address: 525 EAST HOUSTON STREET NEW YORK, NY 10002

Drawing Title:
SELECTIVE REMOVALS PLAN -ROOF

DOB NOW Job #M00660122-S1

Drawing No.:


Sheets in Contract Set:

Sheets in DOB Set: 10 of 37

A064.00 **13** of **42**

Lot # 25

G. HERMAN / M. VARONA

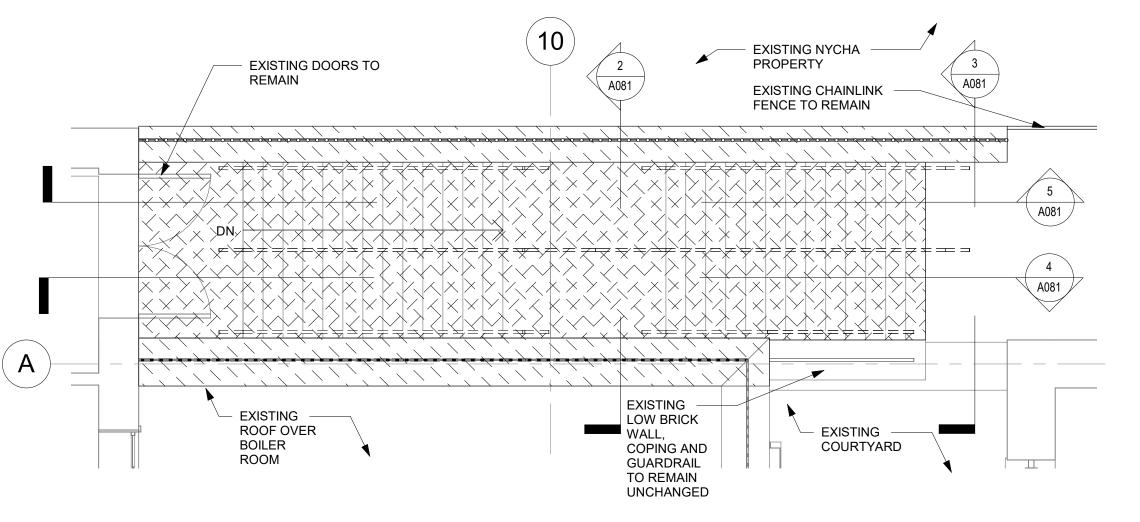

NORTH EGRESS STAIR SELECTIVE REMOVALS PLAN A081 / SCALE: 1/4" = 1'-0"

DEMO PLAN LEGEND REMOVE EXISTING STONE COPING SCARIFY CONCRETE = = =REMOVE EXISTING HANDRAILS REMOVE EXISTING WROUGHT IRON FENCE AND STORE FOR REPAINTING AND

REPAIRS

DEMO ELEVATION LEGEND **DEMO KEYNOTES** REMOVE EXISTING FACE BRICK REMOVE EXISTING WROUGHT IRON FENCE AND STORE FOR REPAINTING AND REPAIRS REMOVE EXISTING STONE COPING REMOVE EXISTING STONE REMOVE EXISTING SCARIFY CONCRETE HANDRAILS REMOVE EXISTING FACE SCARIFY CONCRETE LANDINGS, TREADS AND RISERS OF STAIRCASE

A081 / **EXISTING DOORS TO** REMAIN SECOND FLOOR (22.22' EXISTING NYCHA PROPERTY EXISTING UNOCCUPIED SPACE FIRST FLOOR (6.60' NAVD)

NORTH EGRESS STAIR SELECTIVE REMOVALS SECTION 1 SCALE: 1/4" = 1'-0"


SECTION OF RAILING TO REMAIN A081 / A081 UNCHANGED SECOND FLOOR (22.22' — EXISTING WALL TO REMAIN UNCHANGED - EXISTING -NYCHA PROPERTY **EXISTING** LOW BRICK WALL, COPING AND **GUARDRAIL** TO REMAIN UNCHANGED DFE (12.00' NAVD) 5' - 5" FIRST FLOOR (6.60' NAVD)

EXISTING

NORTH EGRESS STAIR SELECTIVE REMOVALS SECTION 2 A081 / SCALE: 1/4" = 1'-0"

3 A081 INACCESSIBLE CAVITY SPACE DFE (12.00' NAVD) EXISTING LOW EXISTING UNOCCUPIED **EXISTING** BRICK WALL, UNOCCUPIED COPING AND SPACE -SPACE ---GUARDRAIL TO REMAIN UNC HANGED

4 NORTH EGRESS STAIR SELECTIVE REMOVALS SECTION 3

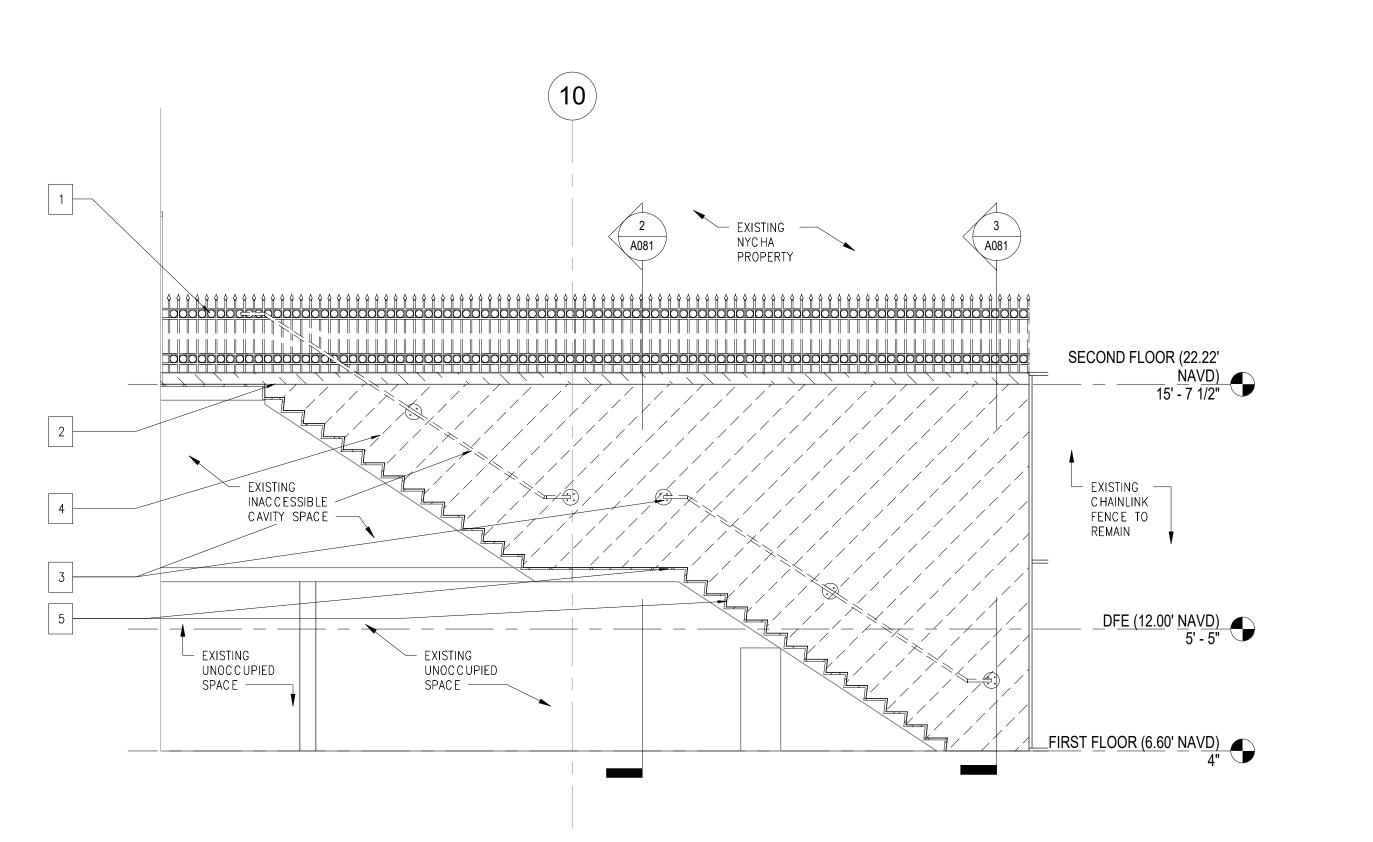

5 NORTH EGRESS STAIR SELECTIVE REMOVALS SECTION 4

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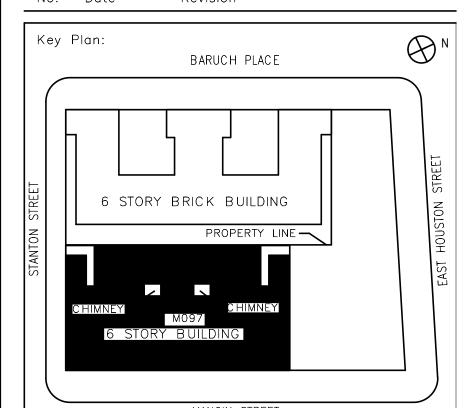
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NOTE: Drawing may be printed at reduced scale

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MANGIN STREET Lot # 25 NASER HAMOUDEH, P.E. SCA Design Manager

JEFFREY RABINER, PE Project Architect/Engineer JOHN HIGGINS, PE Discipline Lead: GREGORY HERMAN G. HERMAN / M. VARONA Drawn by:

JOHN HIGGINS, PE Checked by: Design No or LLW Building ID: Date: M097 05/09/2023 D019998

BARD COLLEGE HS, MANHATTAN WASTE SYSTEM

525 EAST HOUSTON STREET NEW YORK, NY 10002

Block # 325


NORTH REAR EGRESS STAIR SELECTIVE DEMOLITION

DOB NOW Job #M00660122-S1

Drawing No.: A081.00

> Sheets in Contract Set: **14** of **42**

Sheets in DOB Set: **11** of **37**

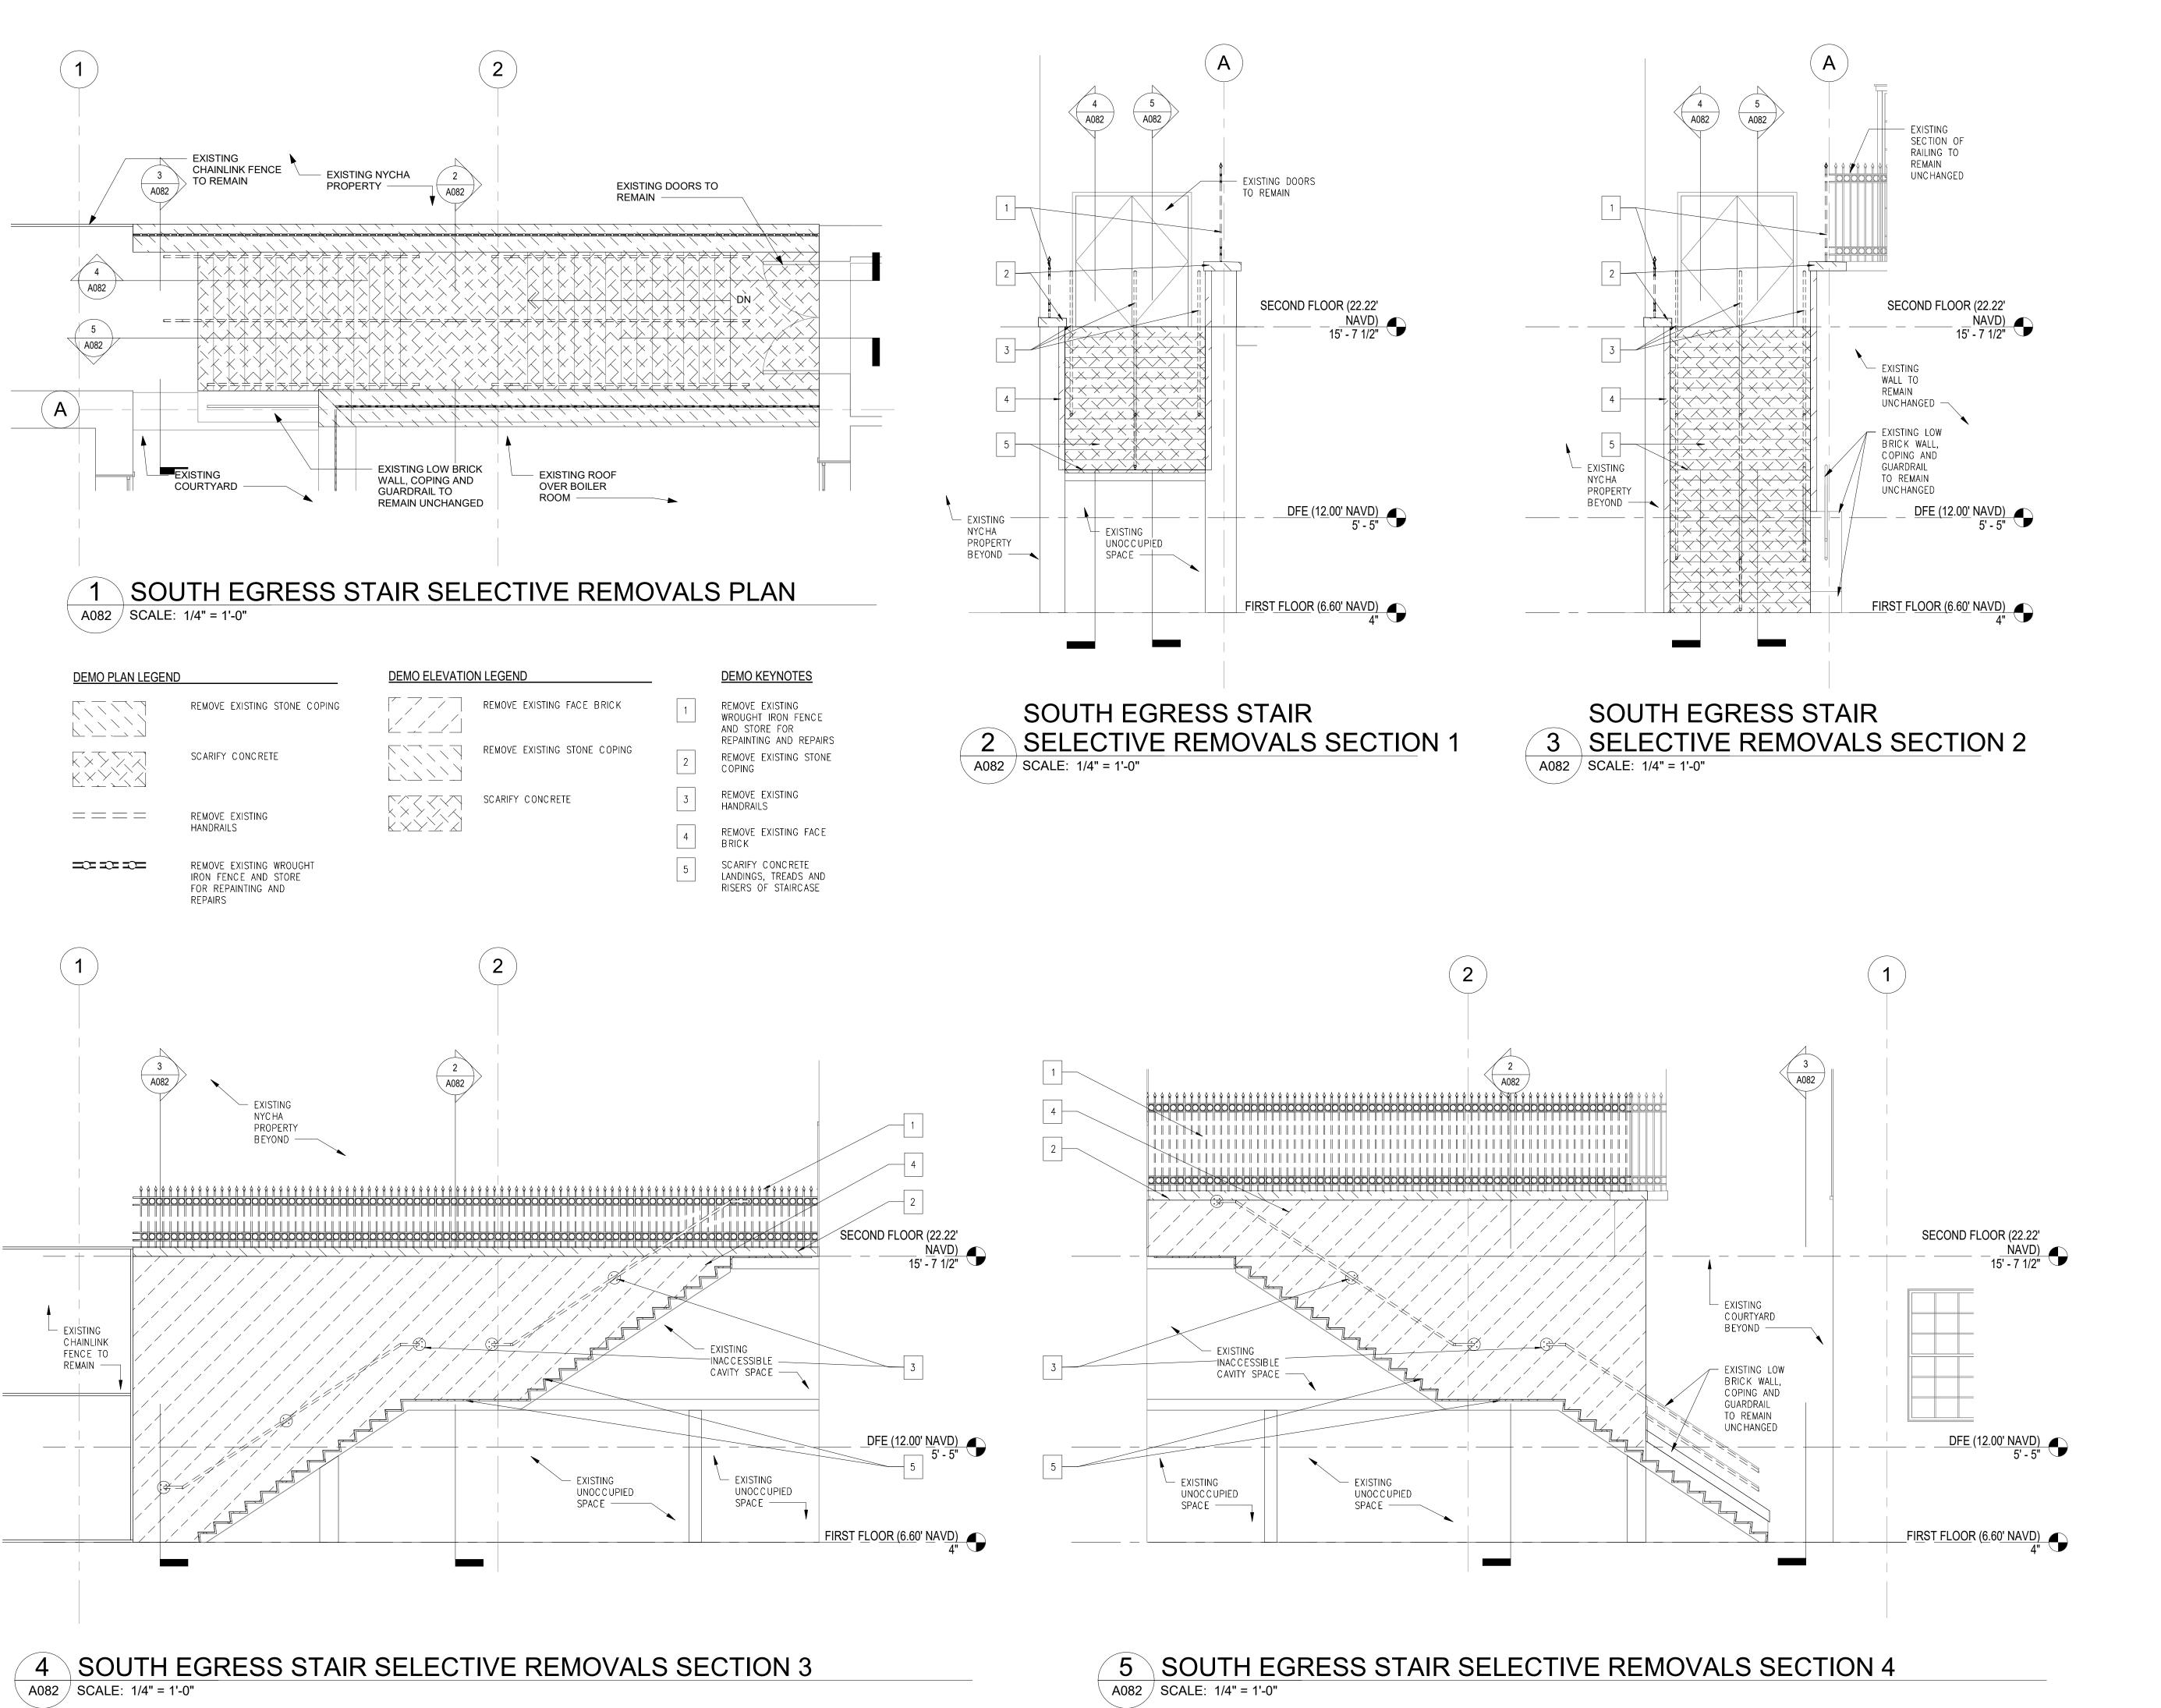

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STANTON STREET

BARUCH PLACE

6 STORY BRICK BUILDING

PROPERTY LINE

CHIMNEY

M097

6 STORY BUILDING

Block # 325

Lot # 25

SCA Design Manager:

NASER HAMOUDEH, P.E.

Project Architect/Engineer:

JEFFREY RABINER, PE

Discipline Lead:

JOHN HIGGINS, PE

Designer:

GREGORY HERMAN

Drawn by:

G. HERMAN / M. VARONA

MANGIN STREET

Checked by: JOHN HIGGINS, PE

Design No or LLW No.: Building ID: Date: 05/09/2023

BARD COLLEGE HS, MANHATTAN
WASTE SYSTEM


Address: 525 EAST HOUSTON STREET NEW YORK, NY 10002

SOUTH REAR EGRESS STAIR
SELECTIVE DEMOLITION

DOB NOW Job #M00660122-S1


Drawing No.: A082.00

Sheets in Contract Set: 15 of 42

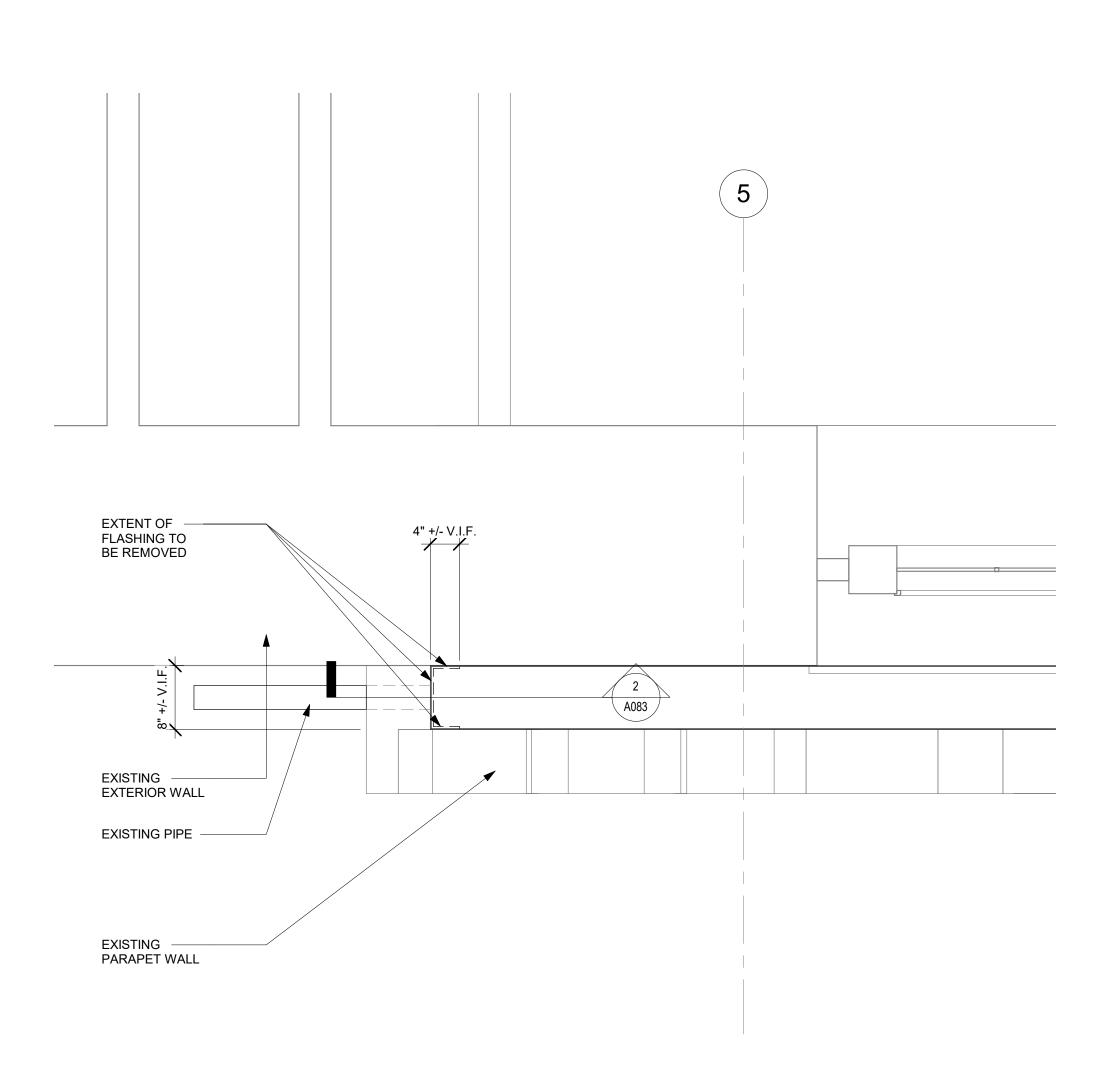

1 MAIN ENTRANCE BALCONY SELECTIVE REMOVALS PLAN

A083 SCALE: 1" = 1'-0"

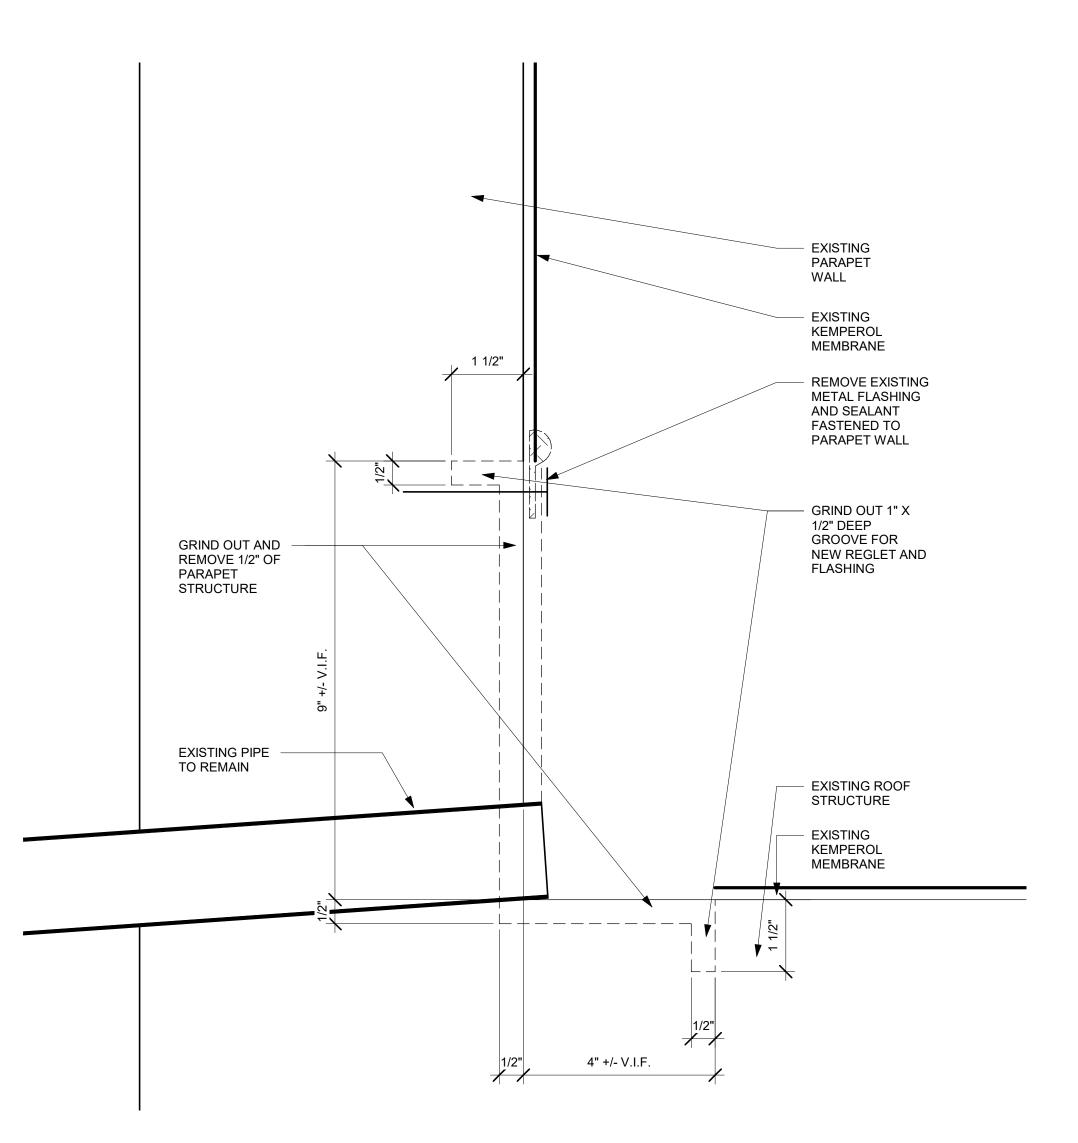

SECTION THROUGH MAIN ENTRANCE PARAPET

WALL SELECTIVE DEMOLITION

SCALE: 6" = 1'-0"

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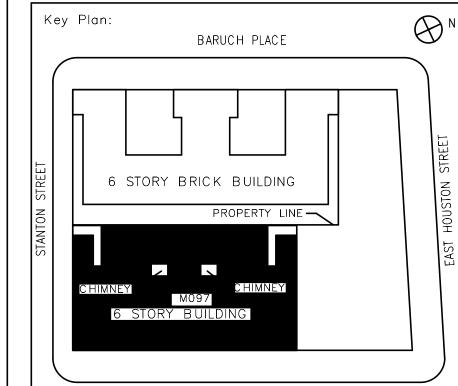
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MANGIN STREET

Block # 325

SCA Design Manager:

NASER HAMOUDEH, P.E.

Project Architect/Engineer:

JEFFREY RABINER, PE

Discipline Lead:

JOHN HIGGINS, PE

Designer:

GREGORY HERMAN

Drawn by:

Checked by:

Design No or LLW No.:

D019998

G. HERMAN / M. VARONA

JOHN HIGGINS, PE

Date:

05/09/2023

BARD COLLEGE HS, MANHATTAN
WASTE SYSTEM

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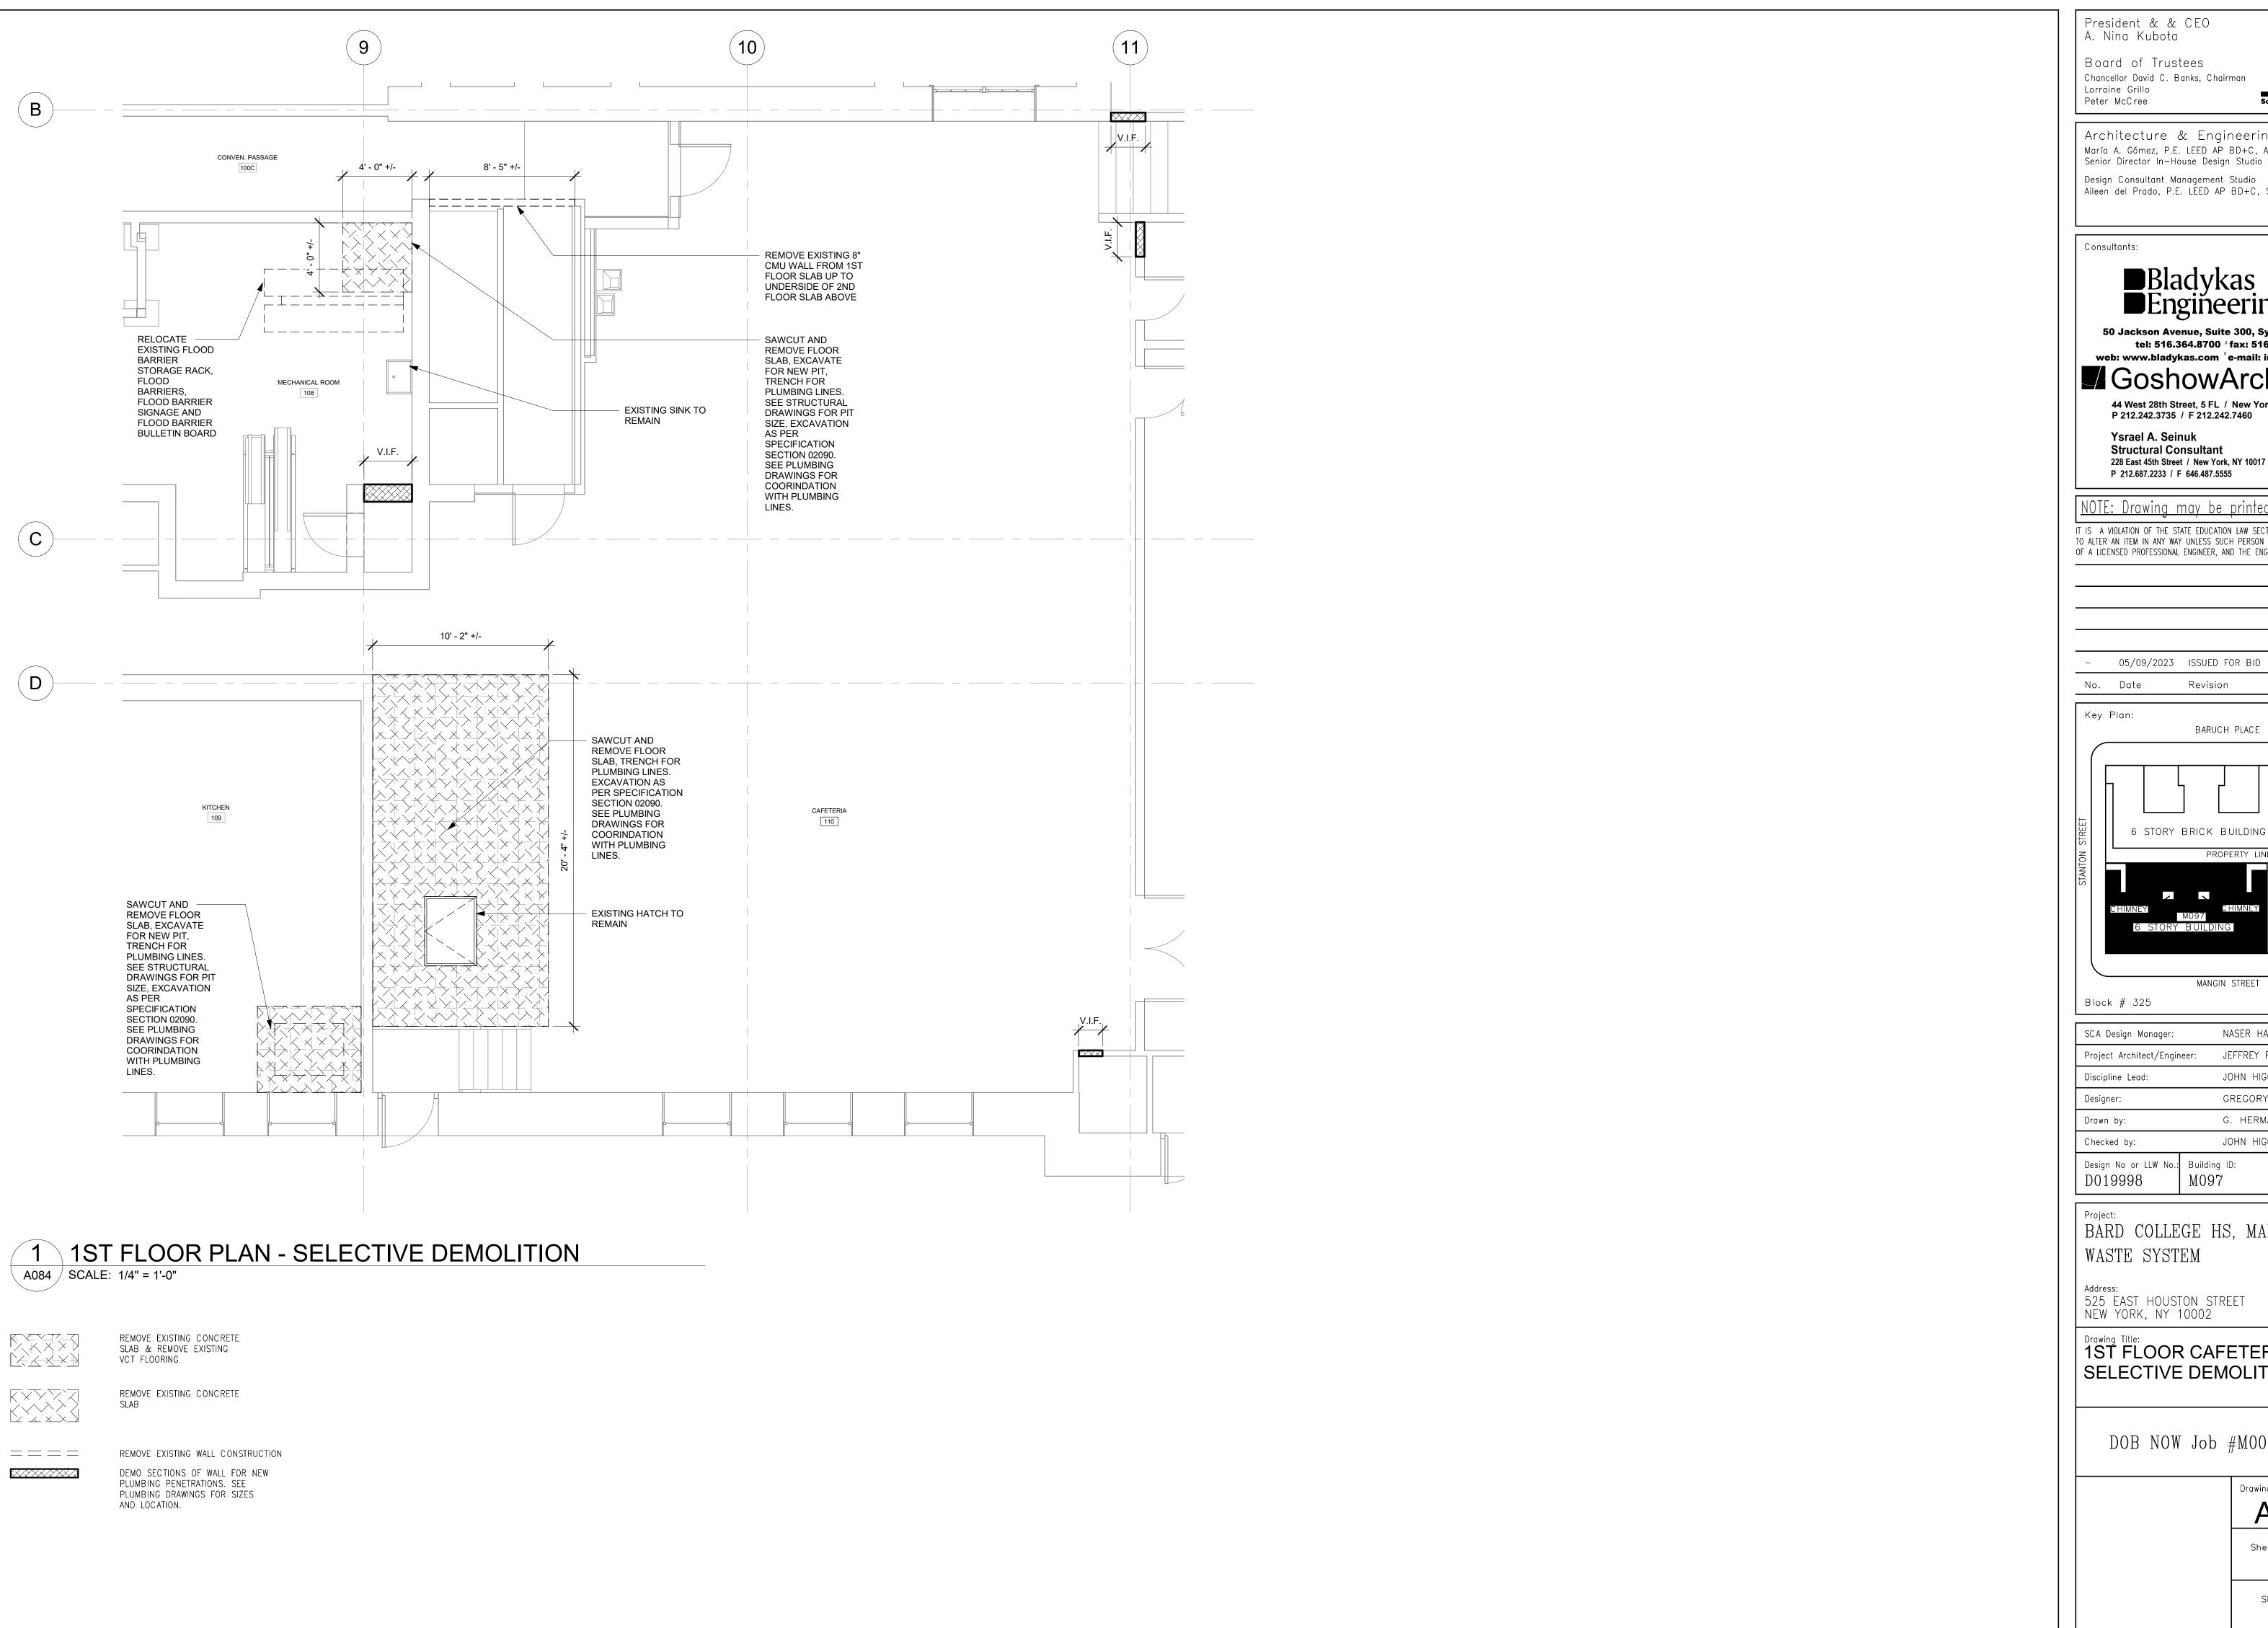
Drawing Title:
MAIN ENTRANCE BALCONY
SELECTIVE DEMOLITION

DOB NOW Job #M00660122-S1

Drawing No.:
A083.00

Sheets in Contract Set:

16 of 42



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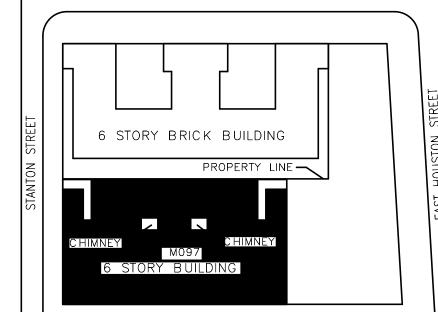
Structural Consultant 228 East 45th Street / New York, NY 10017

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Revision

BARUCH PLACE



MANGIN STREET

NASER HAMOUDEH, P.E. Project Architect/Engineer: JEFFREY RABINER, PE JOHN HIGGINS, PE GREGORY HERMAN G. HERMAN / M. VARONA

Lot # 25

JOHN HIGGINS, PE Building ID: Date: M09705/09/2023

BARD COLLEGE HS, MANHATTAN WASTE SYSTEM

525 EAST HOUSTON STREET NEW YORK, NY 10002


1ST FLOOR CAFETERIA SLAB SELECTIVE DEMOLITION

DOB NOW Job #M00660122-S1

Drawing No.: A084.00

Sheets in Contract Set: **17** of **42**

> Sheets in DOB Set: **14** of **37**

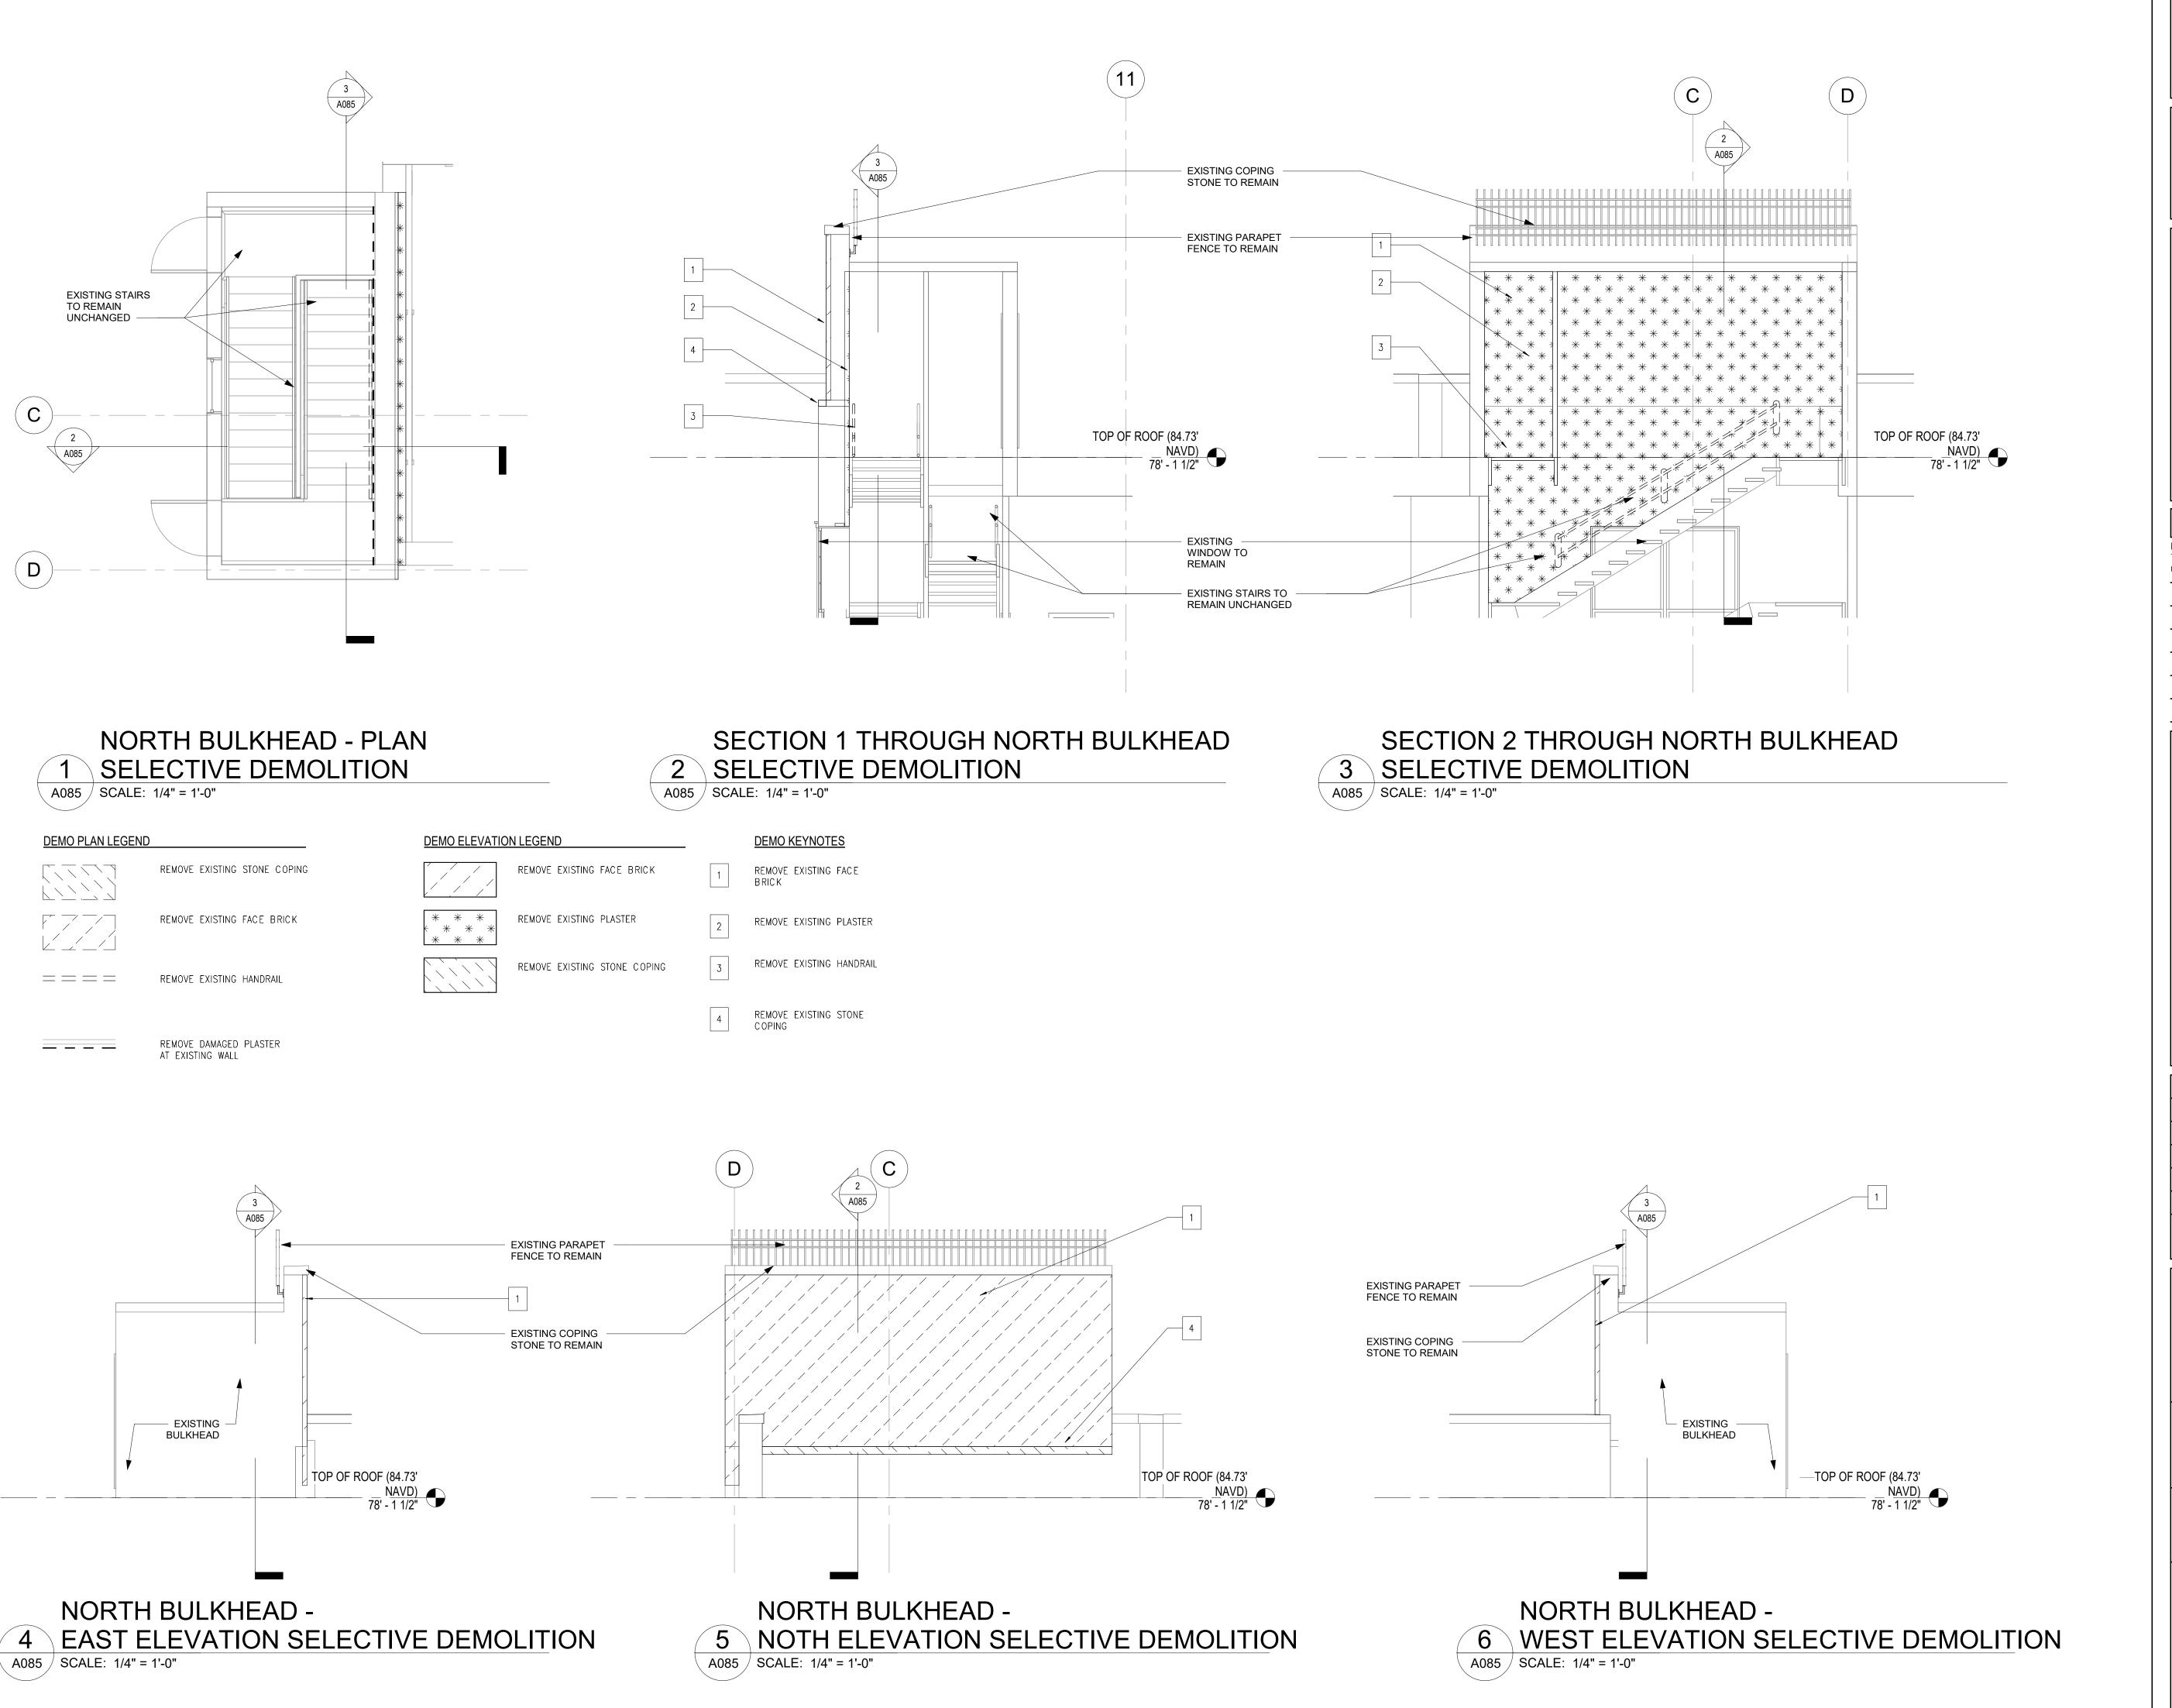

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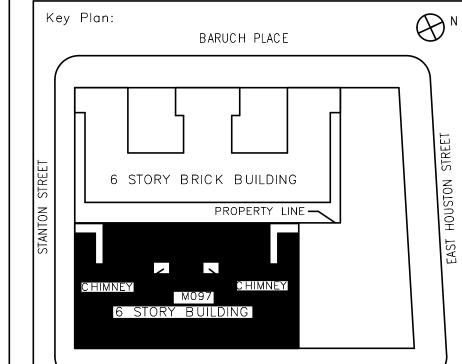
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No. Date Revision



MANGIN STREET

Block # 325

SCA Design Manager:

Project Architect/Engineer:

Discipline Lead:

Designer:

SCA Design Manager:

NASER HAMOUDEH, P.E.

JEFFREY RABINER, PE

JOHN HIGGINS, PE

GREGORY HERMAN

Lot # 25

Drawn by:

G. HERMAN / M. VARONA

Checked by:

JOHN HIGGINS, PE

Design No or LLW No.: Building ID: Date: 05/09/2023

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WASTE SYSTEM

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NEW YORK, NY 10002


Drawing Title:
NORTH BULKHEAD SELECTIVE
DEMOLITION

DOB NOW Job #M00660122-S1

Drawing No.: A085.00

Sheets in Contract Set: 18 of 42

Sheets in DOB Set: 15 of 37

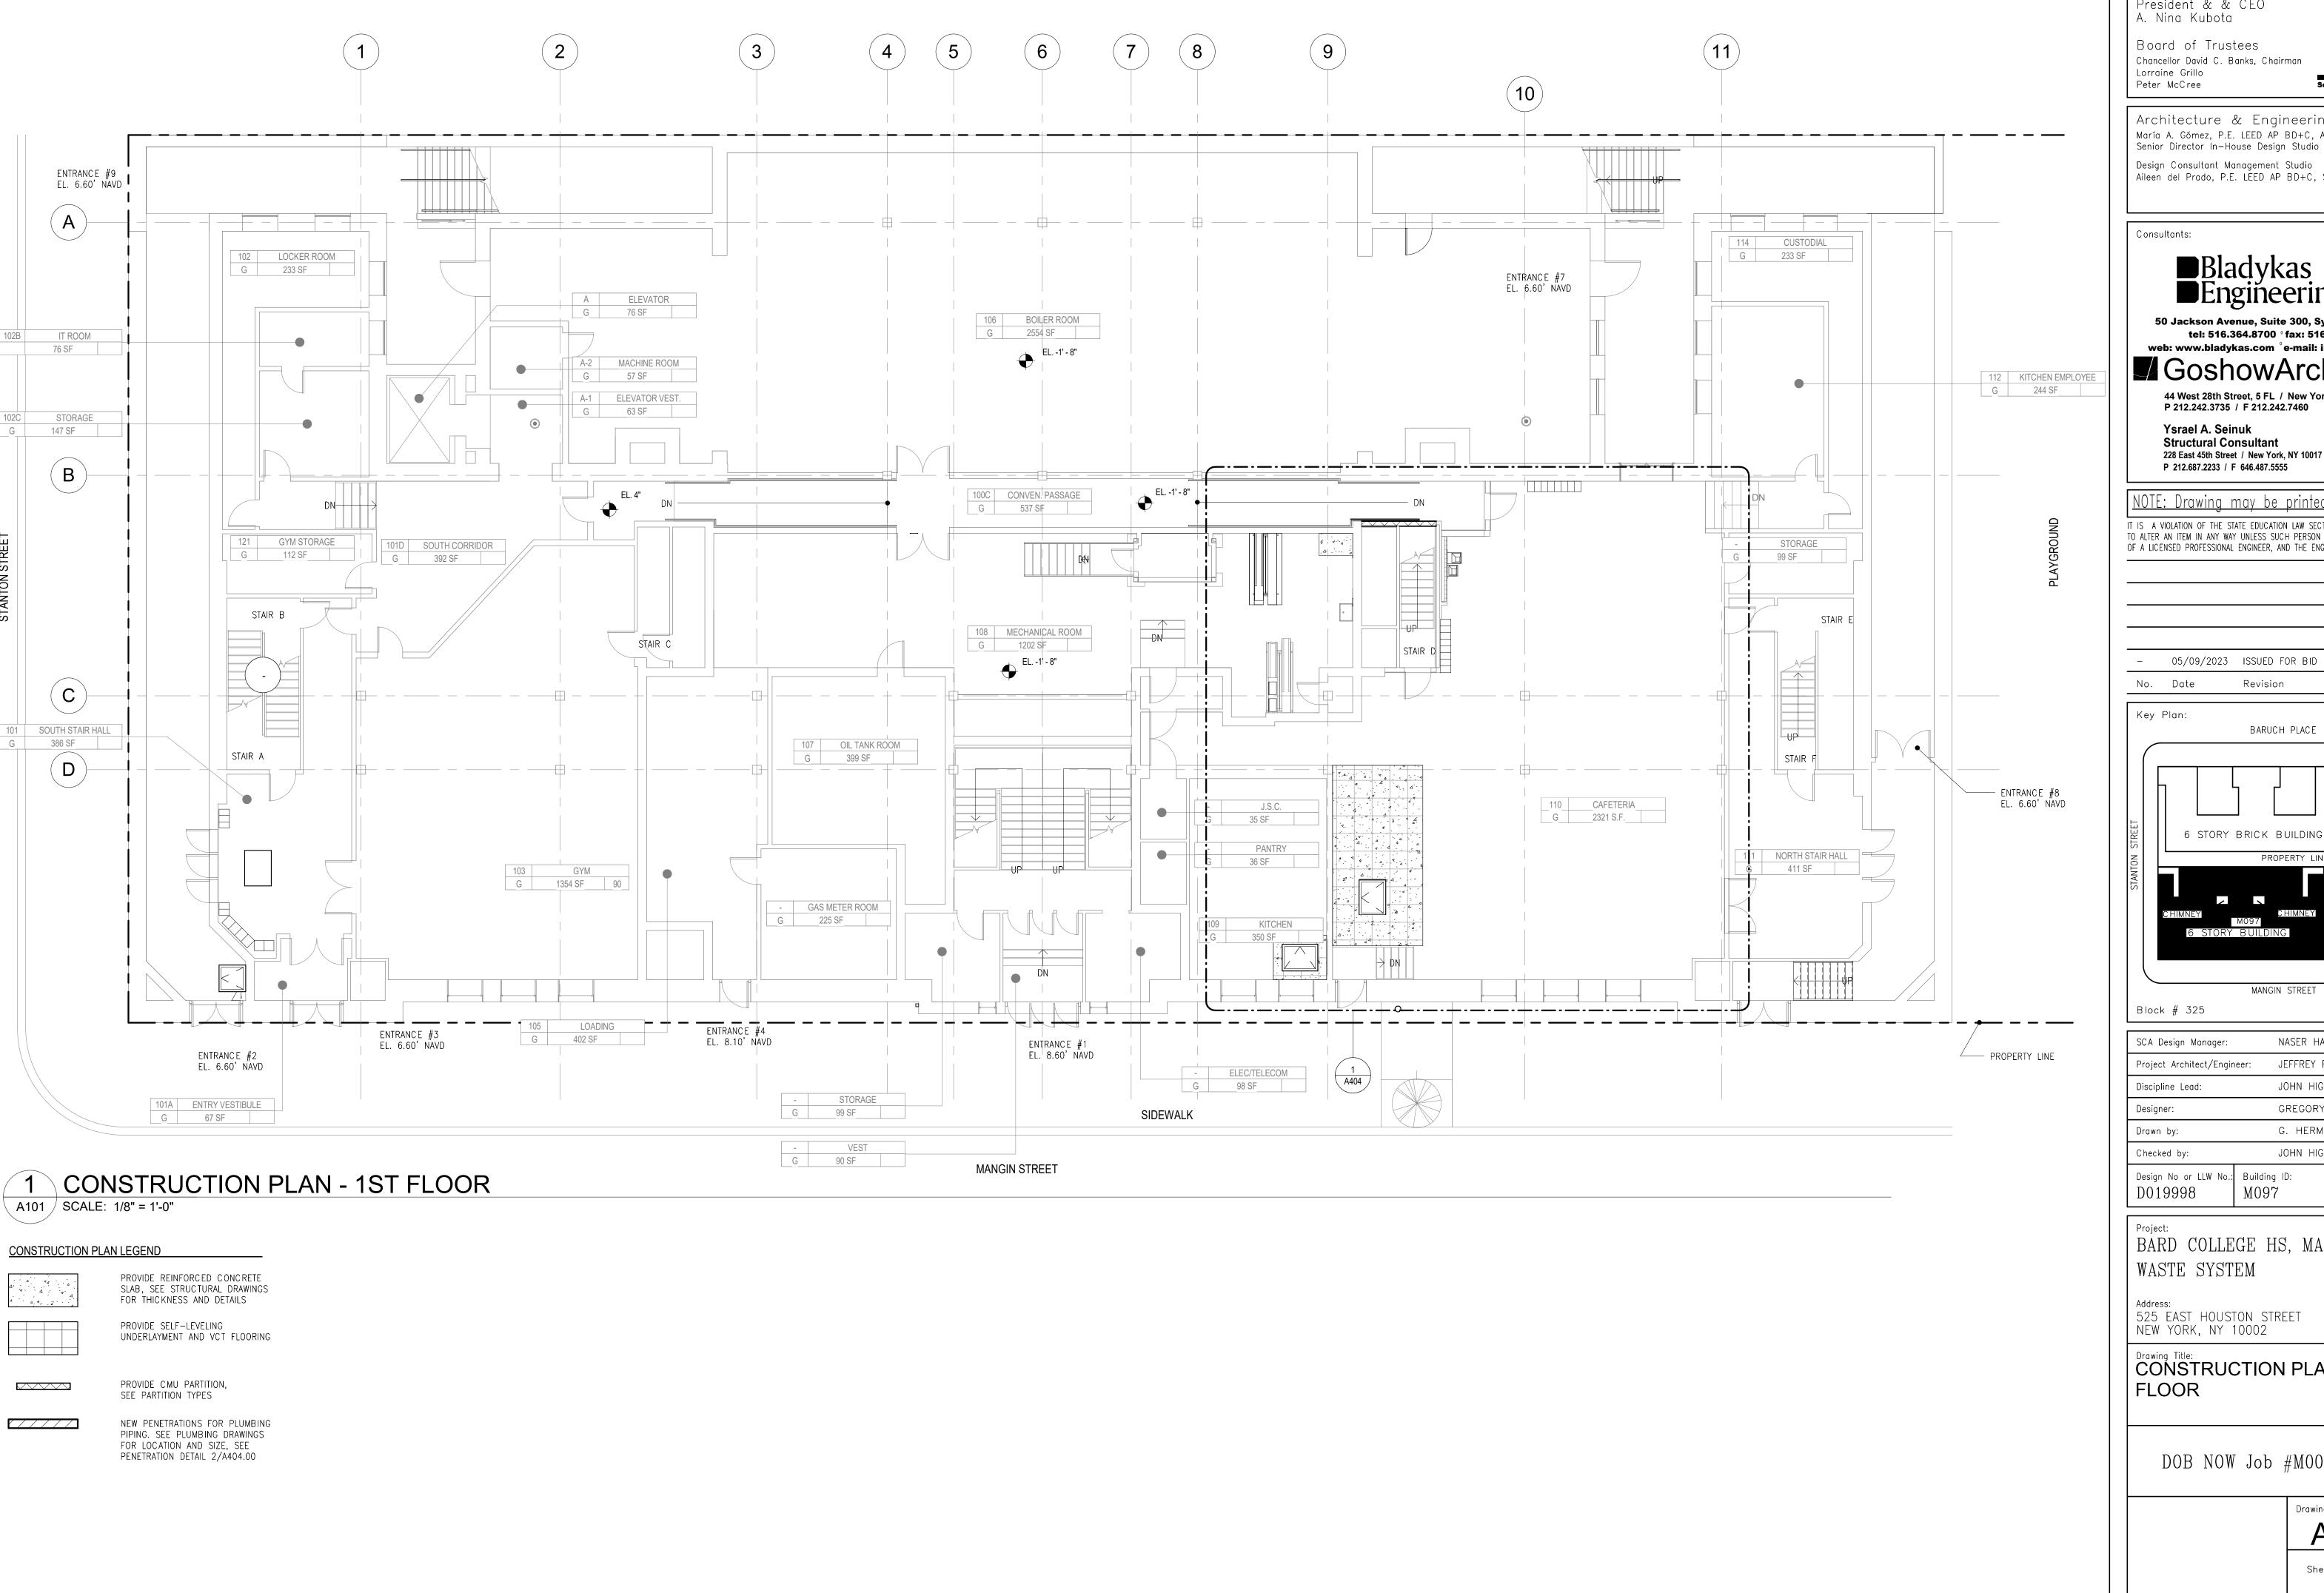

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Revision

 \bigotimes N BARUCH PLACE 6 STORY BRICK BUILDING

MANGIN STREET

Lot # 25 NASER HAMOUDEH, P.E. JEFFREY RABINER, PE Project Architect/Engineer: JOHN HIGGINS, PE GREGORY HERMAN

G. HERMAN / M. VARONA JOHN HIGGINS, PE Date: Building ID: M097 05/09/2023

BARD COLLEGE HS, MANHATTAN WASTE SYSTEM

525 EAST HOUSTON STREET NEW YORK, NY 10002


CONSTRUCTION PLAN - 1ST

DOB NOW Job #M00660122-S1

Drawing No.: A101.00

Sheets in Contract Set: **19** of **42**

Sheets in DOB Set: **16** of **37**

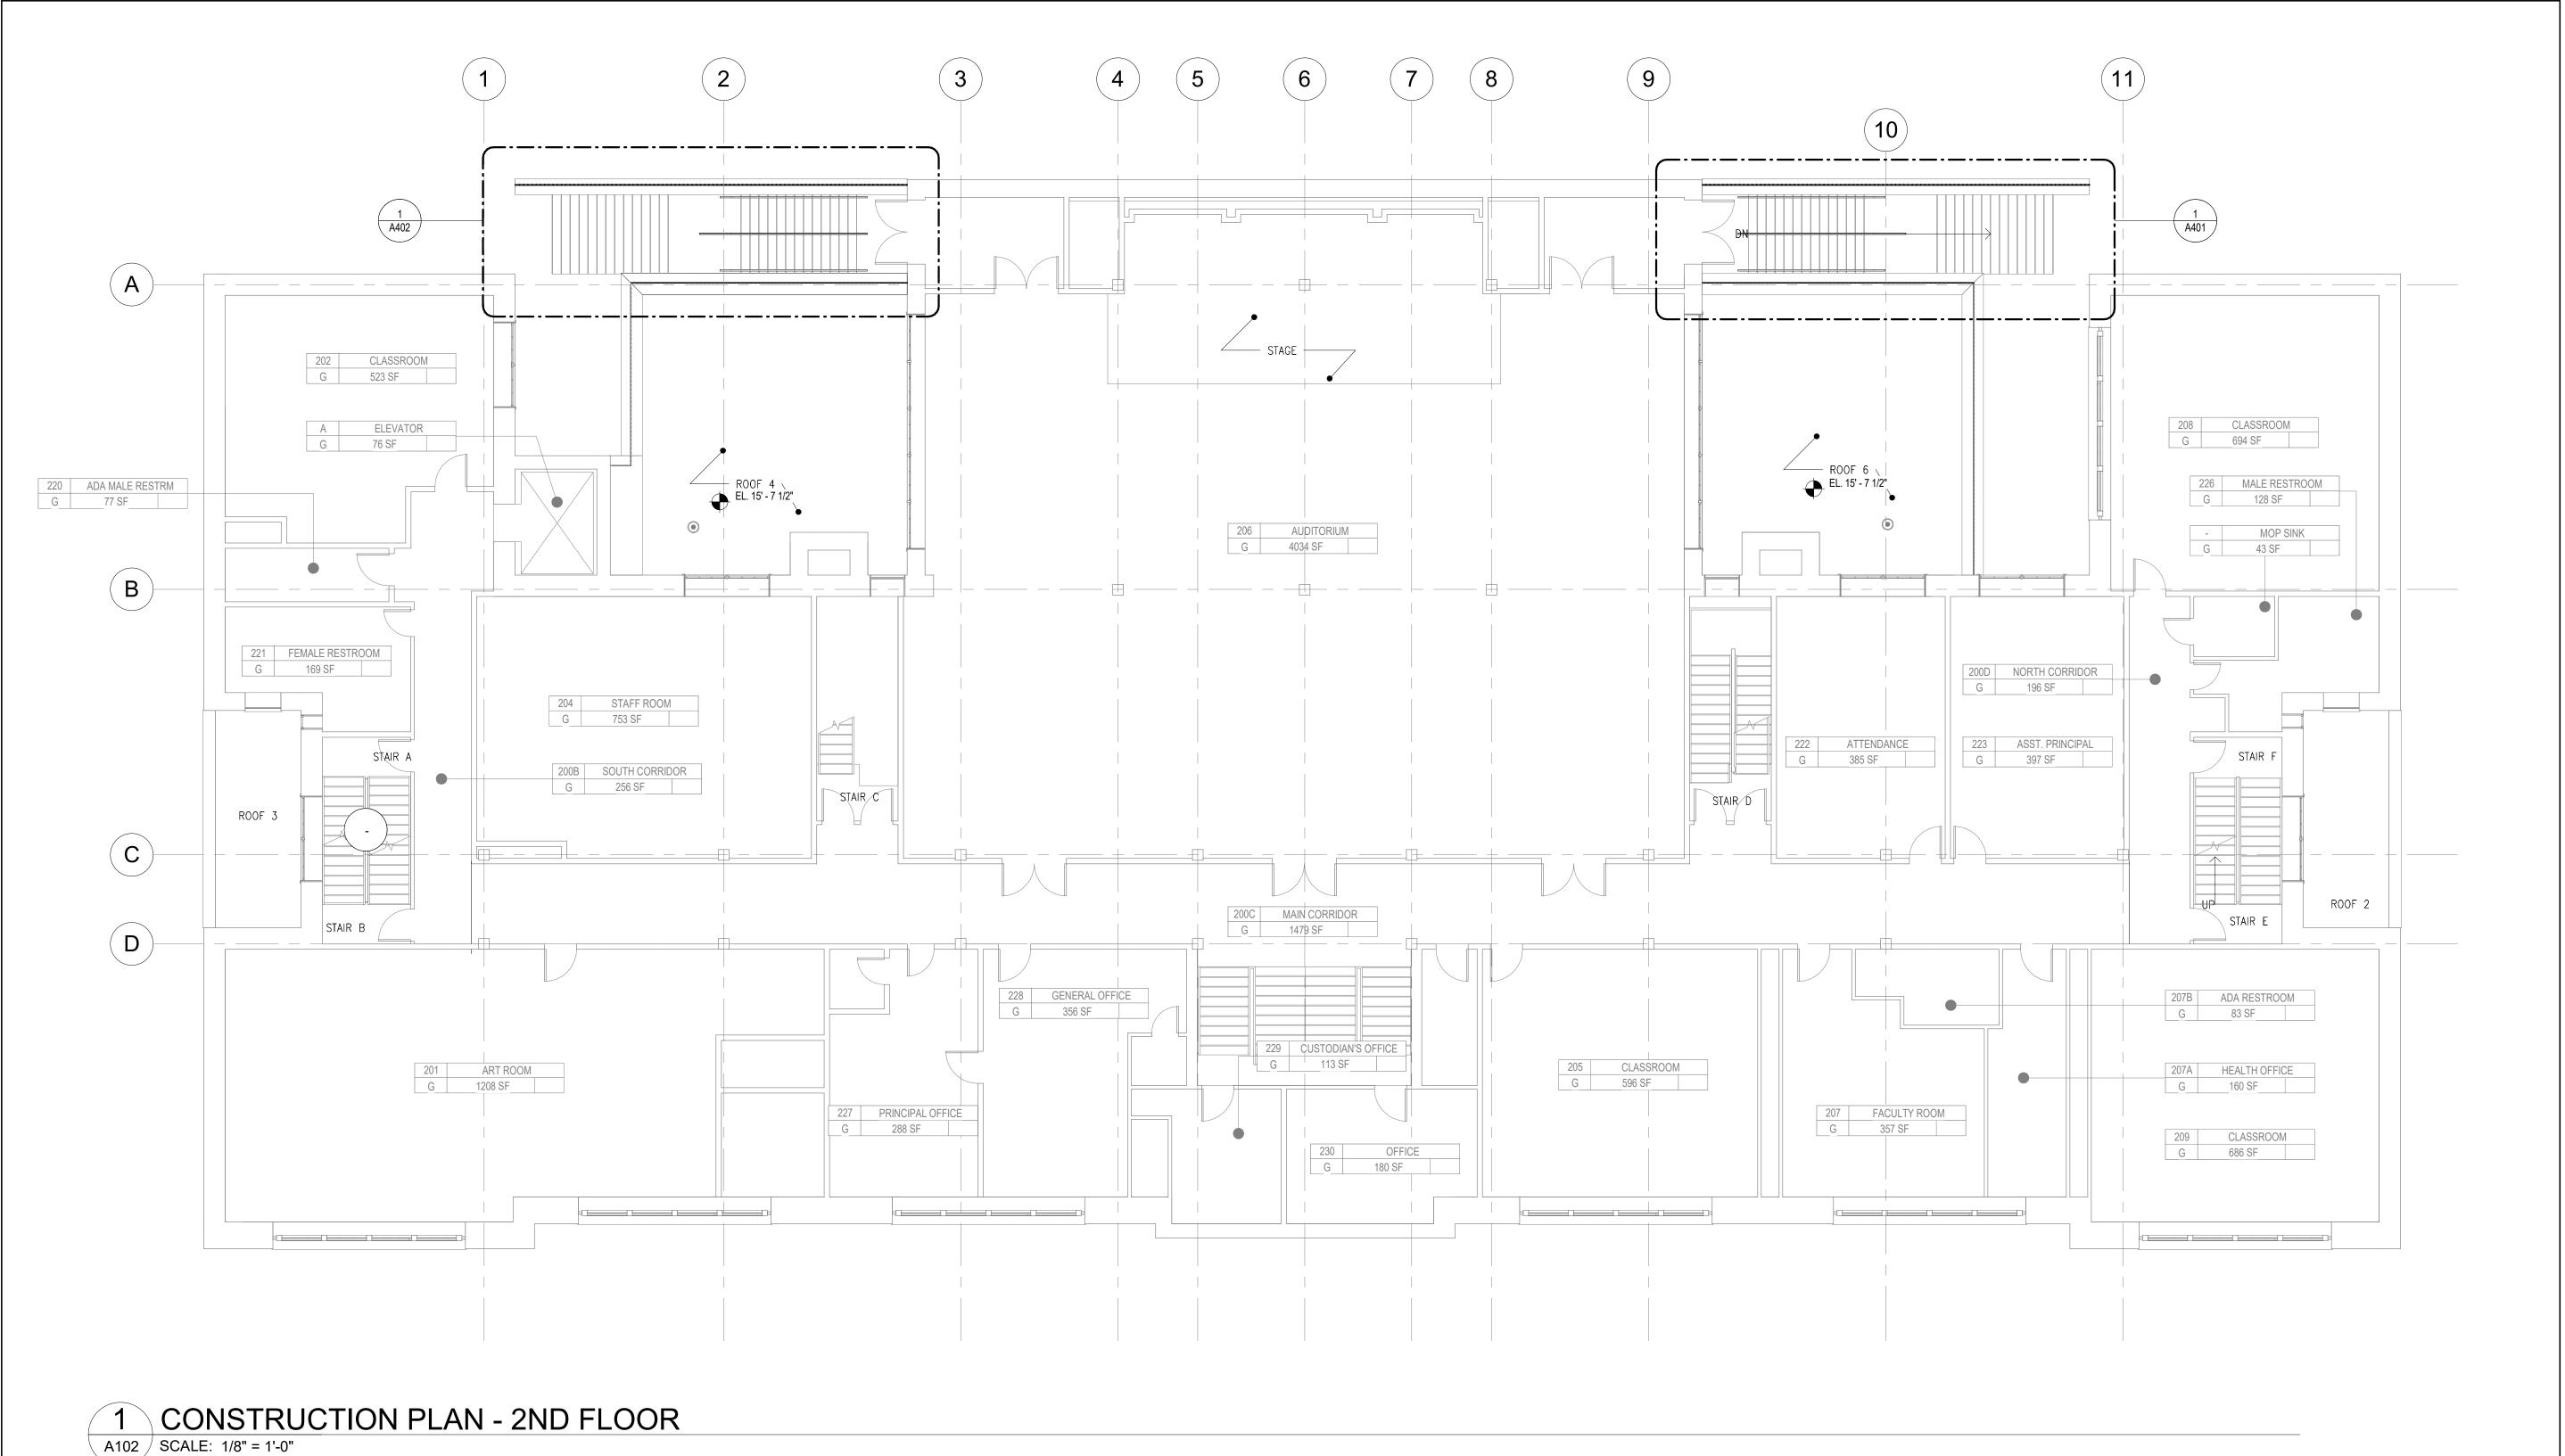

D019998 M097 05/09/2023

Project:
BARD COLLEGE HS, MANHATTAN

: Building ID:

Address: 525 EAST HOUSTON STREET NEW YORK, NY 10002

WASTE SYSTEM

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BARUCH PLACE

MANGIN STREET

NASER HAMOUDEH, P.E.

JEFFREY RABINER, PE

JOHN HIGGINS, PE

GREGORY HERMAN

JOHN HIGGINS, PE

G. HERMAN / M. VARONA

Date:

 \bigotimes N

Lot # 25

Ysrael A. Seinuk

Structural Consultant

P 212.687.2233 / F 646.487.5555

228 East 45th Street / New York, NY 10017

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6 STORY BRICK BUILDING

No. Date

Block # 325

Discipline Lead:

Drawn by:

Checked by:

Design No or LLW

SCA Design Manager:

Project Architect/Engineer:

Key Plan:

Design Consultant Management Studio Aileen del Prado, P.E. LEED AP BD+C, Senior Director

A. Nina Kubota


Lorraine Grillo Peter McCree

CONSTRUCTION PLAN - 2ND FLOOR

DOB NOW Job #M00660122-S1

Drawing No.:
A102.00

Sheets in Contract Set: 20 of 42

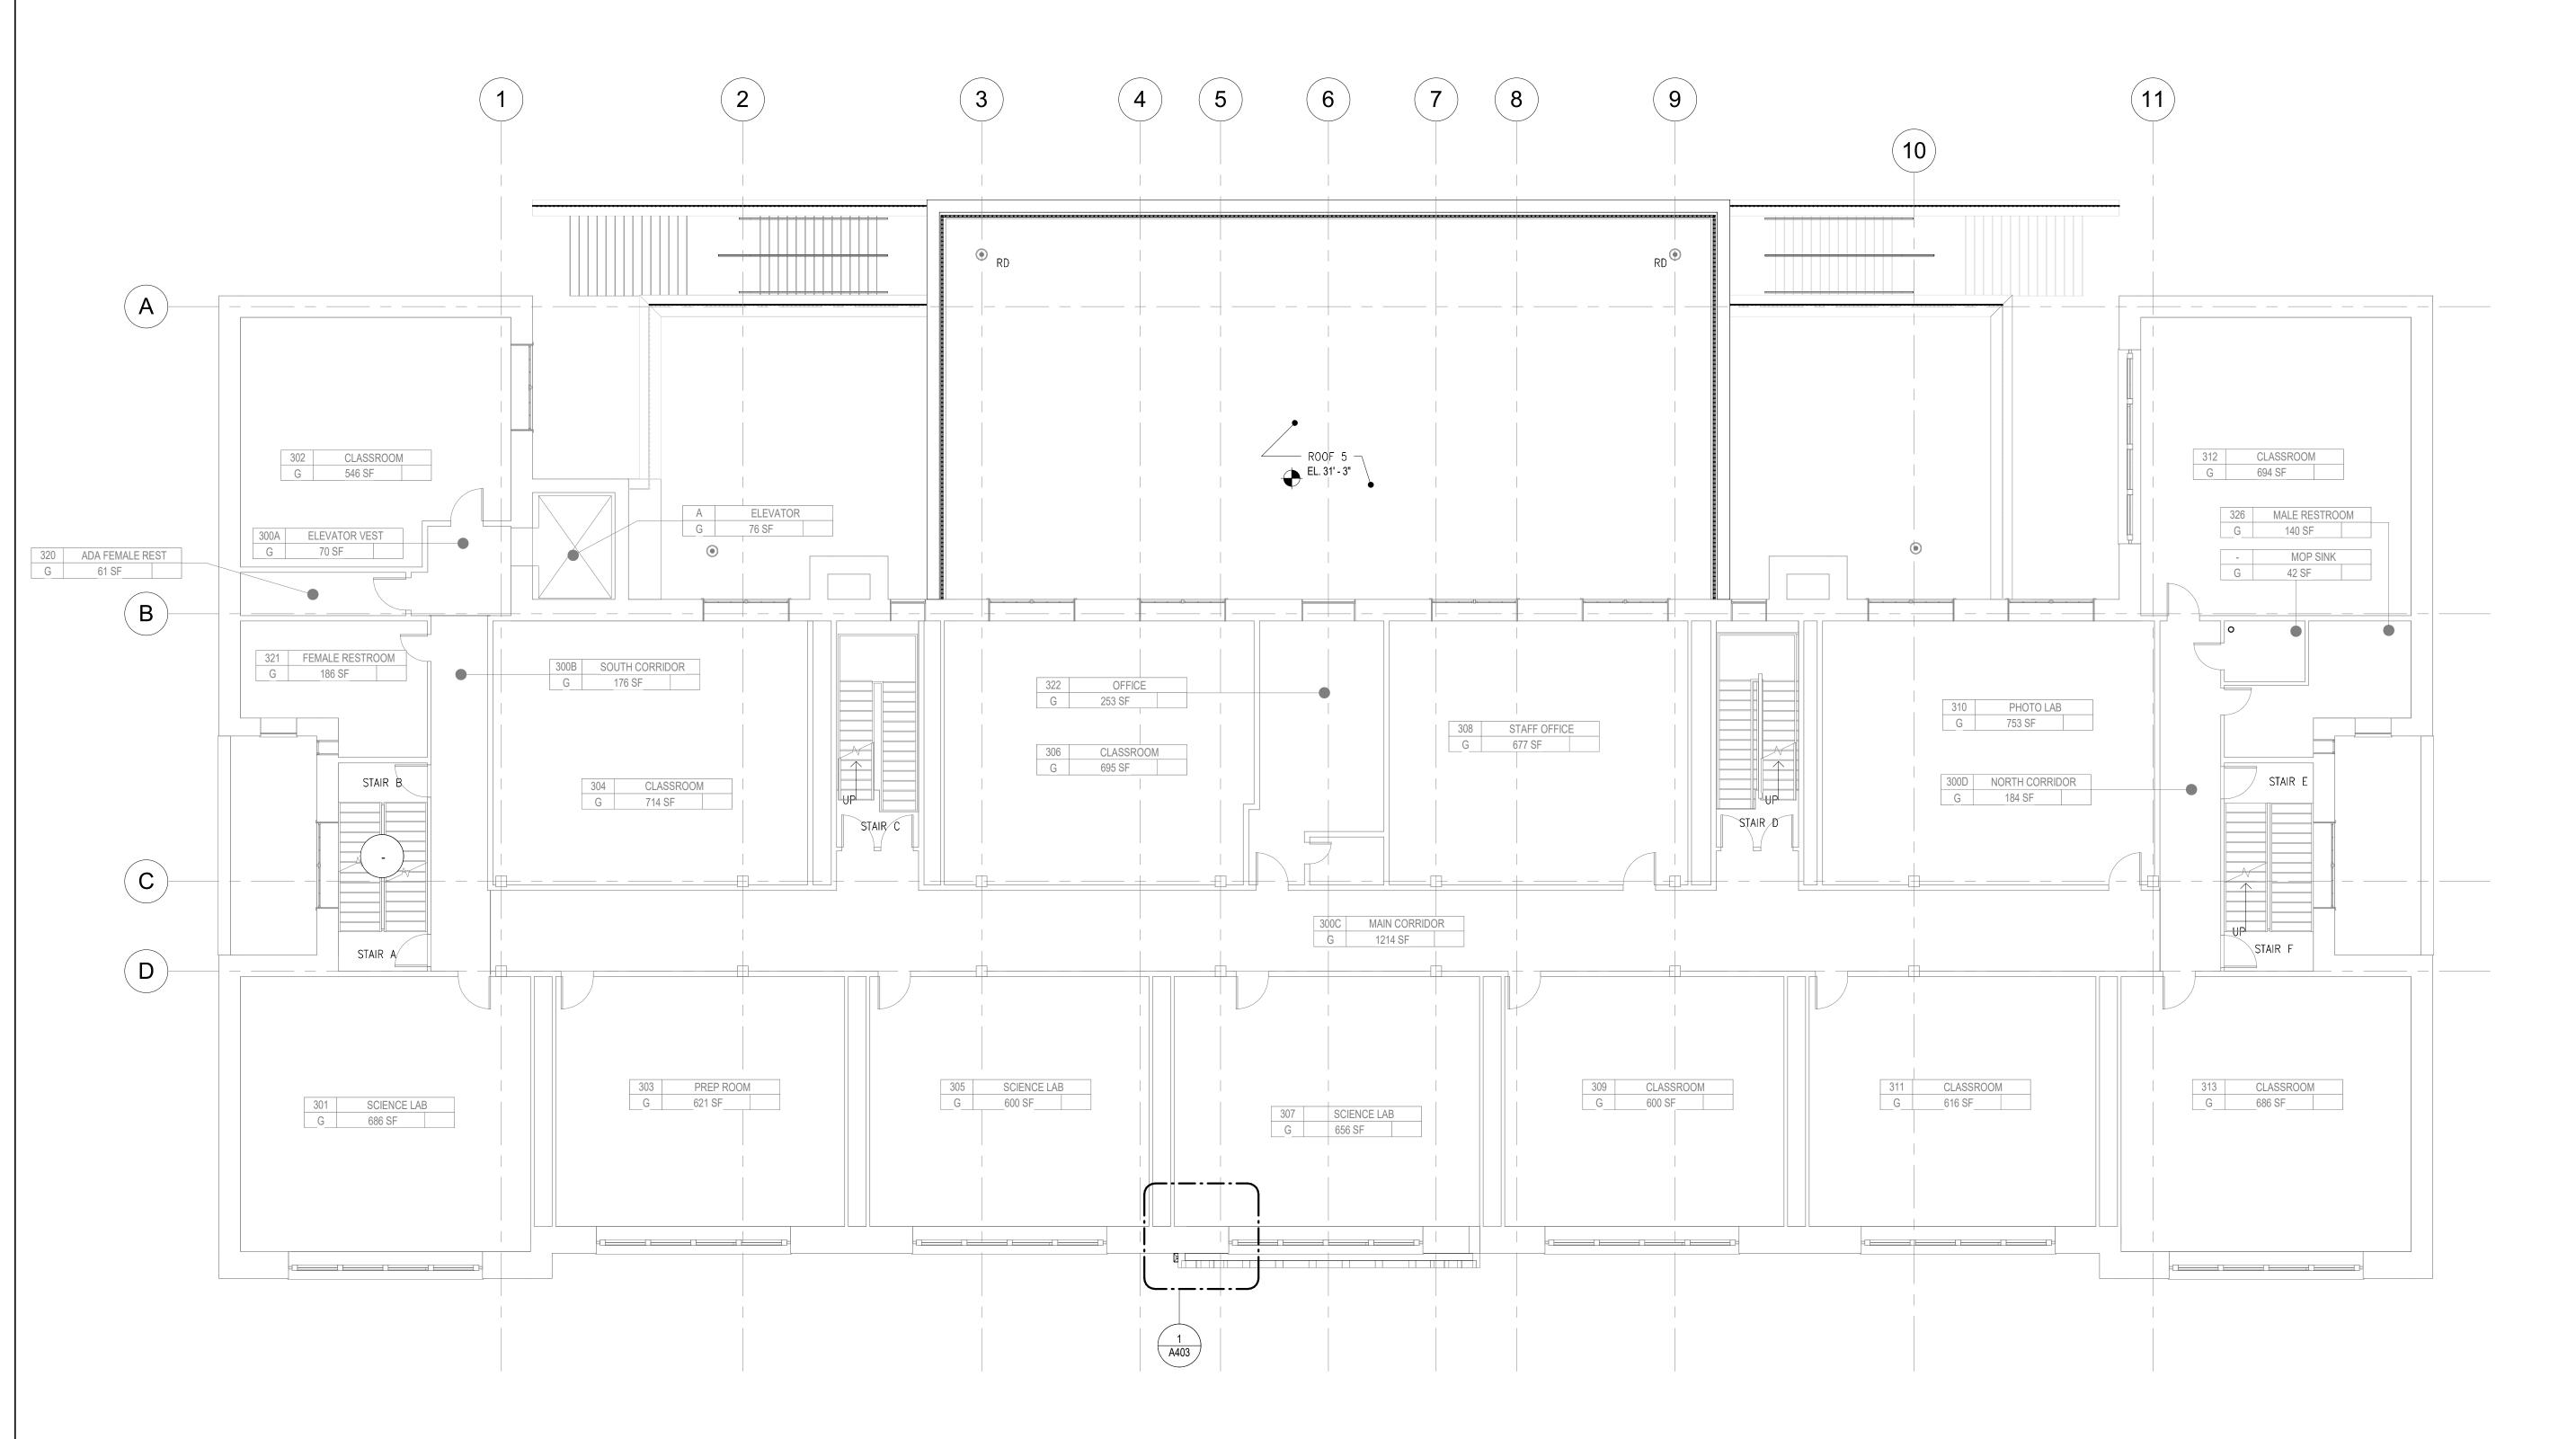

1 CONSTRUCTION PLAN - 3RD FLOOR

A103 | SCALE: 1/8" = 1'-0"

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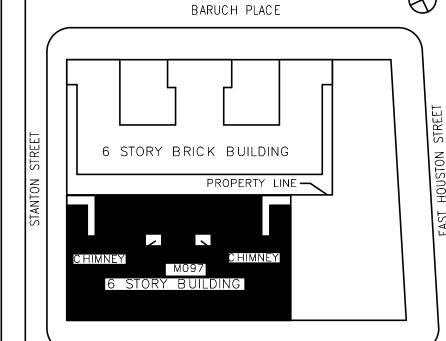
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No. Date Revision

Key Plan:



MANGIN STREET
Block # 325

Lot # 25

05/09/2023

	SCA Design Manager:	NASER HAMOUDEH, P.E.
	Project Architect/Engineer:	JEFFREY RABINER, PE
	Discipline Lead:	JOHN HIGGINS, PE
	Designer:	GREGORY HERMAN
	Drawn by:	G. HERMAN / M. VARONA
	Checked by:	JOHN HIGGINS, PE

Project:
BARD COLLEGE HS, MANHATTAN
WASTE SYSTEM

M097

Address: 525 EAST HOUSTON STREET NEW YORK, NY 10002

Design No or LLW No.: Building ID:


D019998

CONSTRUCTION PLAN - 3RD FLOOR

DOB NOW Job #M00660122-S1

Drawing No.:
A103.00

Sheets in Contract Set: 21 of 42

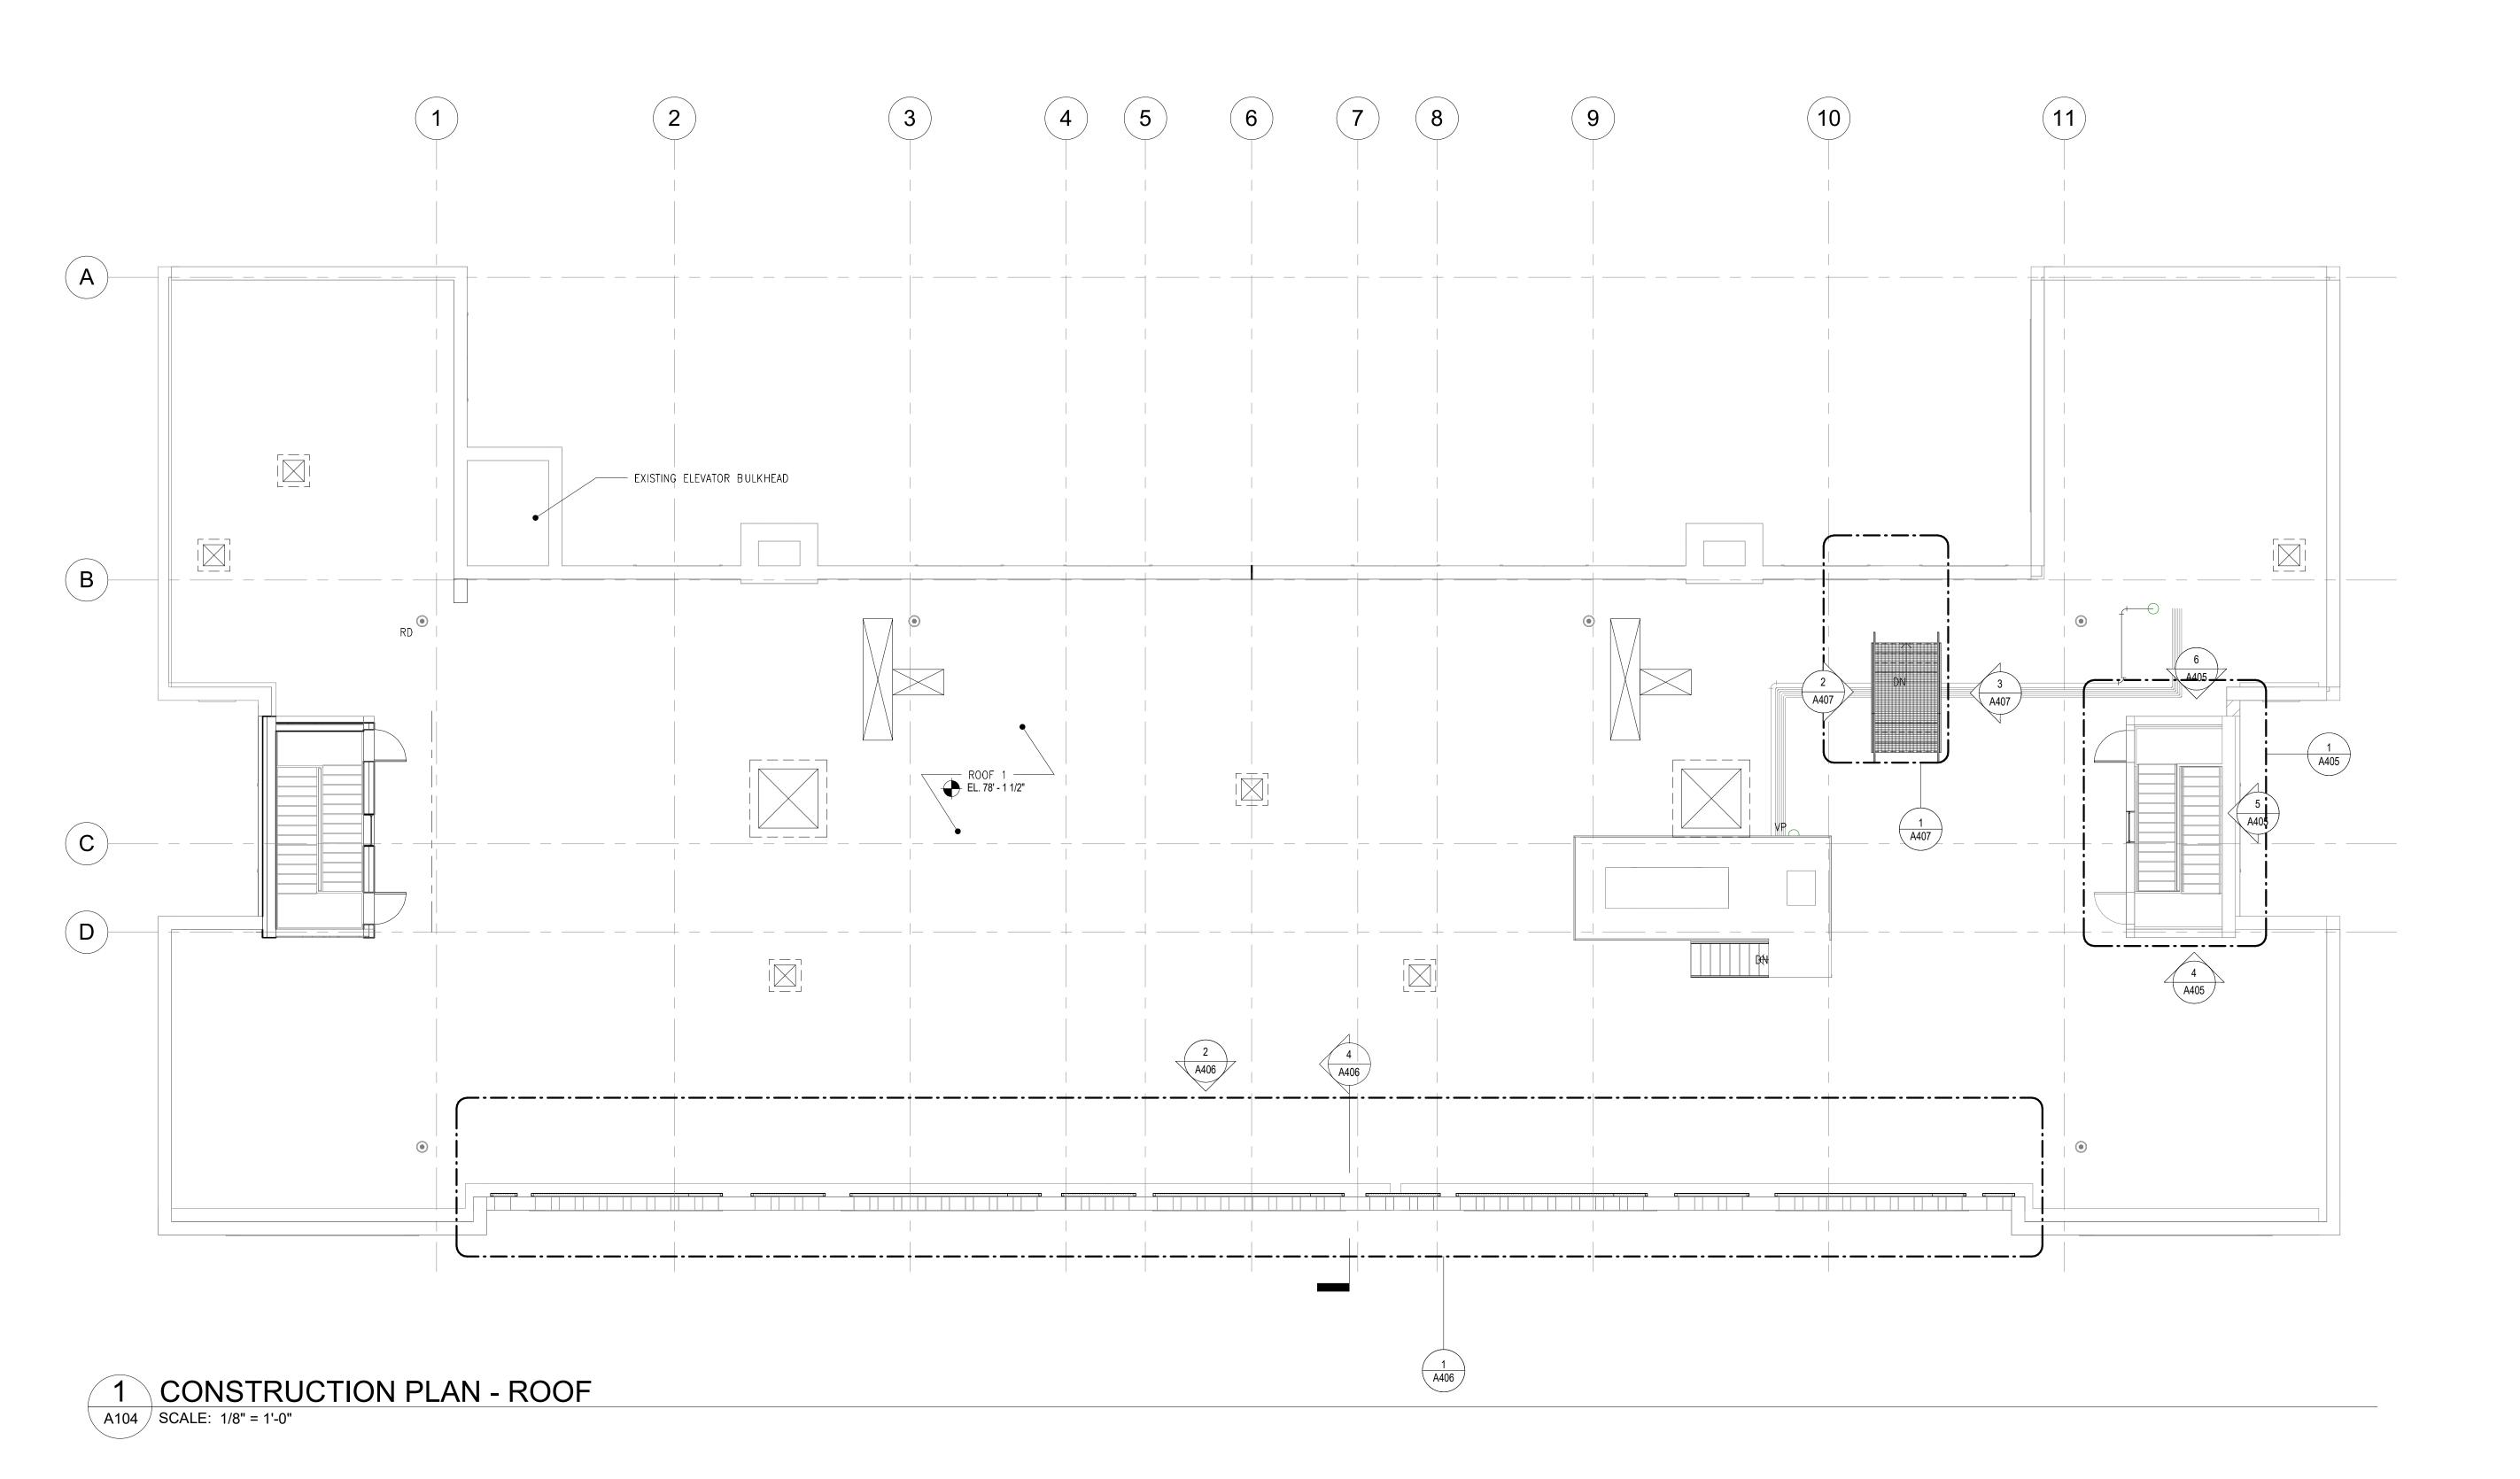

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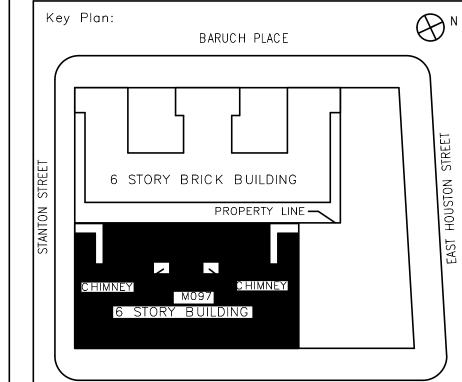
Ysrael A. Seinuk Structural Consultant 228 East 45th Street / New York, NY 10017 P 212.687.2233 / F 646.487.5555

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No. Date Revision



MANGIN STREET

Block # 325

SCA Design Manager:

NASER HAMOUDEH, P.E.

Project Architect/Engineer:

JEFFREY RABINER, PE

Discipline Lead:

JOHN HIGGINS, PE

Designer:

GREGORY HERMAN

Drawn by:

G. HERMAN / M. VARONA

Checked by: JOHN HIGGINS, PE

Design No or LLW No.: Building ID: Date: $\frac{D019998}{M097} \frac{D5/09/2023}{D5/09/2023}$

BARD COLLEGE HS, MANHATTAN
WASTE SYSTEM


Address: 525 EAST HOUSTON STREET NEW YORK, NY 10002

Drawing Title: CONSTRUCTION PLAN - ROOF

DOB NOW Job #M00660122-S1


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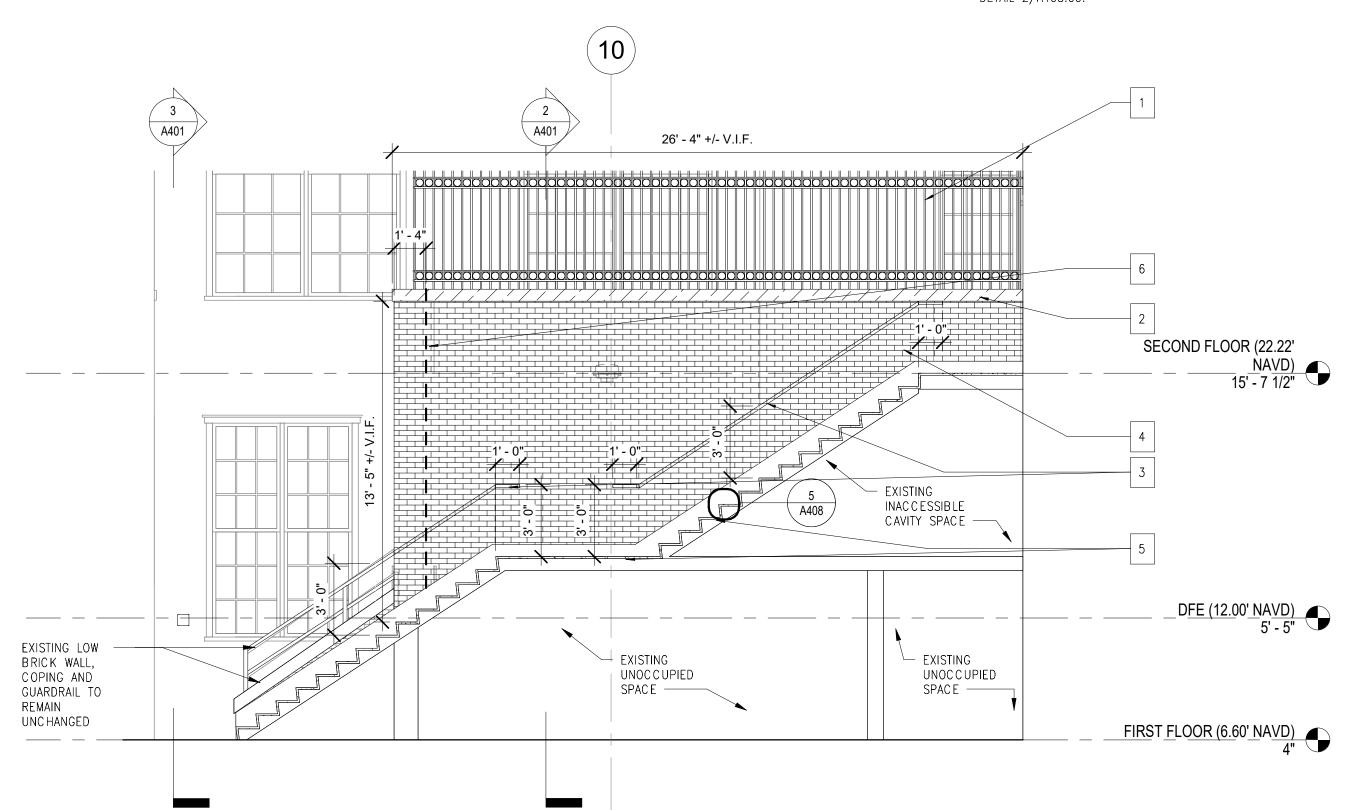
Sheets in Contract Set:
22 of 42

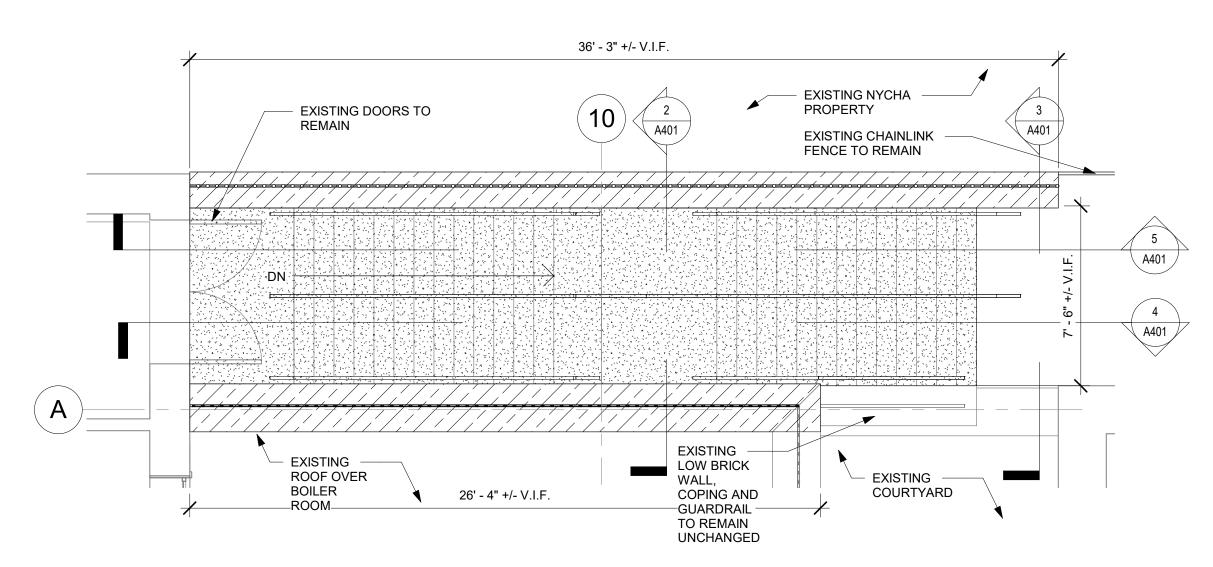

1 NORTH EGRESS STAIR CONSTRUCTION PLAN


A401 SCALE: 1/4" = 1'-0"



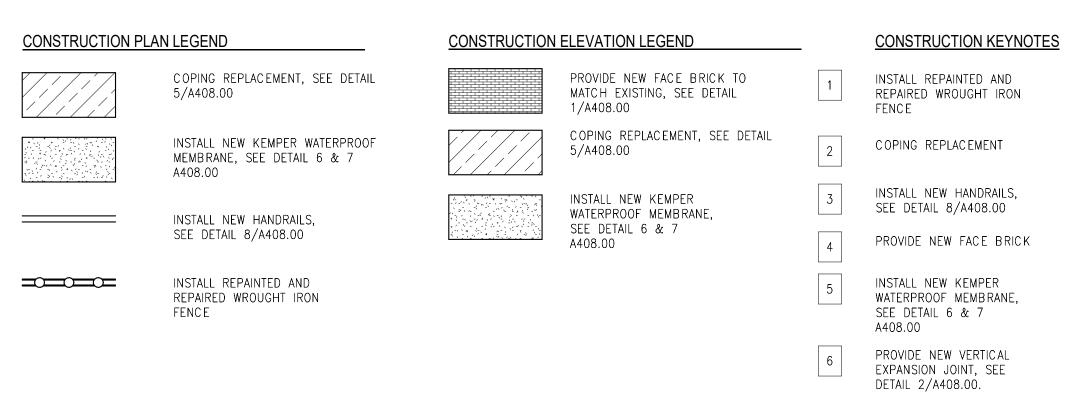

4 NORTH EGRESS STAIR CONSTRUCTION SECTION 3


SCALE: 1/4" = 1'-0"

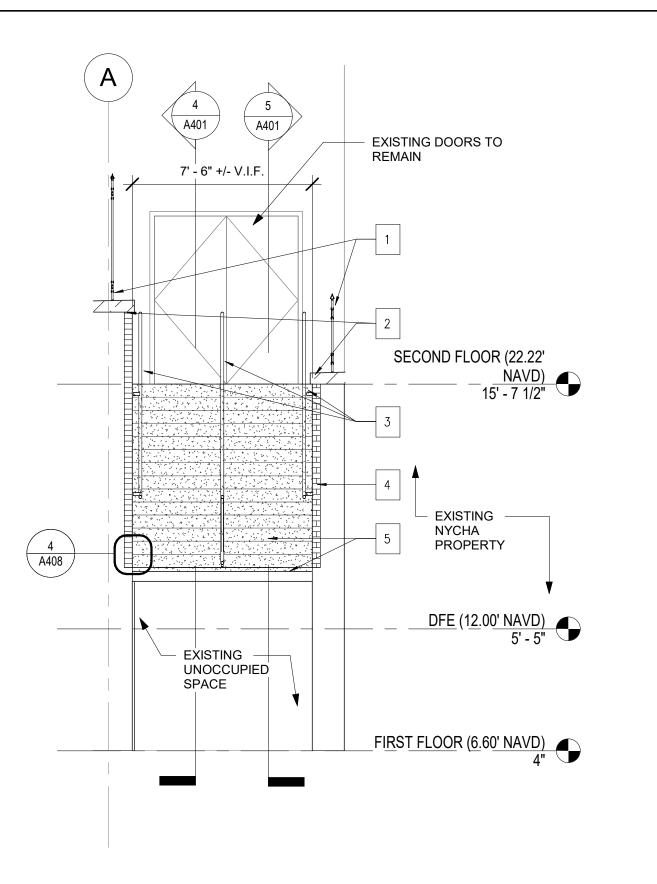

NORTH EGRESS STAIR

CONSTRUCTION SECTION 1

SCALE: 1/4" = 1'-0"

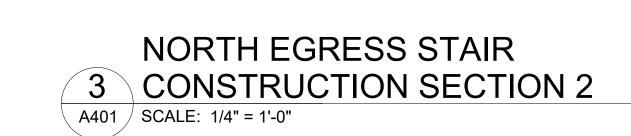

A401

A401 /

SECOND FLOOR (22.22'

NAVD) 15' - 7 1/2"


EXISTING

PROPERTY

DFE (12.00' NAVD)

FIRST FLOOR (6.60' NAVD)

NYCHA

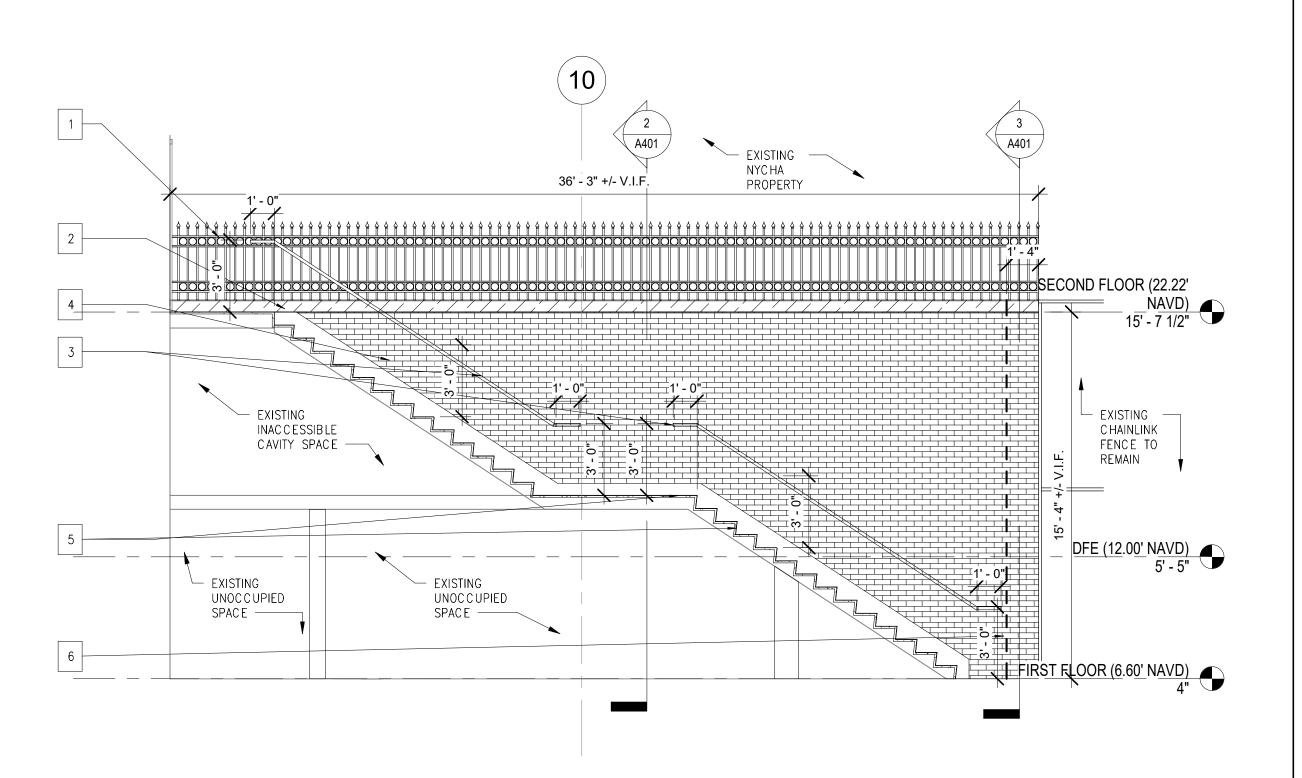

EXISTING — SECTION OF

REMAIN

RAILING TO

UNCHANGED

EXISTING

WALL TO

EXISTING

WALL,

LOW BRICK

COPING AND

UNCHANGED

GUARDRAIL TO REMAIN

REMAIN UNCHANGED

5 NORTH EGRESS STAIR CONSTRUCTION SECTION 4

A401 SCALE: 1/4" = 1'-0"

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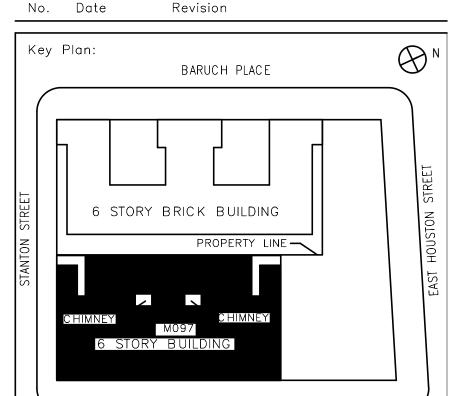
Ysrael A. Seinuk Structural Consultant 228 East 45th Street / New York, NY 10017 P 212.687.2233 / F 646.487.5555

NOTE: Drawing may be printed at reduced scale

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- 03/09/2023 1330ED 10K



MANGIN STREET
Block # 325

SCA Design Manager:

NASER HAMOUDEH, P.E.

Project Architect/Engineer:

JEFFREY RABINER, PE

Discipline Lead:

JOHN HIGGINS, PE

Designer:

GREGORY HERMAN

Drawn by:

G. HERMAN / M. VARONA

Lot # 25

Checked by:

Design No or LLW No.:

D019998

D1 D019998

D1 D019998

D1 D019998

D1 D019998

D1 D019998

D1 D019998

BARD COLLEGE HS, MANHATTAN
WASTE SYSTEM

Address: 525 EAST HOUSTON STREET NEW YORK, NY 10002


NORTH REAR EGRESS STAIR
REPAIR WORK

DOB NOW Job #M00660122-S1

Drawing No.:
A401.00

Sheets in Contract Set:

Sheets in DOB Set: 20 of 37

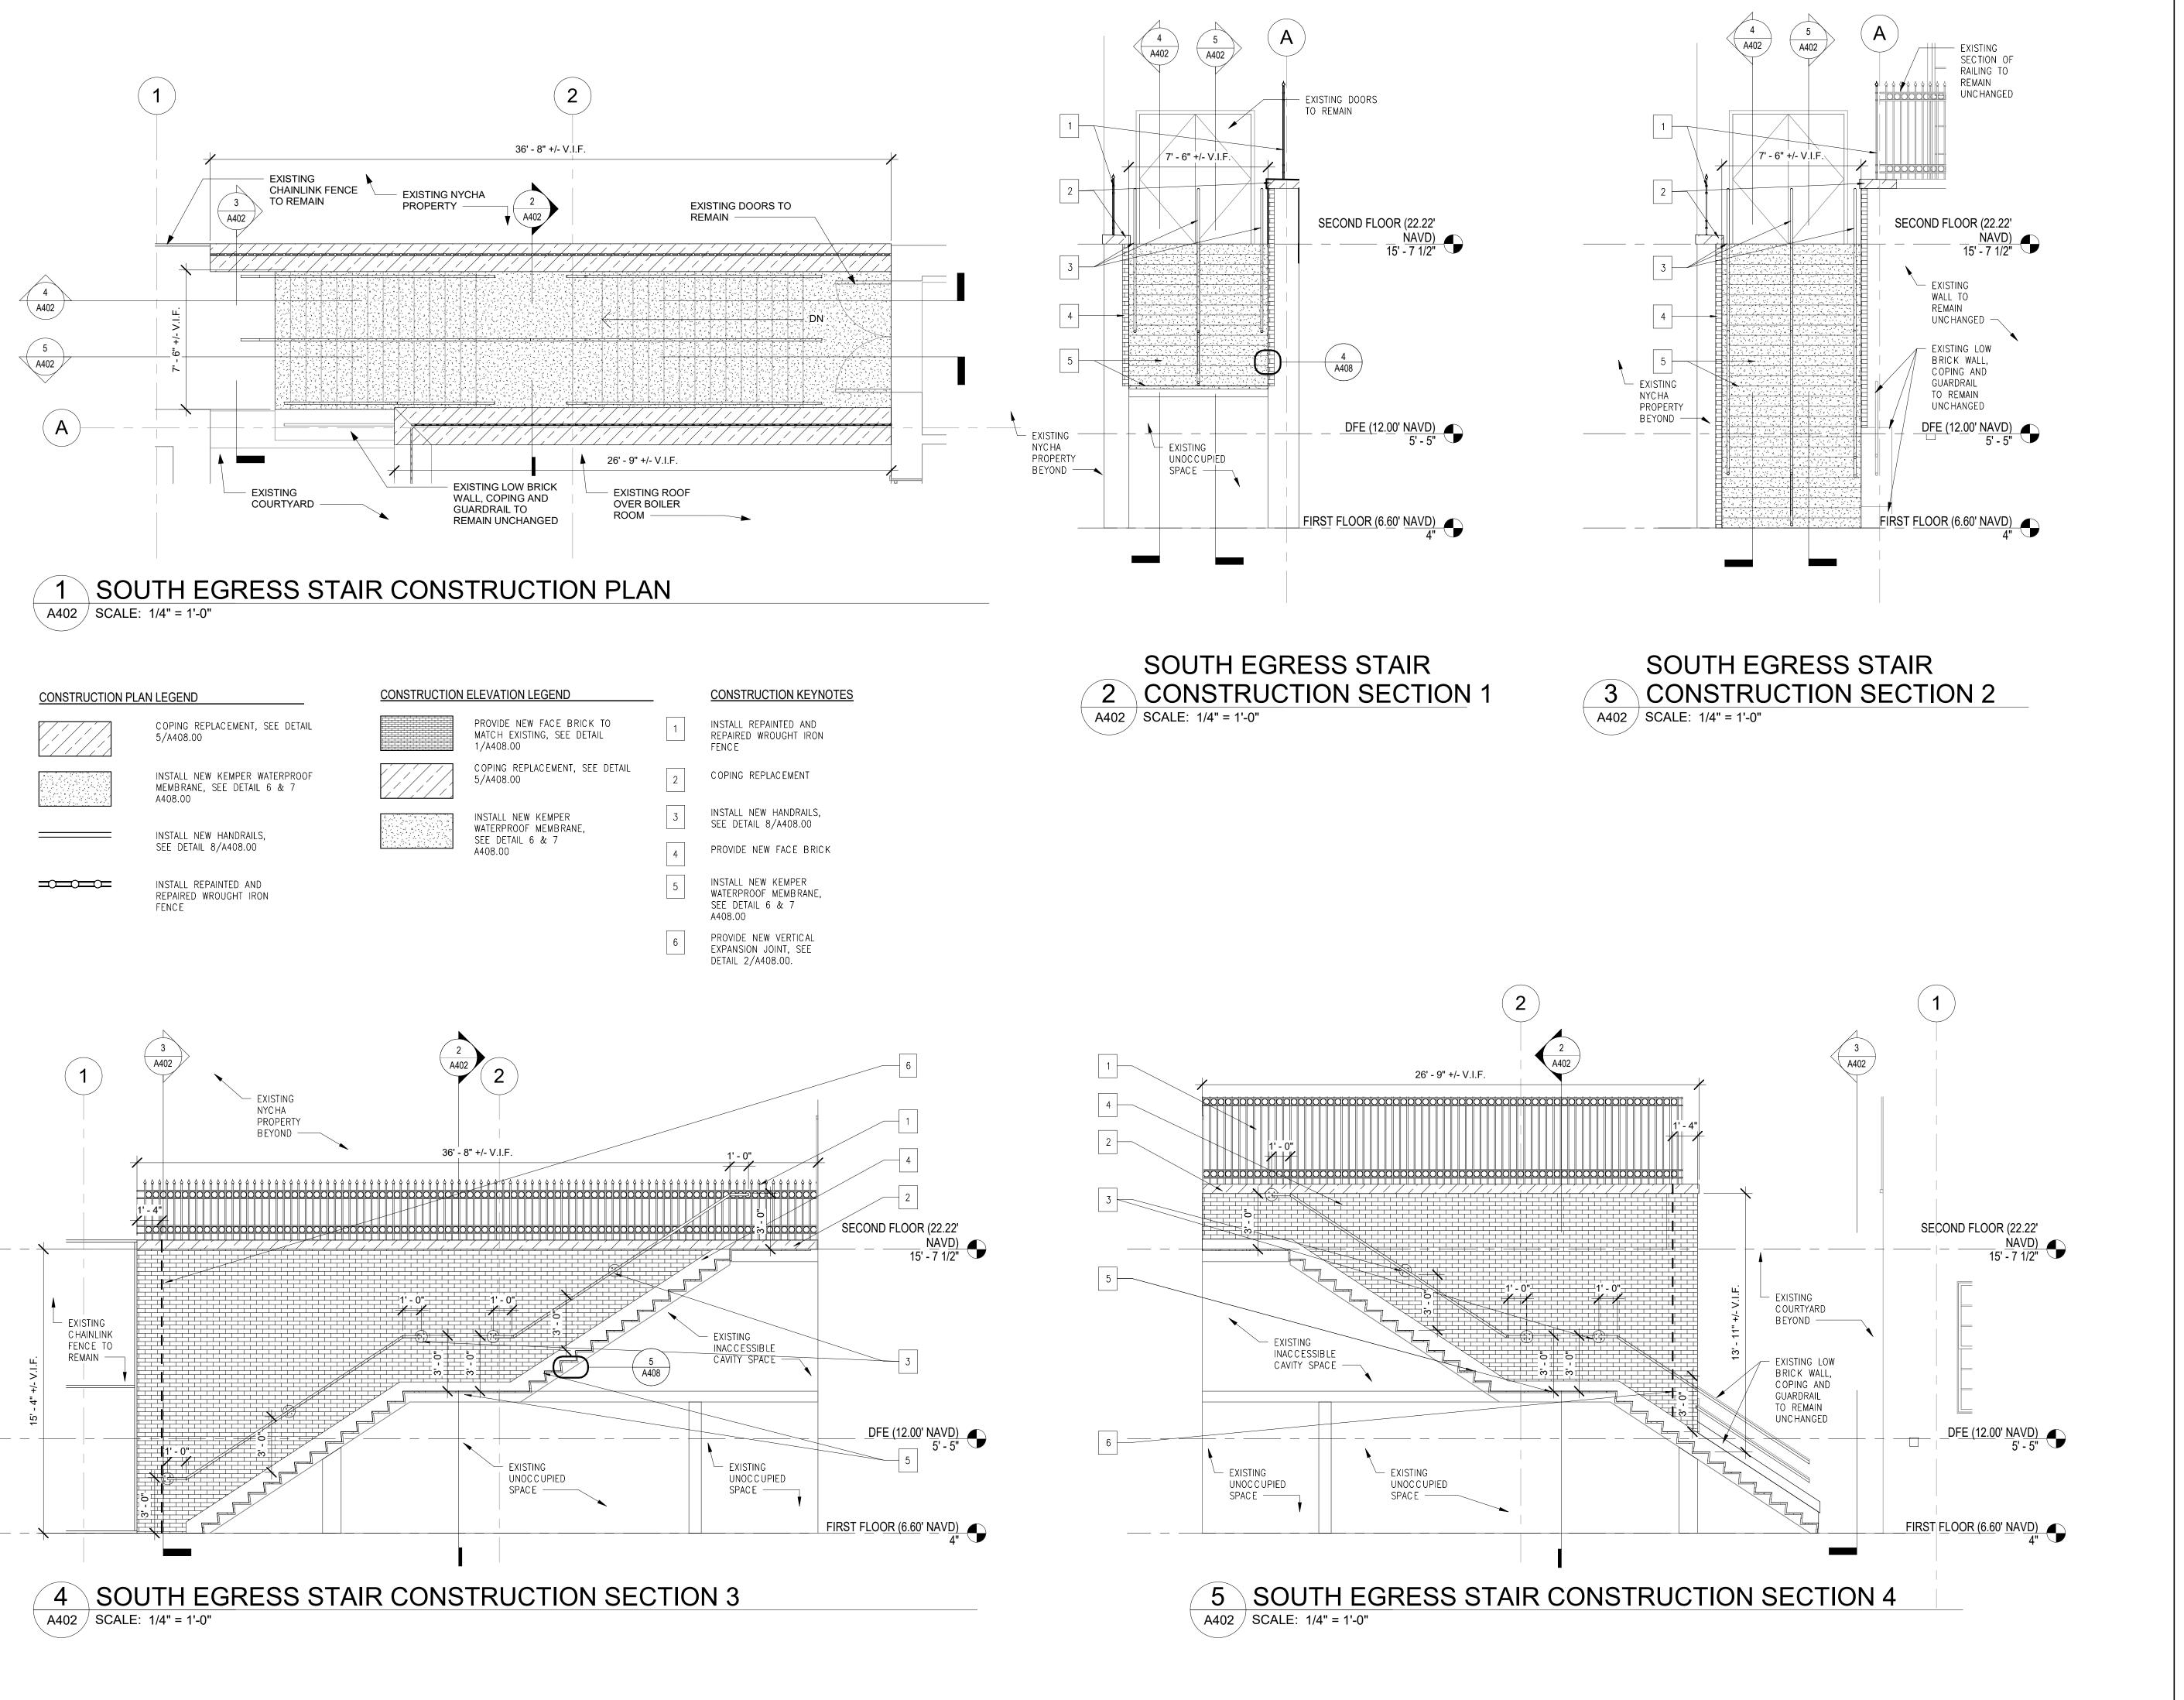

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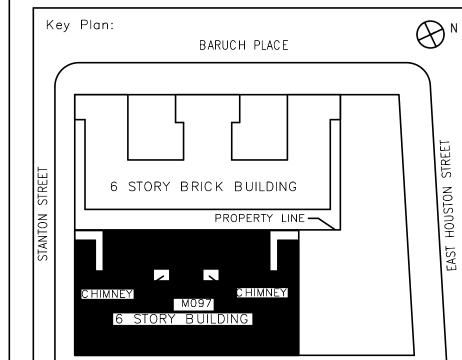
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No. Date Revision



MANGIN STREET
Block # 325

SCA Design Manager:

Project Architect/Engineer:

JEFFREY RABINER, PE

Discipline Lead:

JOHN HIGGINS, PE

Designer:

GREGORY HERMAN

Drawn by:

G. HERMAN / M. VARONA

Lot # 25

Checked by:

Design No or LLW No.: Building ID:

D019998

M097

Date:

05/09/2023

BARD COLLEGE HS, MANHATTAN
WASTE SYSTEM

Address: 525 EAST HOUSTON STREET NEW YORK, NY 10002


SOUTH REAR EGRESS STAIR
REPAIR WORK

DOB NOW Job #M00660122-S1


Drawing No.:
A402.00

Sheets in Contract Set: 24 of 42

Sheets in DOB Set:
21 of 37

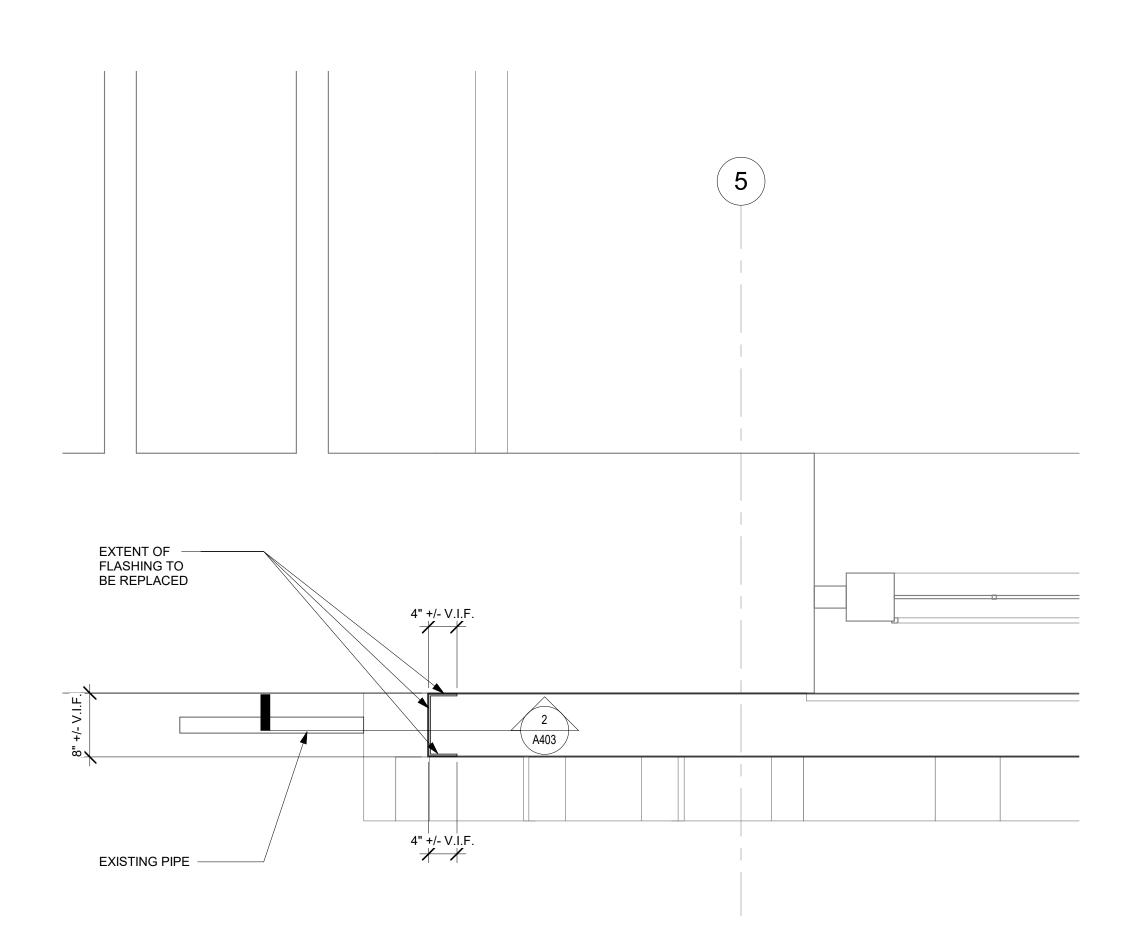

MAIN ENTRANCE BALCONY CONSTRUCTION PLAN A403 / SCALE: 1" = 1'-0"

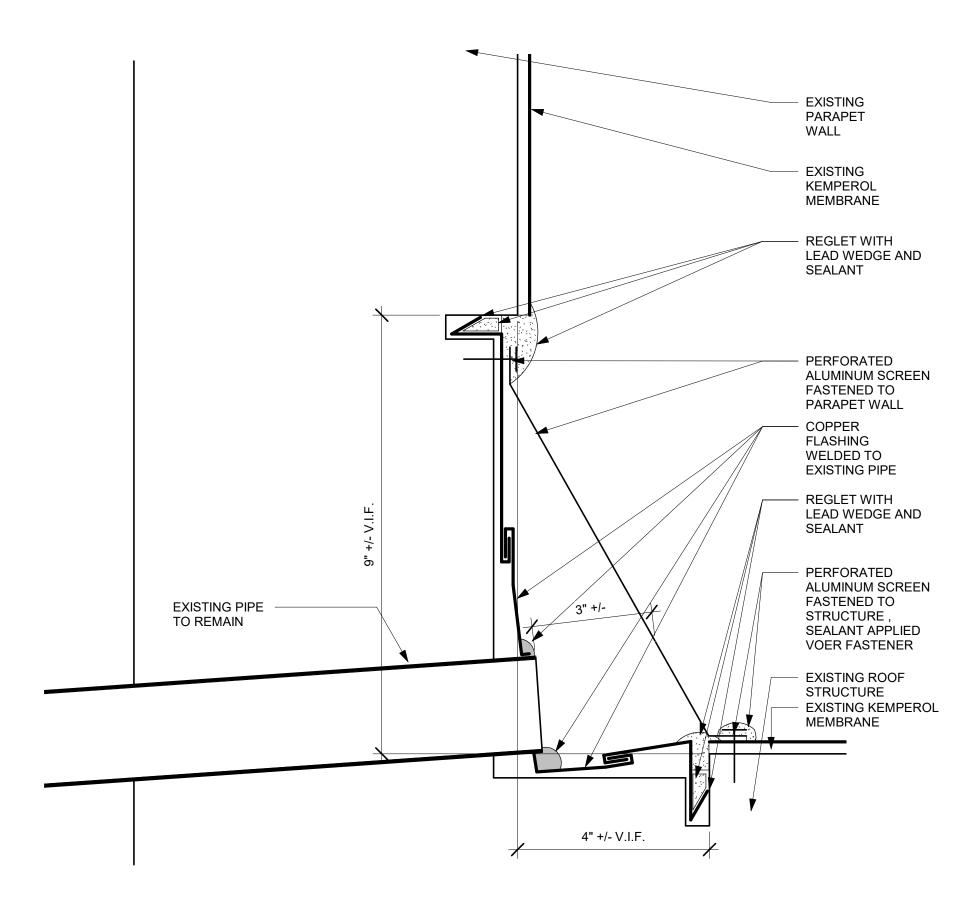

SECTION THROUGH MAIN ENTRANCE PARAPET 2 WALL CONSTRUCTION A403 / SCALE: 6" = 1'-0"

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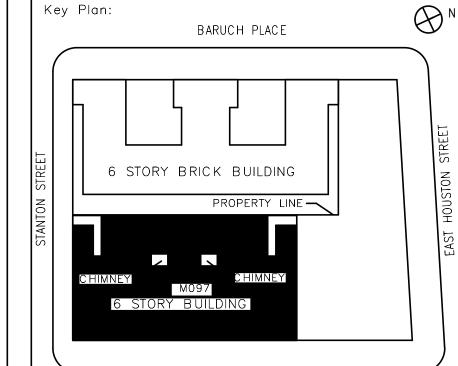
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NOTE: Drawing may be printed at reduced scale

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- 05/09/2023 ISSUED FOR BID

No. Date Revision



MANGIN STREET Block # 325

Lot # 25

NASER HAMOUDEH, P.E. SCA Design Manager: JEFFREY RABINER, PE Project Architect/Engineer: JOHN HIGGINS, PE GREGORY HERMAN

G. HERMAN / M. VARONA JOHN HIGGINS, PE Checked by:

Design No or LLW N lo.: Building ID: M097 D019998 05/09/2023

BARD COLLEGE HS, MANHATTAN WASTE SYSTEM

Address: 525 EAST HOUSTON STREET NEW YORK, NY 10002

Drawing Title:


MAIN ENTRANCE BALCONY REPAIR WORK

DOB NOW Job #M00660122-S1

Drawing No.: A403.00

Sheets in Contract Set: 25 of 42

Sheets in DOB Set: 22 of 37

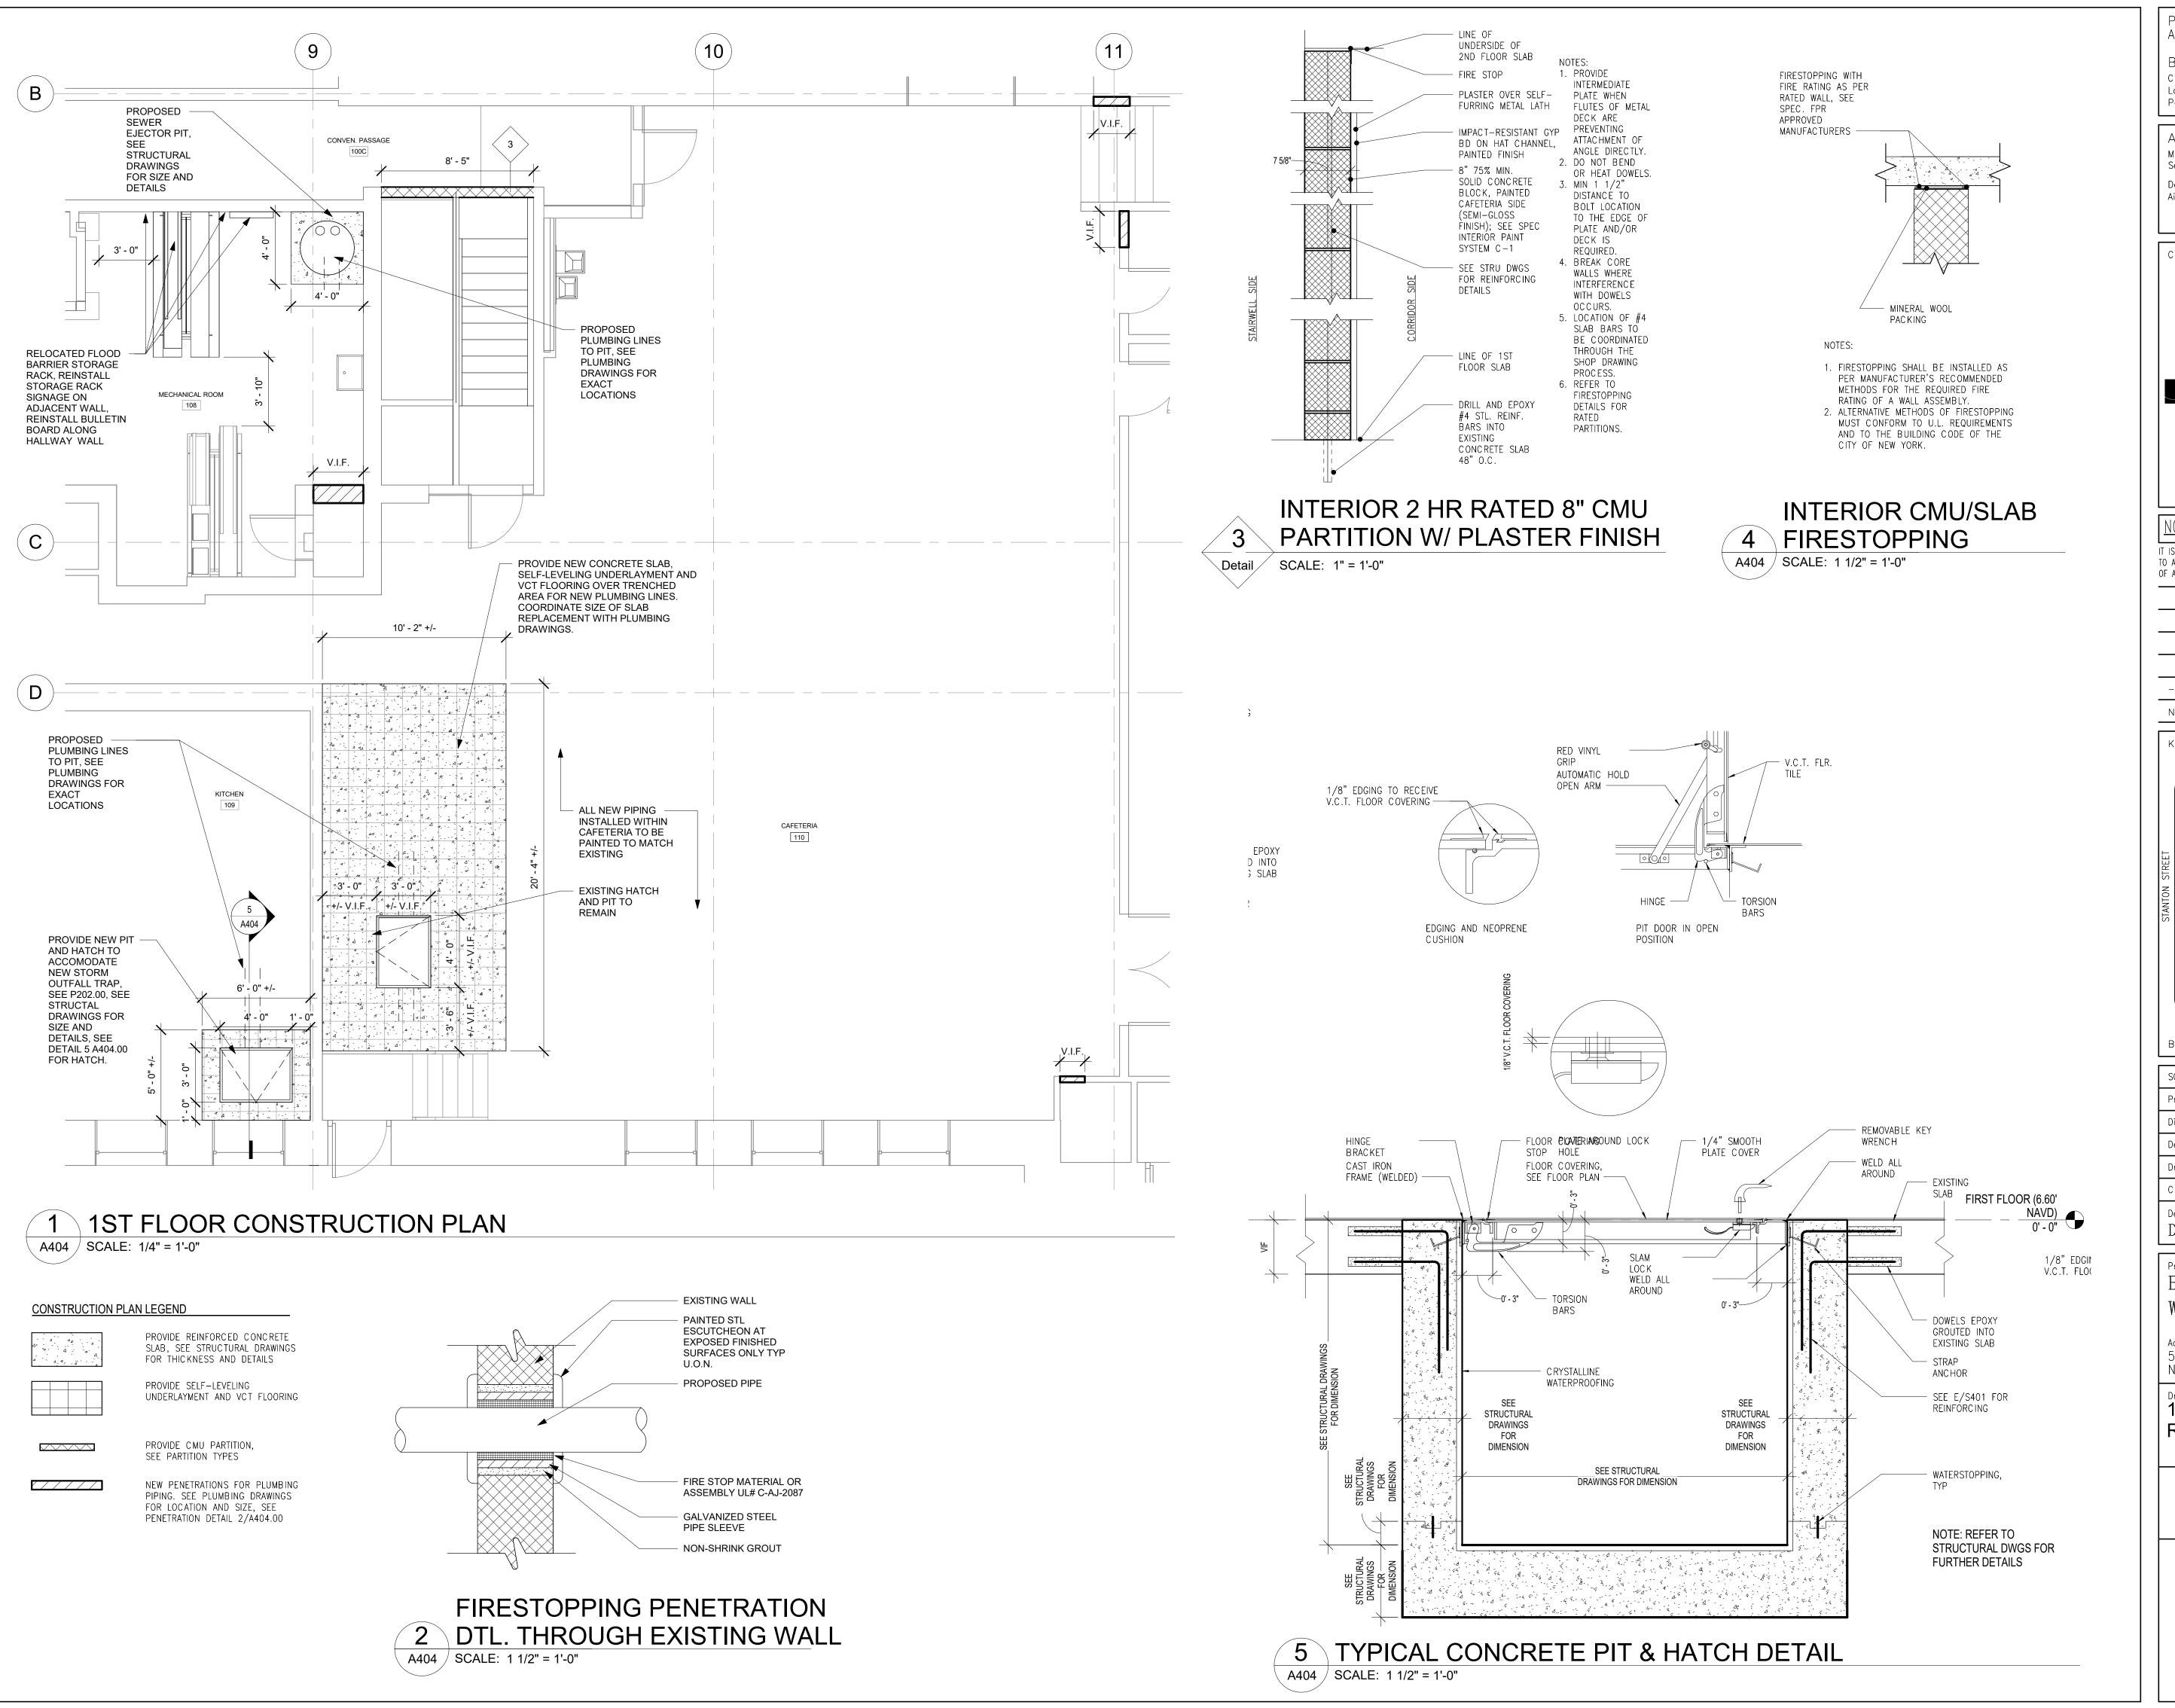

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Ysrael A. Seinuk
Structural Consultant
228 East 45th Street / New York, NY 10017
P 212.687.2233 / F 646.487.5555

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05 /00 /0007 100050 500 1

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No. Date Revision

Key Plan:

BARUCH PLACE

6 STORY BRICK BUILDING

PROPERTY LINE

CHIMNEY

M097

6 STORY BUILDING

MANGIN STREET

Block # 325

SCA Design Manager:

NASER HAMOUDEH, P.E.

Project Architect/Engineer:

JEFFREY RABINER, PE

Discipline Lead:

JOHN HIGGINS, PE

Designer:

GREGORY HERMAN

Drawn by: G. HERMAN / M. VARONA

Checked by: JOHN HIGGINS, PE

Design No or LLW No.: Building ID: Date: 05/09/2023

BARD COLLEGE HS, MANHATTAN WASTE SYSTEM

Address: 525 EAST HOUSTON STREET NEW YORK, NY 10002


Drawing Title: 1ST FLOOR CAFETERIA SLAB REPLACEMENT


DOB NOW Job #M00660122-S1

Drawing No.:
A404.00

Sheets in Contract Set: 26 of 42

Sheets in DOB Set: 23 of 37

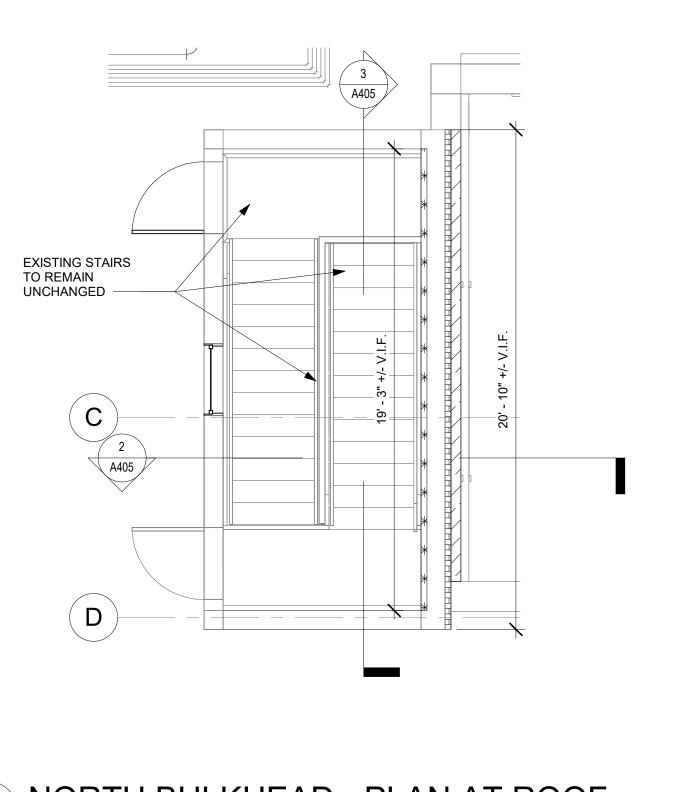

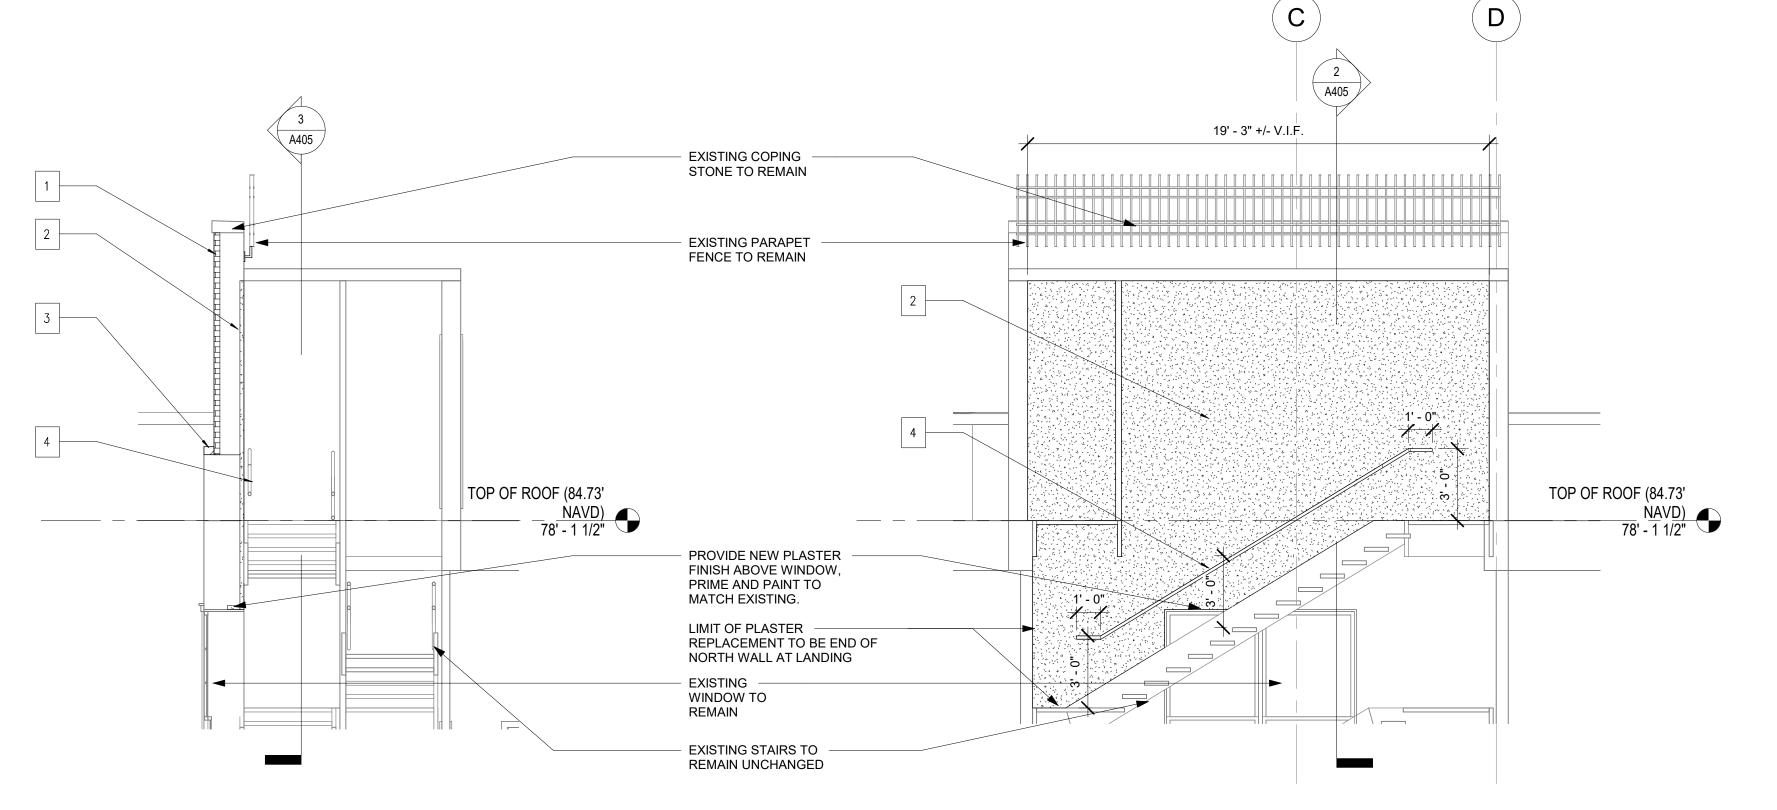


1 NORTH BULKHEAD - PLAN AT ROOF A405 SCALE: 1/4" = 1'-0"


2 SECTION 1 THROUGH NORTH BULKHEAD

A405 SCALE: 1/4" = 1'-0"

3 SECTION 2 THROUGH NORTH BULKHEAD

A405 SCALE: 1/4" = 1'-0"

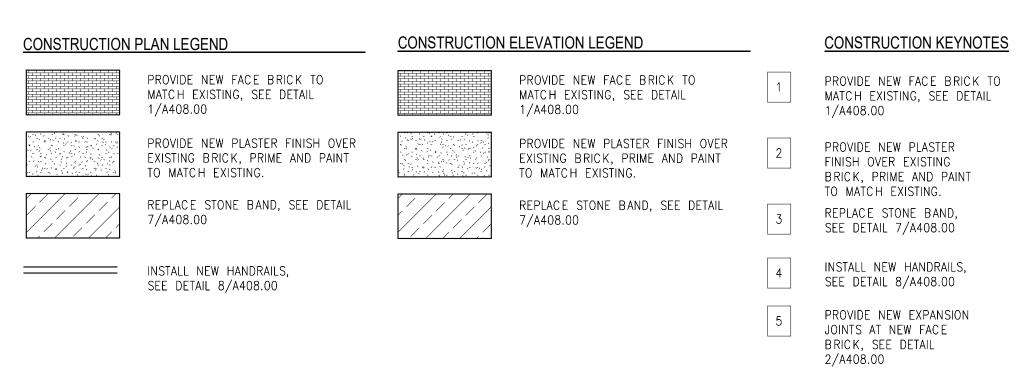

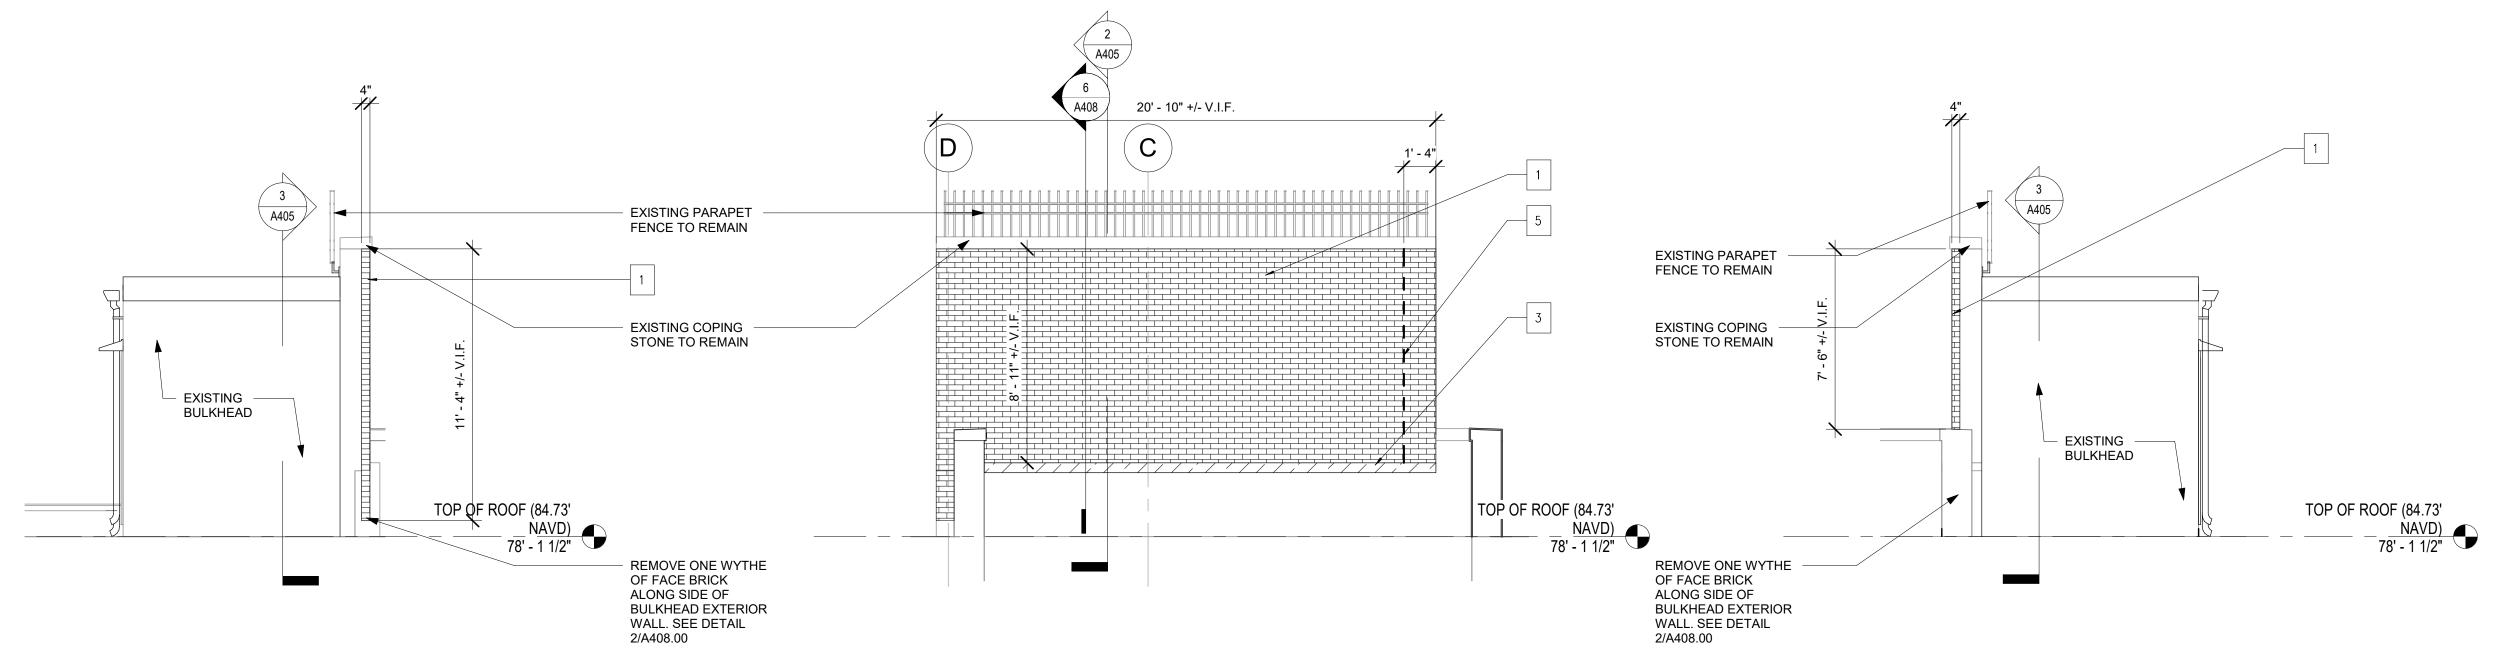

NORTH BULKHEAD
4 EAST ELEV CONSTRUCTION

A405 SCALE: 1/4" = 1'-0"

NORTH BULKHEAD
5 NORTH ELEV CONSTRUCTION

A405 SCALE: 1/4" = 1'-0"

NORTH BULKHEAD
6 WEST ELEV CONSTRUCTION

A405 SCALE: 1/4" = 1'-0"

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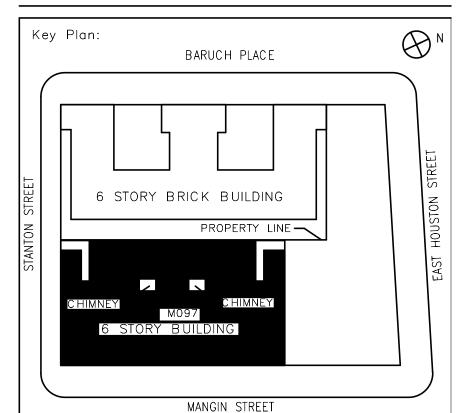
Ysrael A. Seinuk Structural Consultant 228 East 45th Street / New York, NY 10017 P 212.687.2233 / F 646.487.5555

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No. Date Revision



SCA Design Manager:

Project Architect/Engineer:

Discipline Lead:

Designer:

GREGORY HERMAN

Drawn by:

G. HERMAN / M. VARONA

Checked by:

JOHN HIGGINS, PE

Design No or LLW No.: Building ID: Date: 05/09/2023

BARD COLLEGE HS, MANHATTAN
WASTE SYSTEM

Address: 525 EAST HOUSTON STREET NEW YORK, NY 10002


NORTH BULKHEAD MASONRY
REPAIR

DOB NOW Job #M00660122-S1

Drawing No.: **A405.00**

Sheets in Contract Set: 27 of 42

Sheets in DOB Set: 24 of 37

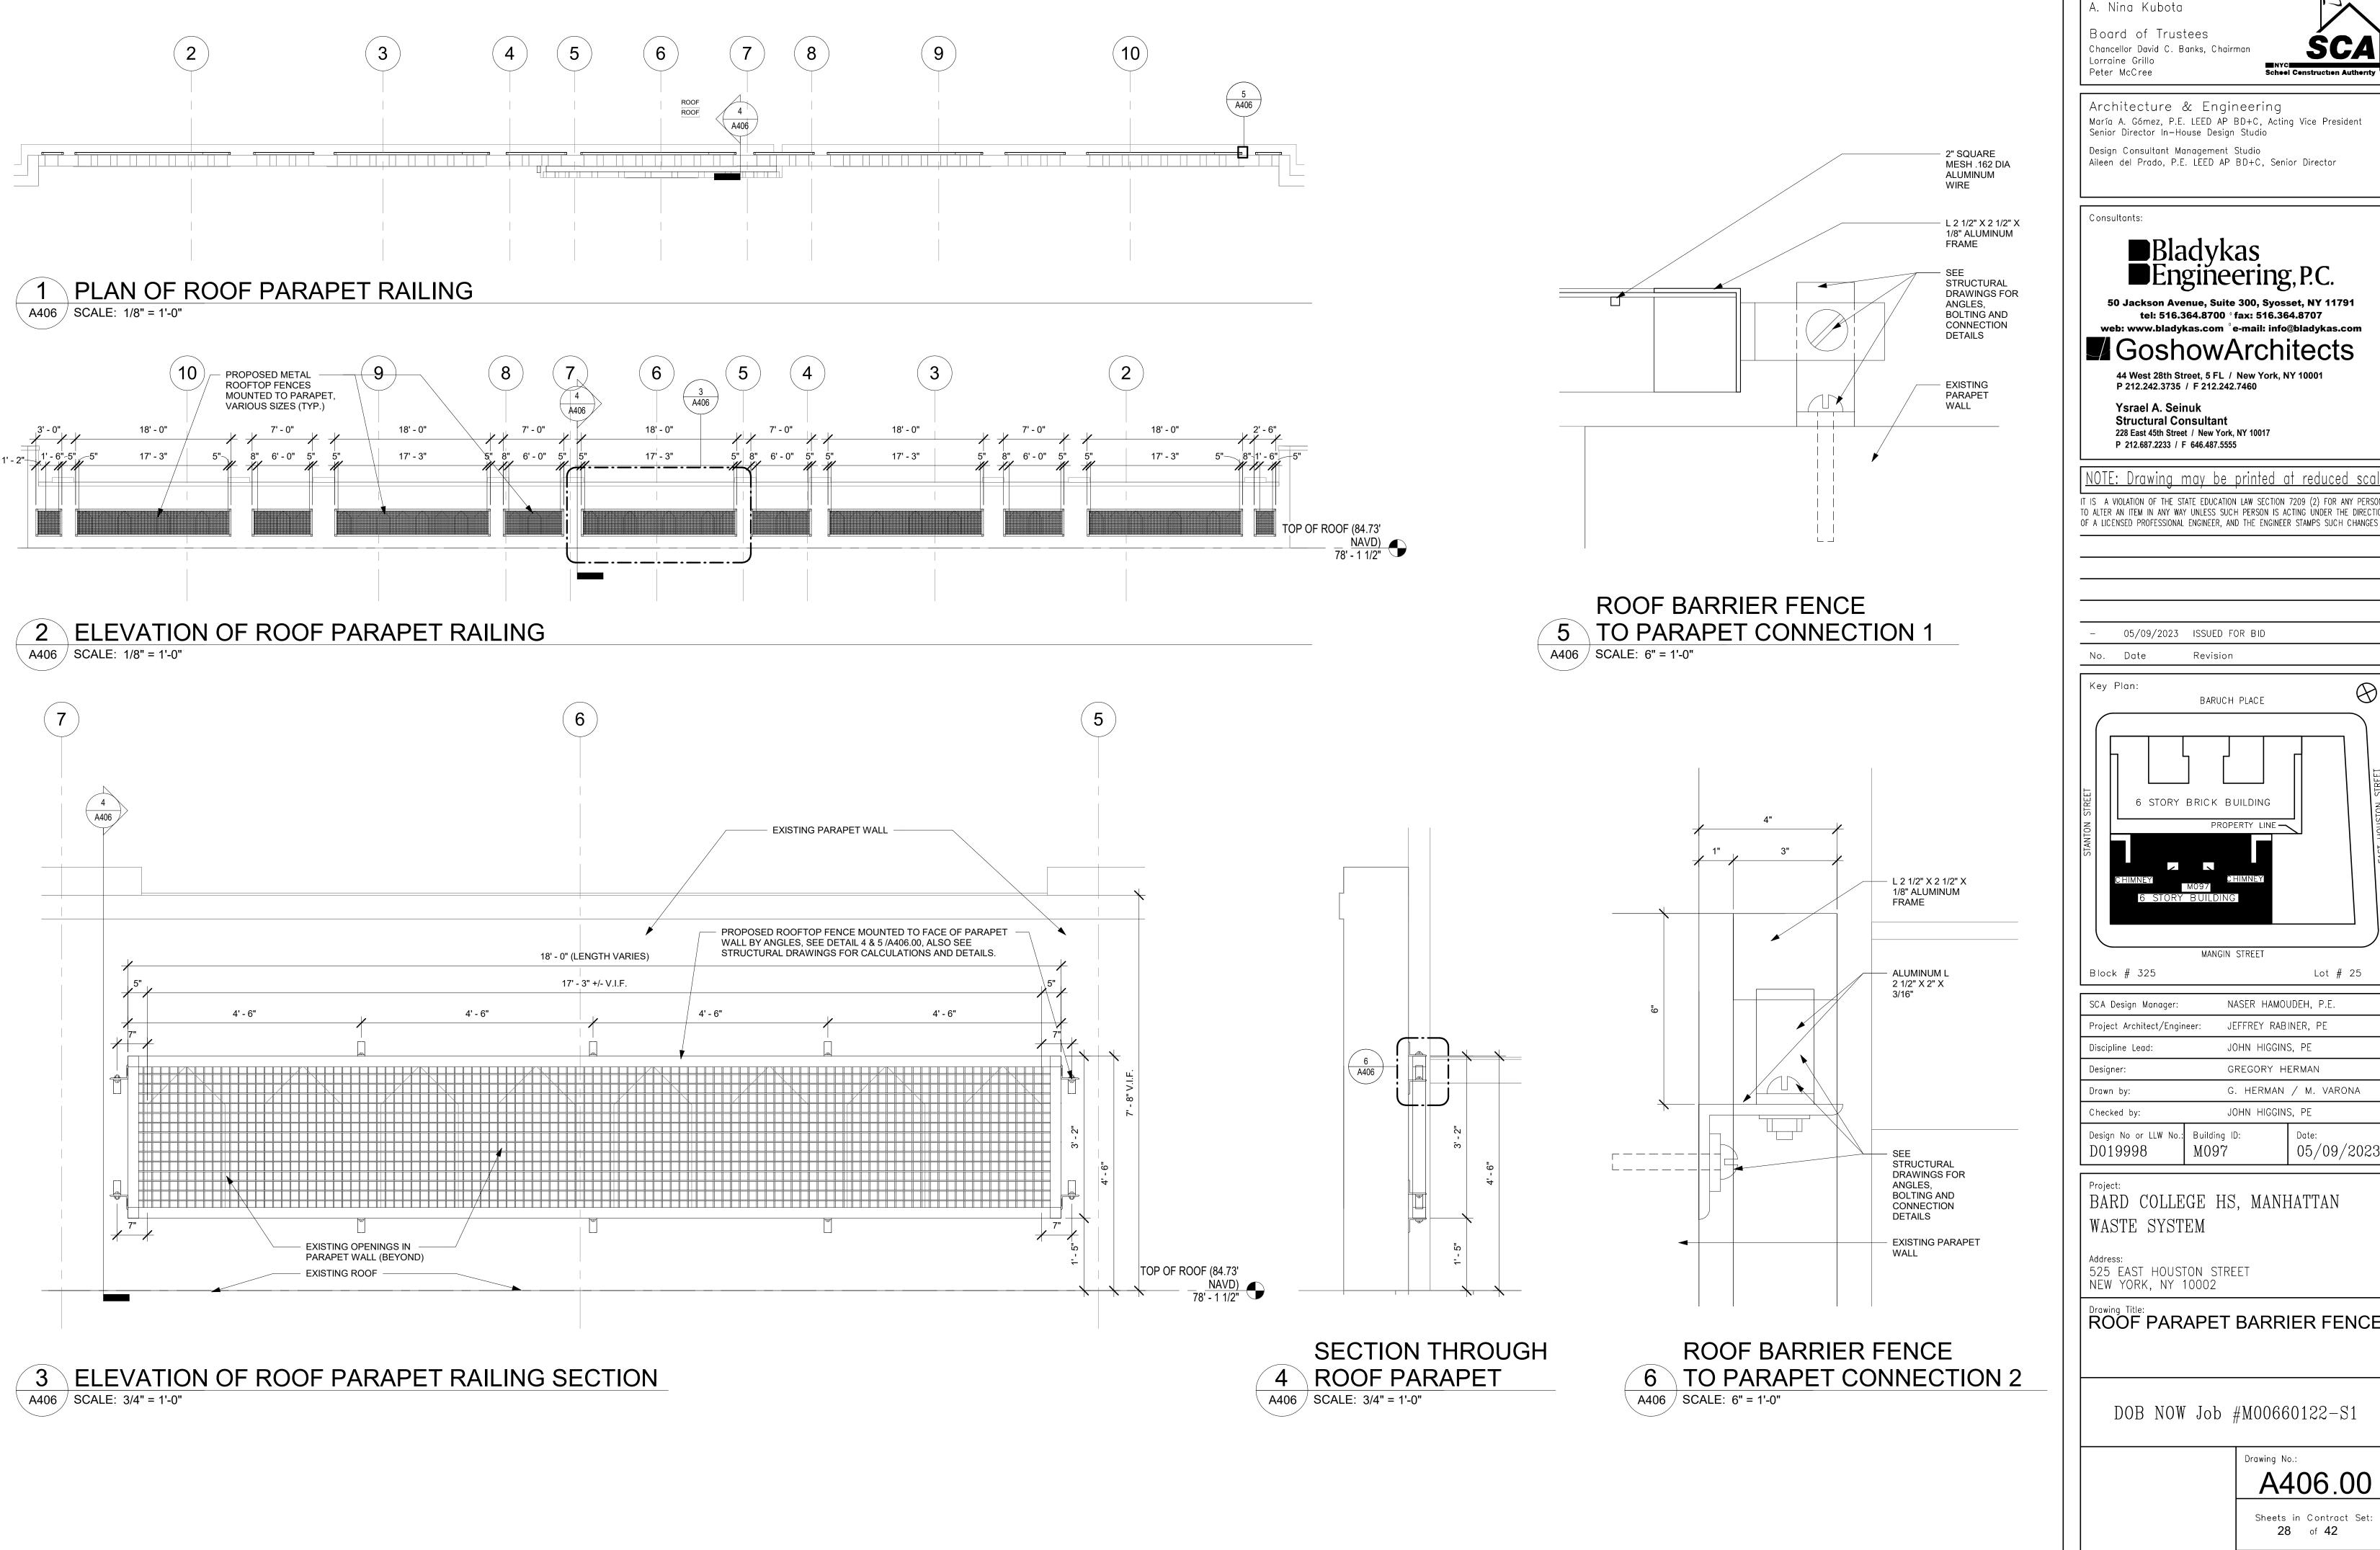

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Key Plan: BARUCH PLACE 6 STORY BRICK BUILDING

MANGIN STREET Block # 325

NASER HAMOUDEH, P.E. SCA Design Manager: JEFFREY RABINER, PE Project Architect/Engineer JOHN HIGGINS, PE GREGORY HERMAN

Lot # 25

G. HERMAN / M. VARONA JOHN HIGGINS, PE Checked by: Design No or LLW Building ID: M097 05/09/2023

BARD COLLEGE HS, MANHATTAN WASTE SYSTEM

525 EAST HOUSTON STREET NEW YORK, NY 10002


ROOF PARAPET BARRIER FENCE

DOB NOW Job #M00660122-S1

A406.00

Sheets in Contract Set: 28 of 42

Sheets in DOB Set: 25 of 37

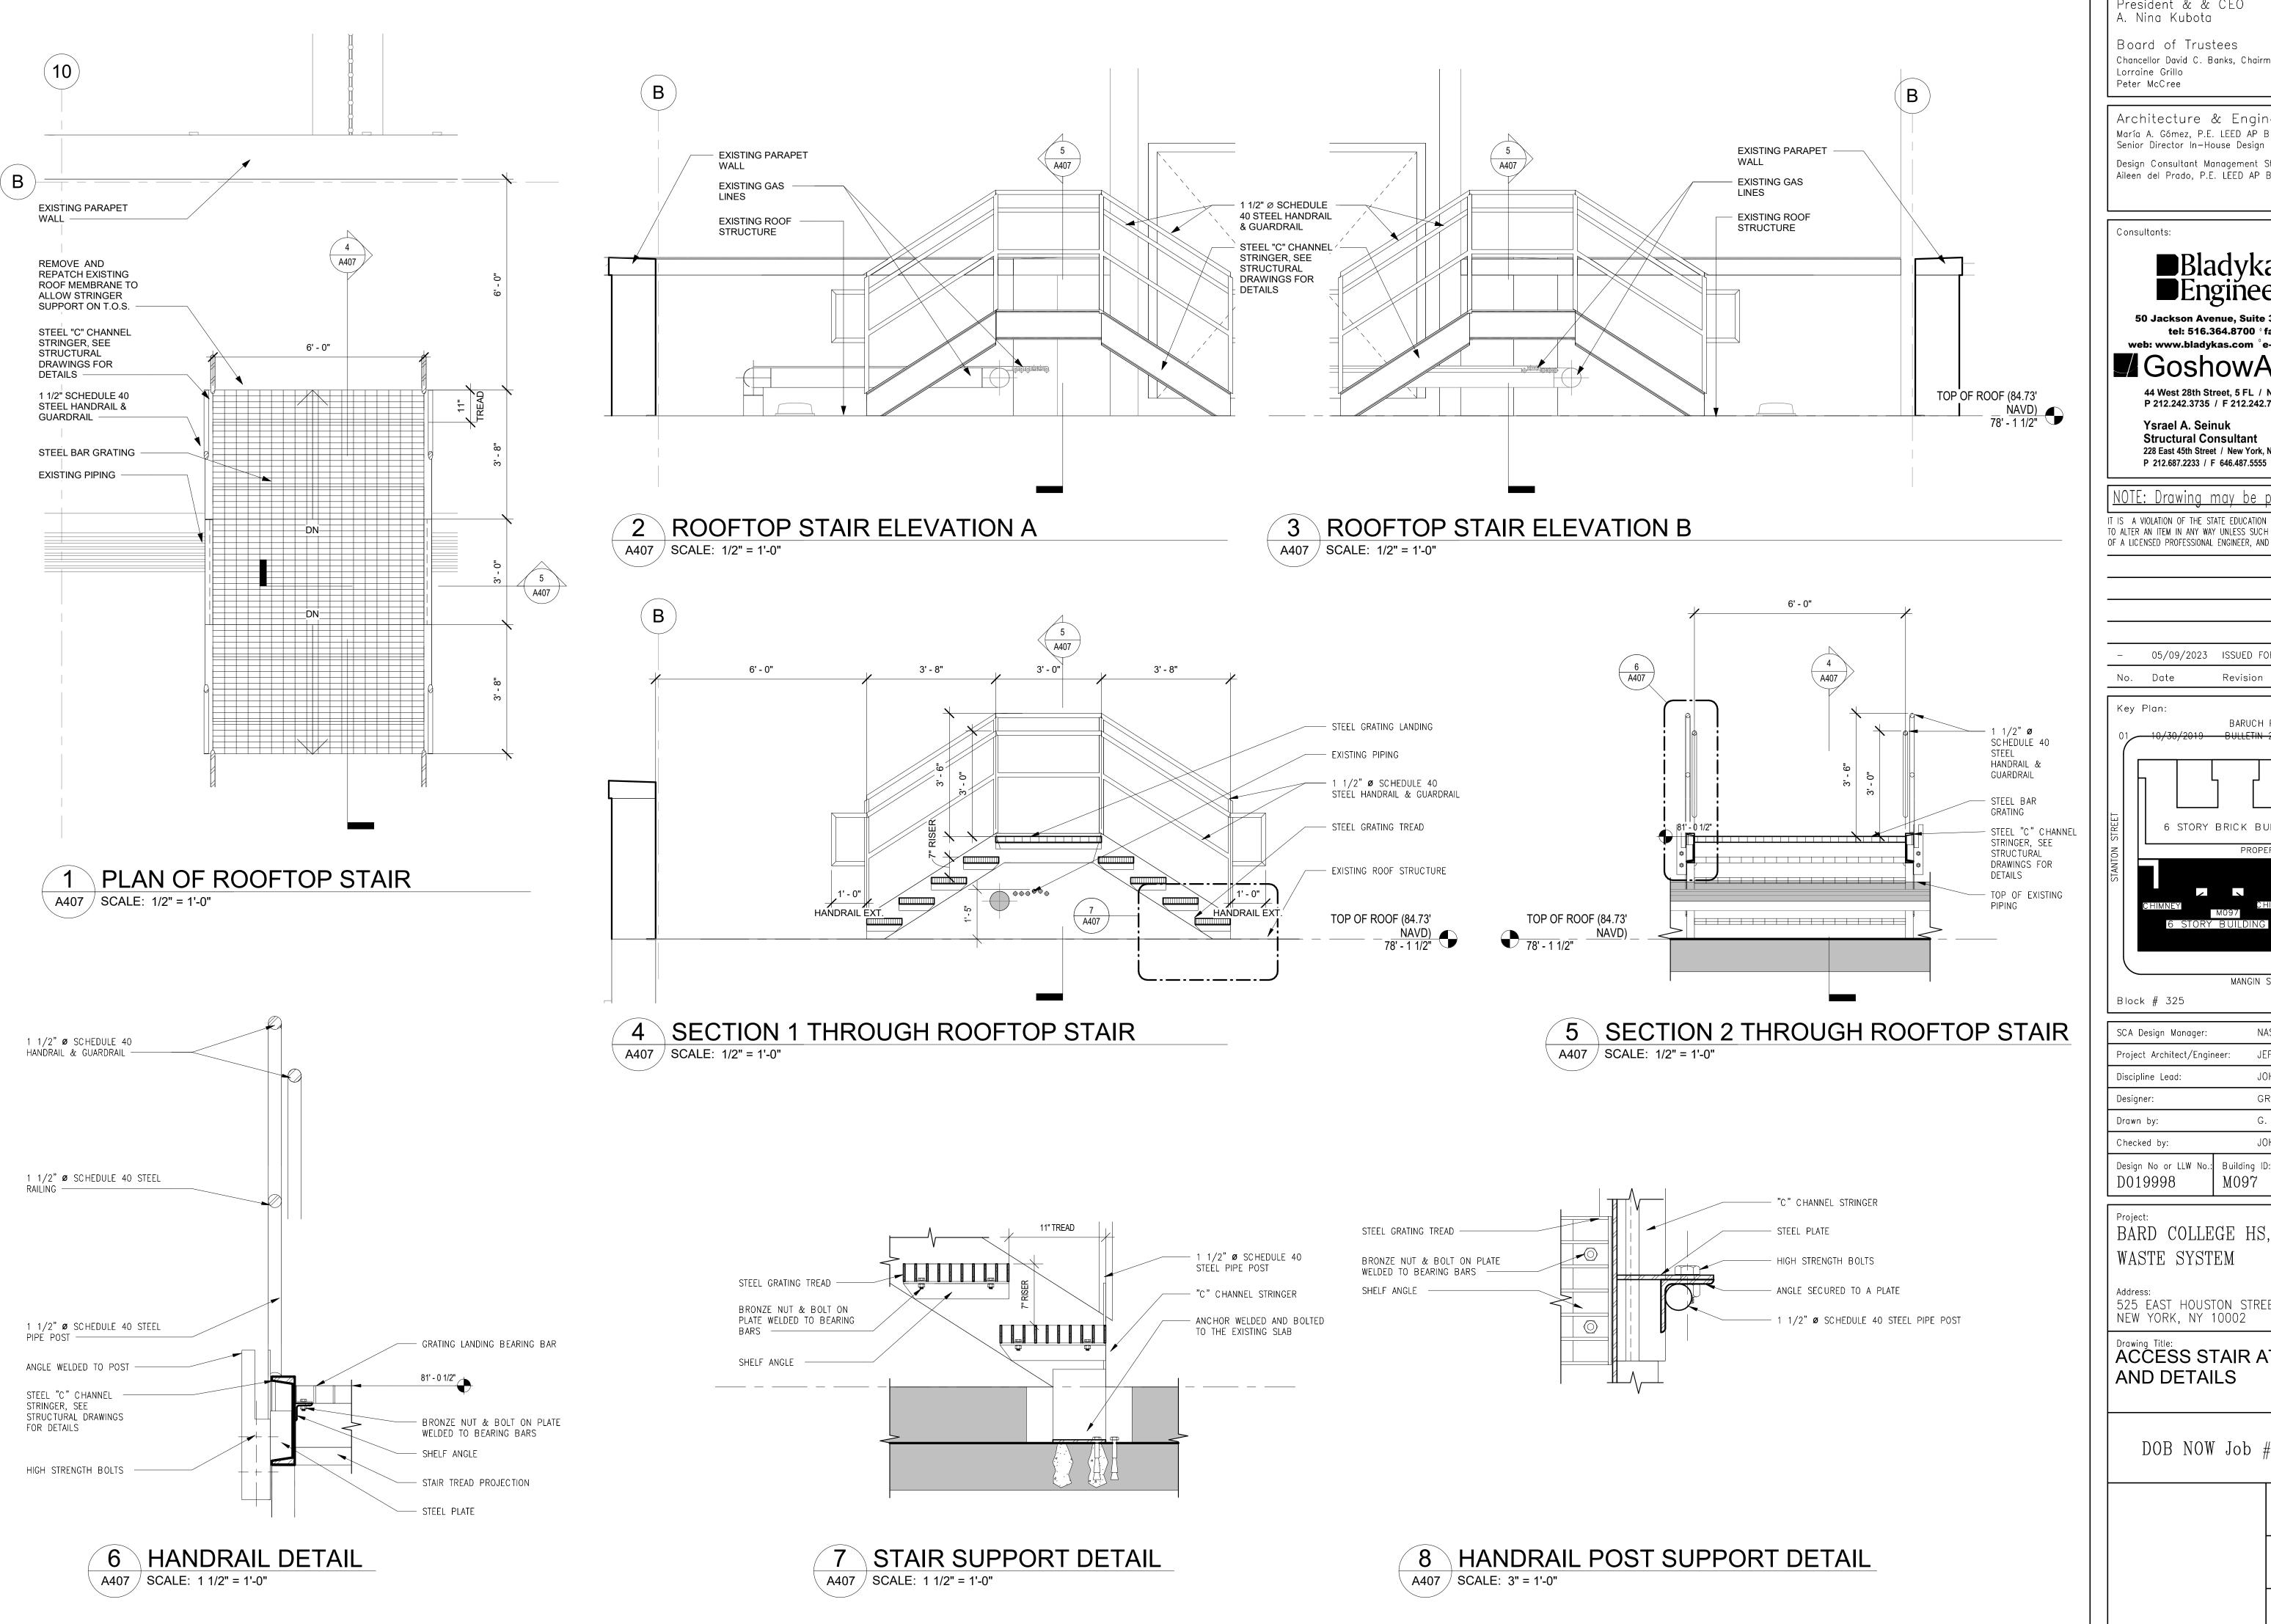

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Ysrael A. Seinuk **Structural Consultant** 228 East 45th Street / New York, NY 10017

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05/09/2023 ISSUED FOR BID

 \bigotimes N Key Plan: BARUCH PLACE 6 STORY BRICK BUILDING

MANGIN STREET

Lot # 25 NASER HAMOUDEH, P.E. SCA Design Manager Project Architect/Engineer JEFFREY RABINER, PE JOHN HIGGINS, PE GREGORY HERMAN G. HERMAN / M. VARONA

JOHN HIGGINS, PE Checked by: Design No or LLW Building ID: Date: M097 05/09/2023 D019998

BARD COLLEGE HS, MANHATTAN WASTE SYSTEM

525 EAST HOUSTON STREET NEW YORK, NY 10002


ACCESS STAIR AT ROOFTOP AND DETAILS

DOB NOW Job #M00660122-S1

Drawing No.: A407.00


Sheets in Contract Set: **29** of **42**

Sheets in DOB Set: **26** of **37**

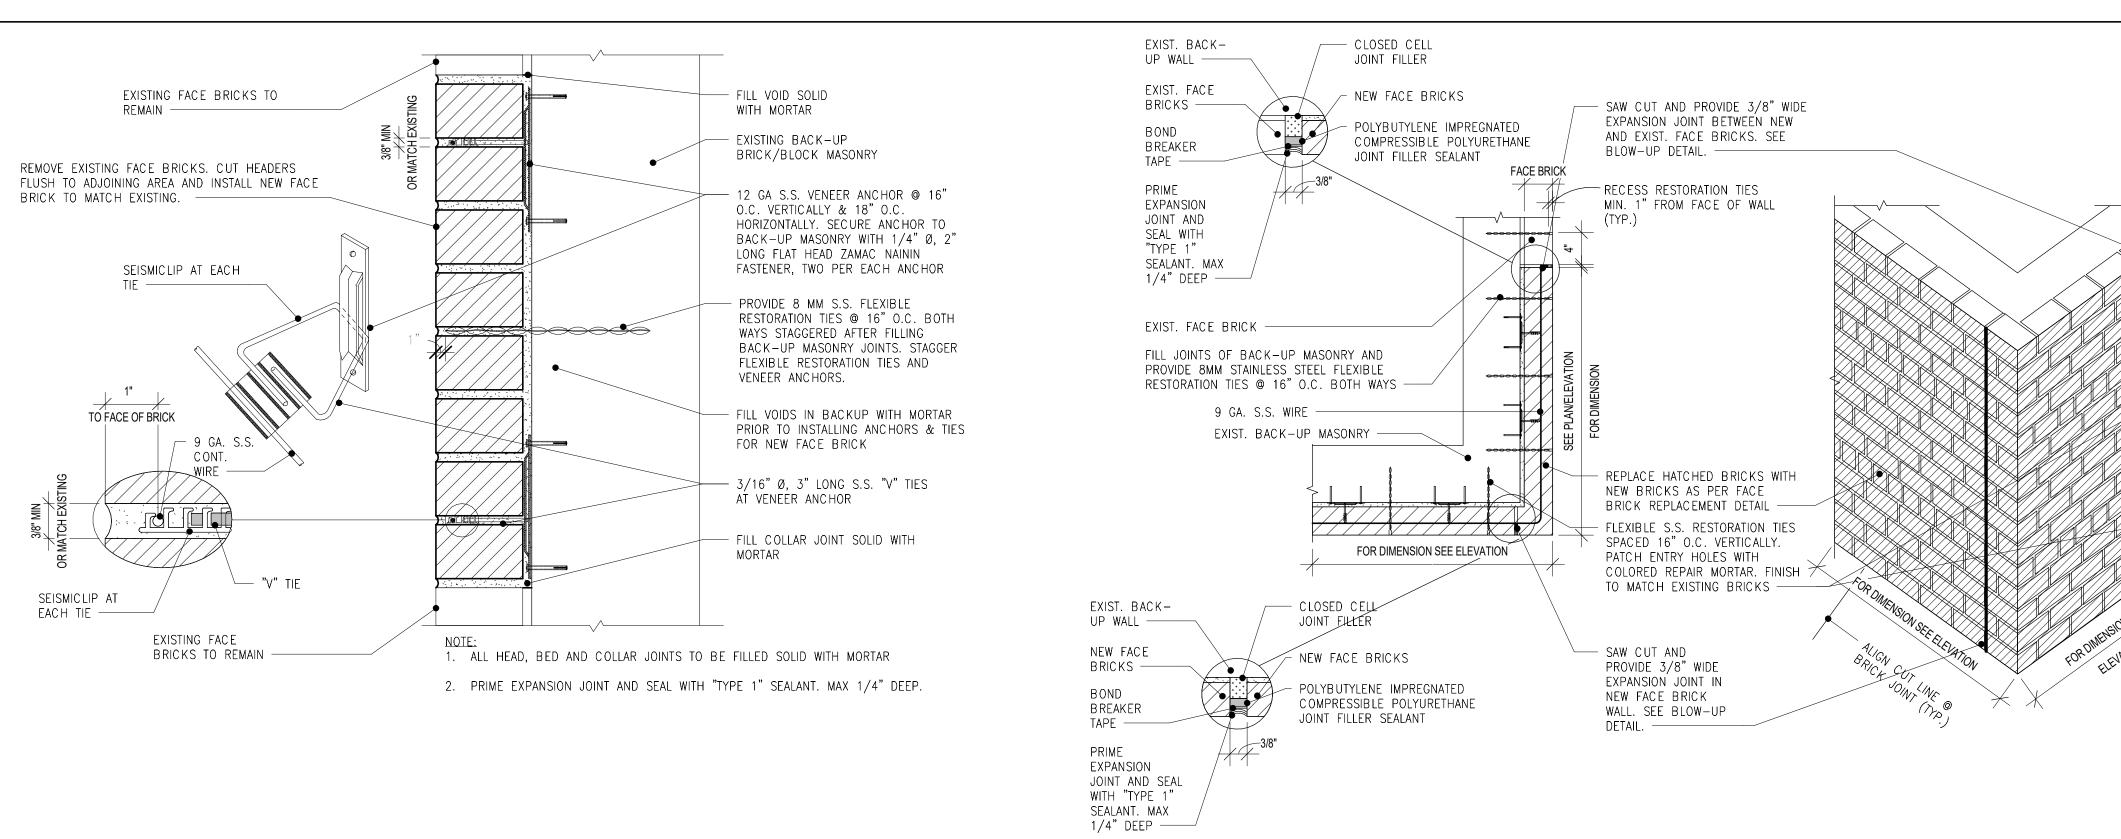


FACE BRICK REPLACEMENT DETAIL

CORNER BRICK REPLACEMENT DETAIL A408 / SCALE: 3" = 1'-0" A408 / SCALE: 1" = 1'-0"

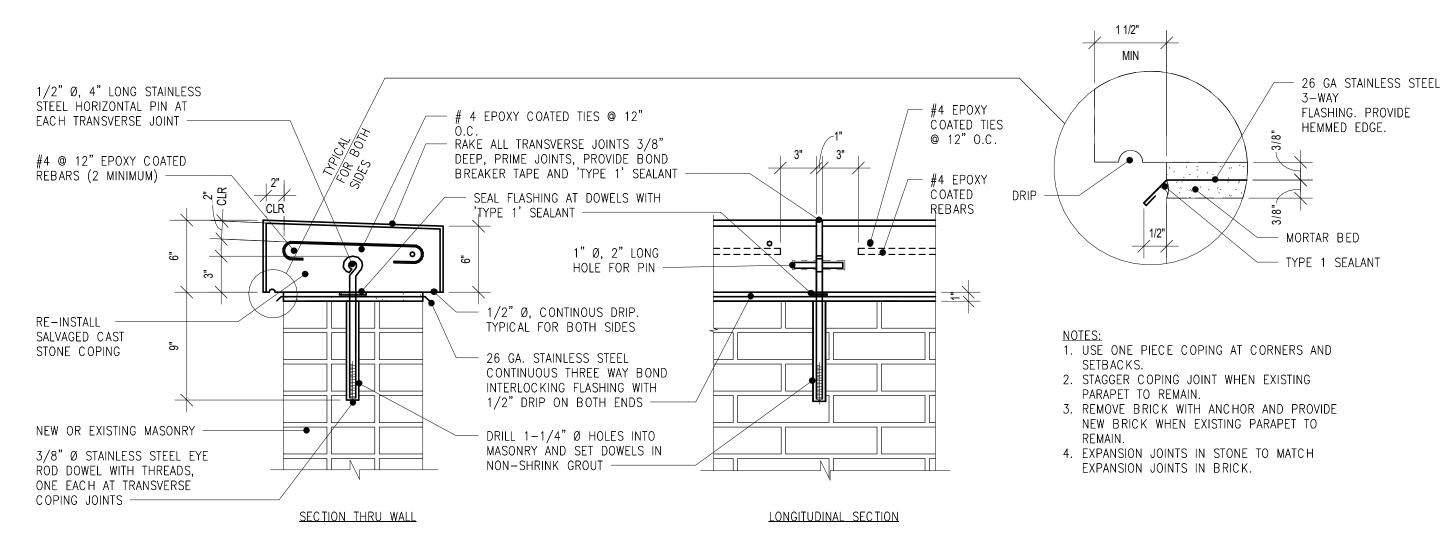



CAST STONE COPING DETAIL A408 / SCALE: 1 1/2" = 1'-0"

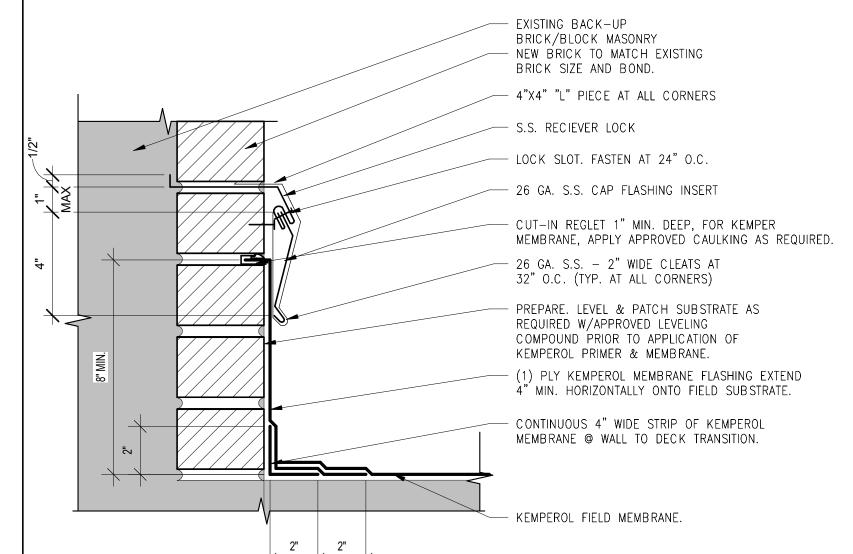

REAR STAIR FLASHING DETAIL

A408 SCALE: 3" = 1'-0"

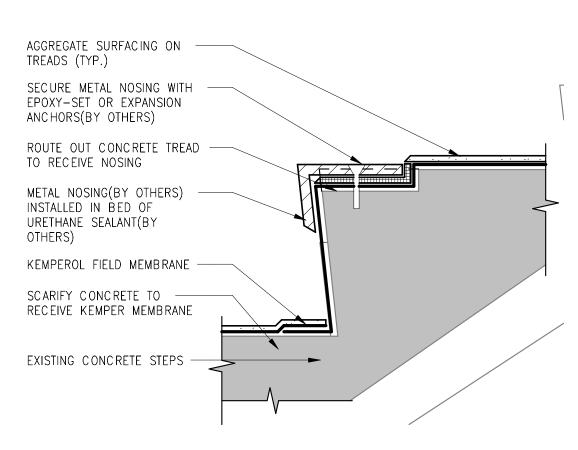

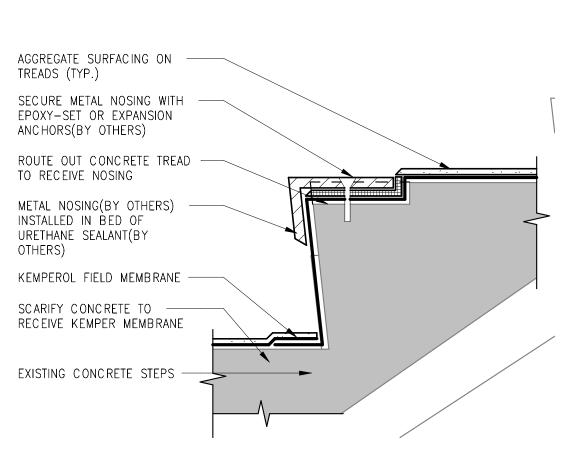

5 STAIR TREAD DETAIL A408 / SCALE: 3" = 1'-0"

6 BULKHEAD MASONRY REPLACEMENT A408 / SCALE: 3/4" = 1'-0"

NORTH

BULKHEAD

PROVIDE NEW

PLASTER FINISH

OVER EXISTING

BRICK, PRIME

AND PAINT TO MATCH EXISTING

EXIST. HEADERS

REMOVE/REPLACE

BETWEEN HEADER

REMOVE/REPLACE

(1) ROW OF BRICKS —

COPPER/FABRIC

FLASHING.

24GA. S.S

EXIST. STONE

TO REMAIN -

BAND COURSE

VERIFY EXISTING

FLASHING -

FLASHING

FACE BRICKS


COURSES, SEE

FACE BRICK

REPLACEMENT

DETAIL ---

TO REMAIN -

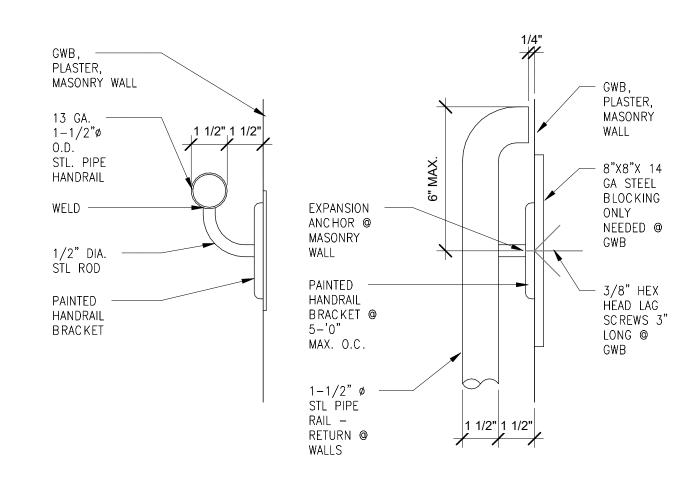

1. UPON REMOVAL OF

FACE BRICKS, FILL

BACK-UP MASONRY

JOINT TIGHT USING

PRIOR TO INSTALLING

ANCHORS AND TIES.


COLLAR JOINTS TO BE FILLED SOLID

TYPE N MORTAR

2. ALL HEAD, BED AND

WITH MORTAR.

8 TYP. HANDRAIL PLAN & SECTION A408 / SCALE: 3" = 1'-0"

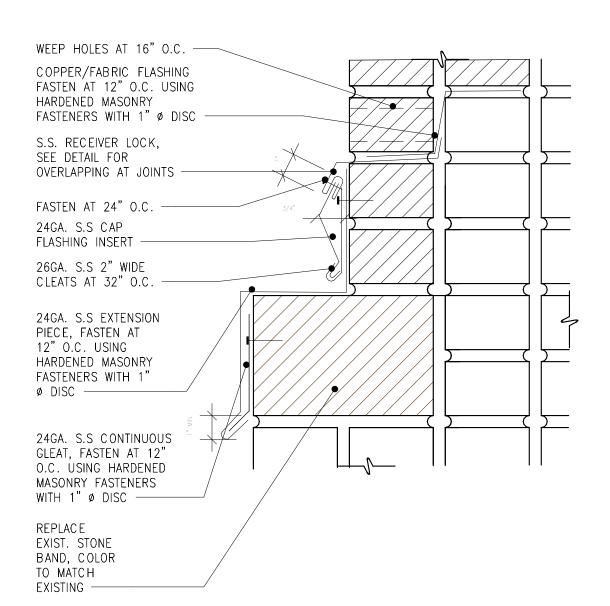

SLATE LEDGE FLASHING DETAIL A408 / SCALE: 3" = 1'-0"

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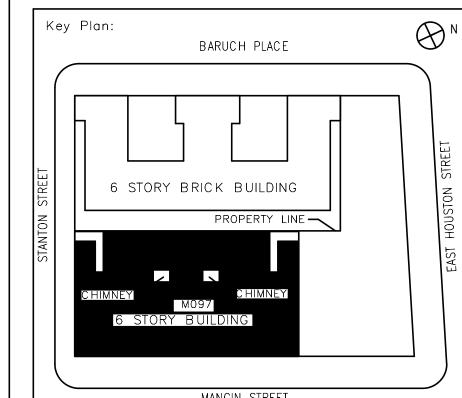
Ysrael A. Seinuk Structural Consultant 228 East 45th Street / New York, NY 10017 P 212.687.2233 / F 646.487.5555

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05/09/2023 ISSUED FOR BID

No. Date Revision



MANGIN STREET

Block # 325 Lot # 25 NASER HAMOUDEH, P.E. SCA Design Manager Project Architect/Engineer JEFFREY RABINER, PE JOHN HIGGINS, PE Discipline Lead: GREGORY HERMAN Designer:

G. HERMAN / M. VARONA Drawn by: JOHN HIGGINS, PE Checked by: Building ID: Date: Design No or LLW M097 05/09/2023 D019998

BARD COLLEGE HS, MANHATTAN WASTE SYSTEM

525 EAST HOUSTON STREET NEW YORK, NY 10002

MASONRY DETAILS

DOB NOW Job #M00660122-S1

Drawing No.: A408.00

> Sheets in Contract Set: 30 of 42

Sheets in DOB Set: **27** of **37**

LIGHTING AND POWER

SYMBOL	DESCRIPTION
2,4	CONDUIT WITH WIRE RUN EXPOSED IN CEILING OR WALL. HASHMARKS DENOTE NUMBER OF WIRES IF MORE THAN TWO ARE REQUIRED. ARROWS DENOTE HOMERUNS OF PARTICULAR CIRCUITS AND QUANTITY OF 1P-20A CIRCUITS. MINIMUM 2#12 THHN / THWN IN 3/4" CONDUIT U.O.N.
	LIGHTING AND POWER PANELBOARD, SURFACE MOUNTED ON WALL.
F 30/15	DISCONNECT SWITCH, RATING AND FUSING NOTED. HORSEPOWER RATING AS REQUIRED BY MOTOR LOAD. 'WP' INDICATES WEATHERPROOF ENCLOSURE, OTHERWISE NEMA-1. INSCRIBED 'F' INDICATES FUSIBLE TYPE.
5	MOTOR. HORSEPOWER INSCRIBED.

GENERAL NOTES:

THE FOLLOWING NOTES SHALL APPLY THROUGHOUT. EXCEPTIONS ARE SPECIFICALLY NOTED ON EACH DRAWING:

- 1. THE CONTRACTOR SHALL FIELD VERIFY ALL DIMENSIONS AND CONDITIONS OF THE SITE AND/OR
- 2. THE CONTRACTOR SHALL, UNLESS OTHERWISE PROVIDED IN THE CONTRACT DOCUMENTS, SECURE AND PAY FOR THE REQUIRED CONSTRUCTION PERMIT(S), FEES, LICENCES AND INSPECTIONS NECESSARY FOR THE PROPER EXECUTION OF THE WORK.
- 3. COORDINATION OF ALL WORK UNDER THIS CONTRACT SHALL BE MAINTAINED TO ENSURE THE QUALITY AND TIMELY COMPLETION OF THE WORK/PROJECT.
- 4. THE CONTRACTOR SHALL PERFORM ALL CUTTING AND PATCHING REQUIRED TO COMPLETE THE WORK OR TO MAKE ITS PARTS FIT TOGETHER PROPERLY WITHOUT COMPROMISING THE QUALITY OF THE WORK.
- 5. THE CONTRACTOR SHALL BE RESPONSIBLE FOR ADEQUATELY BRACING AND PROTECTING ALL WORK DURING CONSTRUCTION AGAINST DAMAGE, BREAKAGE, COLLAPSE, DISTORTIONS, AND OFF ALIGNMENTS ACCORDING TO CODES AND STANDARDS OF GOOD PRACTICE.
- 6. THE TERM "FINISH FLOOR" SHALL MEAN THE NORMAL FINISHED SURFACE OF THE FLOOR LEVEL. ALL ELEVATIONS GIVEN FOR EXISTING BUILDINGS ARE TO FINISHED FLOOR. THE CONTRACTOR SHALL FIELD VERIFY ALL ELEVATIONS FOR EXISTING STRUCTURES PRIOR TO THE COMMENCMENT OF WORK.
- 7. THE CONTRACTOR SHALL PATCH AND REPAIR ALL FLOORS, WALLS CEILINGS, ETC.. DAMAGED OR EXPOSED DUE TO WORK OR REMOVALS AND FINISH TO MATCH ADJOINING SURFACES.

- 8. WHERE MANUFACTURES' NAMES AND PRODUCT NUMBERS ARE INDICATED ON THE DRAWINGS, IT SHALL BE CONSTRUED TO MEAN THE ESTABLISHING OF QUALITY AND PERFORMANCE STANDARDS OF SUCH ITEMS. ALL OTHER PRODUCTS MUST BE SUBMITTED TO THE ARCHITECT FOR APPROVAL BEFORE THEY SHALL BE DEEMED EQUAL.
- FIRESTOPPING SHALL BE INSTALLED AT ALL PENETRATIONS OF FIRE RATED CONSTRUCTION AS PER SPECIFICATIONS. MATERIAL IS TO BE APPROPRIATE FOR THE ASSEMBLY AND SHALL HAVE AN MEA NUMBER.
- 10. ADDITIONAL NOTES THAT ARE APPLICABLE TO THIS PROJECT MAY BE FOUND THROUGHOUT THE CONTRACT
- 11. FOR AN EXPLANATION OF THE SYMBOLS AND ABBREVIATIONS USED ON THESE DRAWINGS, SEE THE SYMBOLS LIST AND ABBREVIATION LIST ON THIS SHEET.
- 12. CONDUITS RUN IN FLOOR OF CORRIDORS SHALL CLEAR RECESSED DOOR CLOSERS LOCATED AT CROSS CORRIDOR DOORS. CONDUITS RUN IN CORRIDOR HUNG CEILINGS SHALL CLEAR SPACE FOR ROLLER BOX OF ROLLING GRILL.
- 13. PULL AND JUNCTION BOXES SHALL BE SURFACE TYPE, UNLESS OTHERWISE NOTED. THE JUNCTION AND PULL BOXES SHALL BE LOCATED APPROXIMATELY WHERE INDICATED ON THE PLAN TO SUIT CONDUIT ENTRANCE, BUT SHALL, IN ALL CASES, BE LOCATED TO AVOID INTERFERENCE WITH ALL OTHER EQUIPMENT AND SHALL BE LOCATED SO THAT COVERS ARE READILY ACCESSIBLE.
- 14. SPECIAL INSPECTIONS SHALL BE CARRIED OUT IN ACCORDANCE WITH APPLICABLE BUILDING CODE SECTIONS.

REMOVALS

_		
	SYMBOL	DESCRIPTION
Ī	(<u>j</u>)	DASHED SYMBOL INDICATES EXISTING DEVICE TO BE REMOVED. INSTALL OUTLET COVER/BLANK PLATE.
	<i>55)</i> /	DASHED SYMBOL WITH HATCHING INDICATES EXISTING DEVICE TO BE REMOVED. INSTALL OUTLET COVER/BLANK PLATE.
	(J) _{ER}	DASHED SYMBOL WITH SUBSCRIPT 'ER' INDICATES EXISTING DEVICE TO REMAIN.

SCOPE OF WORK

THE WORK SHALL BE AS SHOWN AND CALLED FOR IN THE CONTRACT DOCUMENTS AND SHALL INCLUDE, BUT NOT BE LIMITED TO, THE FOLLOWING GENERAL ITEMS OF WORK:

PROVIDE POWER TO THE NEW DUPLEX SEWER EJECTOR PUMP CONTROL PANEL VIA A NEW 30A DISCONNECT SWITCH.

President & CEO A. Nina Kubota

Lorraine Grillo Peter McCree

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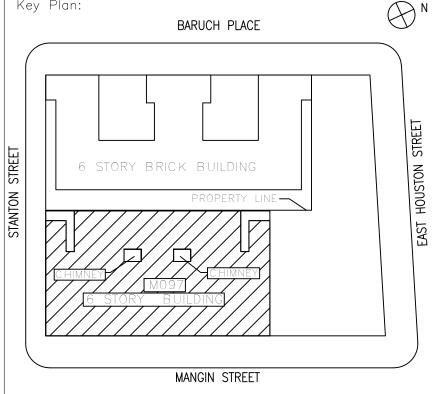
Ysrael A. Seinuk **Structural Consultant** 228 East 45th Street / New York, NY 10017 P 212.687.2233 / F 646.487.5555

NOTE: Drawing may be printed at reduced scale

IT IS A VIOLATION OF THE STATE EDUCATION LAW SECTION 7209 (2) FOR ANY PERSON TO ALTER AN ITEM IN ANY WAY UNLESS SUCH PERSON IS ACTING UNDER THE DIRECTION OF A LICENSED PROFESSIONAL ENGINEER, AND THE ENGINEER STAMPS SUCH CHANGES

05/09/2023 ISSUED FOR BID

No. Date Revision Key Plan: BARUCH PLACE



NASER HAMOUDEH, P.E. SCA Design Manager: JEFFREY RABINER, P.E. Project Architect/Engineer: JOHN HIGGINS, P.E. Discipline Lead: BRIAN HIGGINS Designer: BRIAN HIGGINS Drawn by: JOHN HIGGINS, P.E. Checked by: Design No or LLW No.: | Building ID:

BARD COLLEGE HS, MANHATTAN WASTE SYSTEM

525 EAST HOUSTON STREET NEW YORK, NY 10002

Block # 325

D019998

Drawing Title: FIRST FLOOR ELECTRICAL NOTES AND SYMBOL LIST


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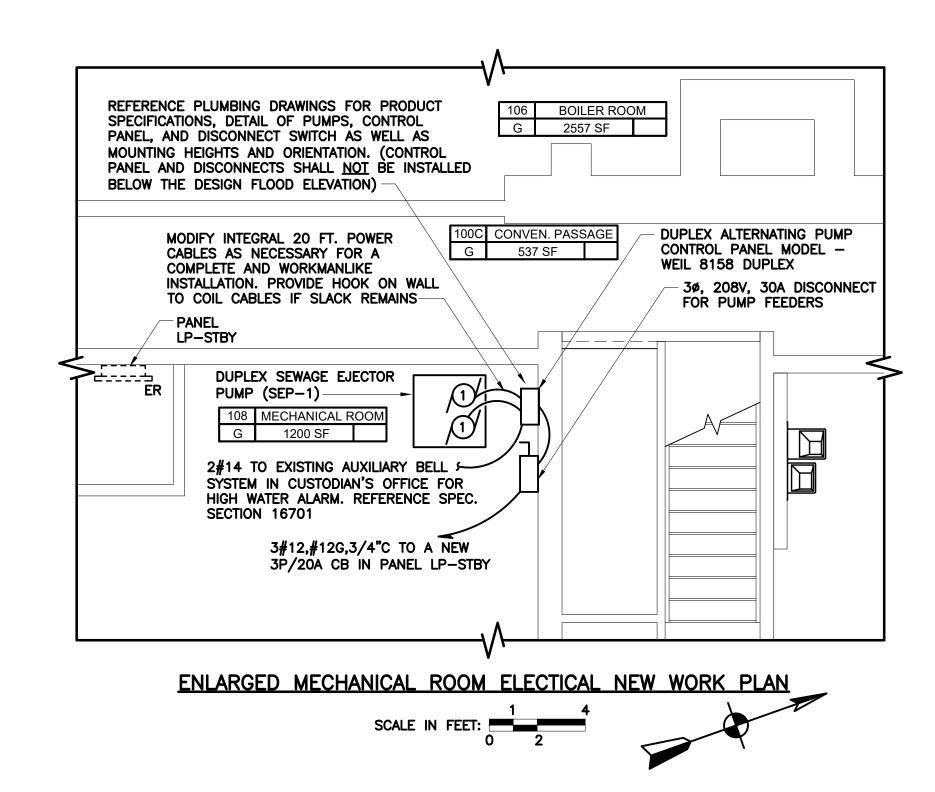
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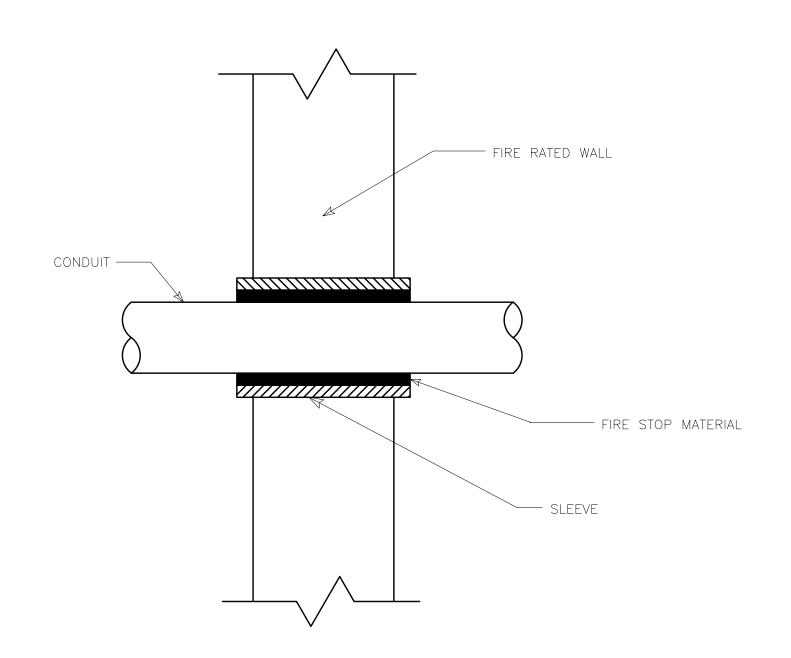
05/09/2023

Sheets in Contract Set: 41 of 42

Sheets in DOB Set: - of 37





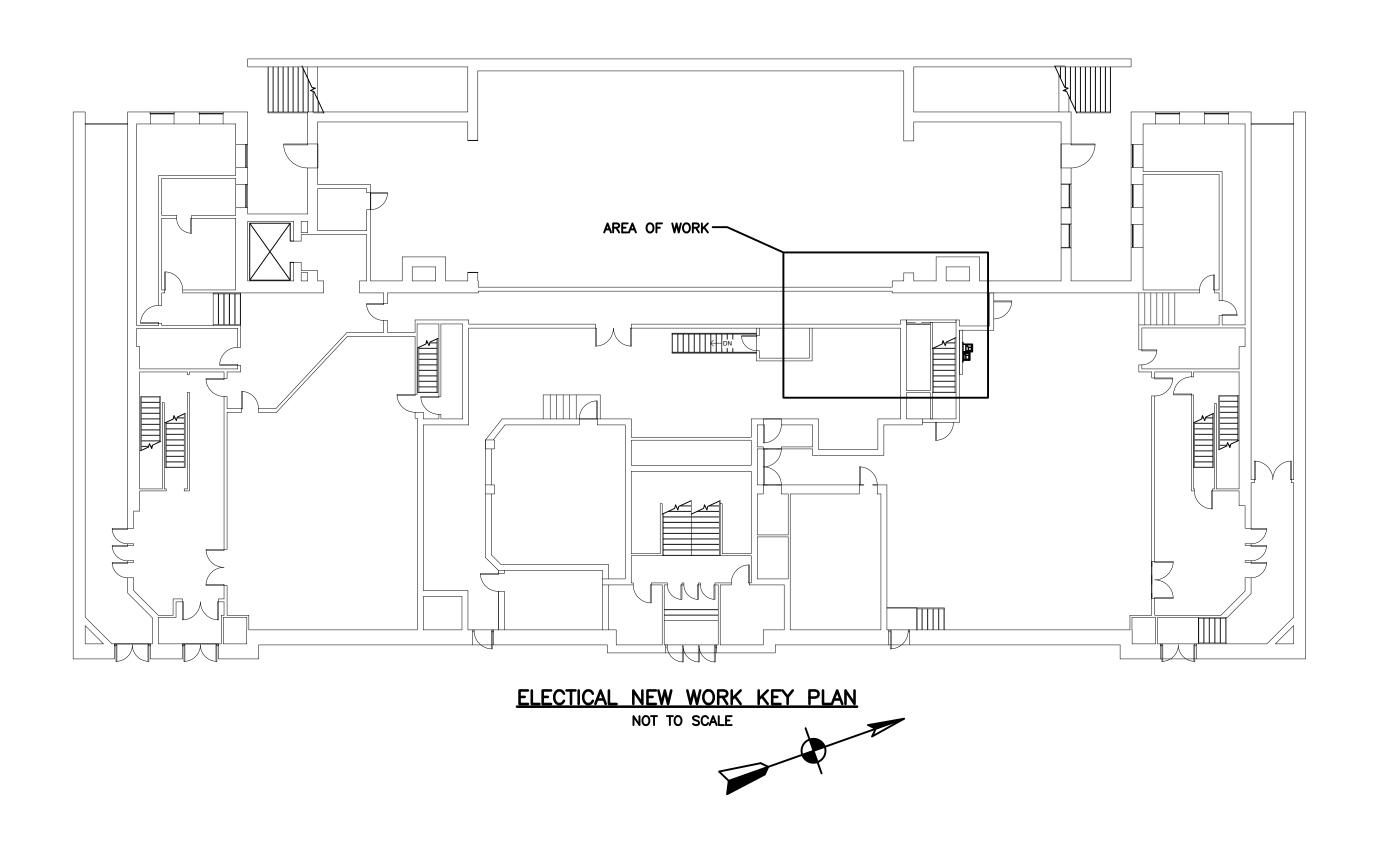

CONDUIT PENETRATION
CONDUIT PENETRATION THRU FIRE RATED WALL

NOT TO SCALE

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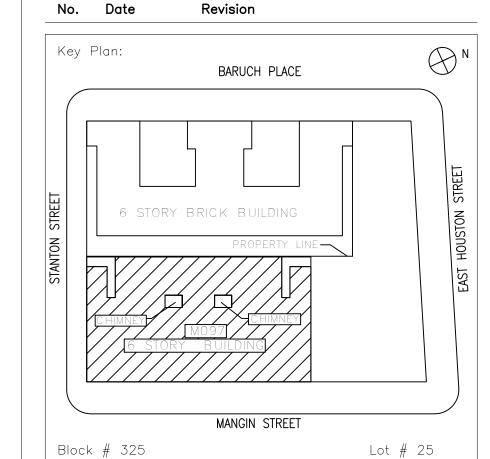
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Project Architect/Engineer:		JEFFREY RABIN	NER, P.E.
Discipline Lead:		JOHN HIGGINS	, P.E.
Designer:		BRIAN HIGGINS	3
Drawn by:		BRIAN HIGGINS	3
Checked by:		JOHN HIGGINS	, P.E.
Design No or LLW No.:	Buildina	ID:	Date:

BARD COLLEGE HS, MANHATTAN WASTE SYSTEM

M097

Address: 525 EAST HOUSTON STREET NEW YORK, NY 10002

Drawing Title: FIRST FLOOR ELECTRICAL NEW WORK PLAN, KEY PLAN, AND DETAIL

E201.00

05/09/2023

Sheets in Contract Set: 42 of 42

Sheets in DOB Set: — of 37

GENERAL NOTES:

- 1. REMOVAL OF THE ASBESTOS CONTAINING MATERIALS FROM THIS BUILDING WILL BE CONDUCTED IN ACCORDANCE WITH ALL APPLICABLE NYCSCA, NYC, STATE, FEDERAL, EPA, OSHA REGULATIONS- THE STRICTER REQUIREMENT APPLIES. IN ADDITION, THE CONTRACTOR SHALL ENSURE THAT ALL REMOVAL AND ENCAPSULATION IS IN ACCORDANCE WITH THIS DRAWING, THE CONTRACT SPECIFICATIONS, AND ALL APPLICABLE NYCSCA, NYC, STATE, FEDERAL, EPA, OSHA REGULATIONS.
- 2. THE DRAWING DOES NOT SHOW ALL EQUIPMENT AND MOVABLE OBJECTS WITHIN THE WORK ZONES. THE CONTRACTOR ALONE IS RESPONSIBLE FOR DETERMINING THE ACTUAL ABATEMENT QUANTITIES AND COORDINATING THE RELOCATION OF ANY ITEMS WITH THE OWNER AND ENGINEER.
- 3. FREE STANDING DECONTAMINATION UNIT PARTITIONS SHALL BE CONSTRUCTED WITH 2 X 4 STUDS, 16 INCH ON CENTER AND $\frac{1}{2}$ INCH CDX PLYWOOD, THEN COVERED WITH TWO LAYERS OF 6- MIL. PLASTIC SHEETING.
- 4. THE CONTRACTOR IS RESPONSIBLE FOR USING "STANDARD OF CARE" WHEN APPLYING OR REMOVING TAPE, SPRAY ADHESIVE OR ANY OTHER TYPE OF BONDING MATERIAL FROM THE WALLS, FLOORS OR CEILING. IF DAMAGE IS SUSTAINED TO AN AREA DURING THE WORK PROCEDURE, THAT CONTRACTOR IS RESPONSIBLE FOR RETURNING THE AREA BACK TO ITS ORIGINAL CONDITION UNLESS OTHERWISE NOTED.

LOCK	ROOM	AIR	WASTE WASH ROOM	AIR	HOLDING
AIR LC	EQUIPMER	AIR	SHOWER	AIR	CLEAN

TYPICAL DECONTAMINATION UNIT

ASBESTOS CONTAINING MATERIAL LEGEND- ALL ASSUMED ASBESTOS CONTAINING MATERIAL MUST EITHER BE TESTED DURING CONSTRUCTION OR REMOVED AS ASBESTOS WASTE- FOLLOW SPECIFICATIONS:



- CONFIRMED ACM PIPE/PIPE JOINT INSULATION.

SPECIFICATION NOTES:

Note 1: The contractor shall assume that ACM debris exists within the ceiling plenum and it is damaged. Thus, any materials associated with this debris shall be disposed of as ACM-contaminated waste at no additional cost to the Authority.

Note 2: All selective demolition into inaccessible spaces (including but not limited to pipe chases, ceiling plenums, soffits, etc.) must be conducted exclusively by the Abatement Contractor in modified tents or in full containments under controlled conditions in the presence of the Authority's environmental consultant.

Note 3: Any scaffolding erected shall be the responsibility of the General Contractor, will be constructed, maintained, and operated in accordance with the applicable federal, state, city & NYC/SCA rules, regulations and procedures and signed off by a licensed PE and approved by the SCA Safety Unit. The General contractor shall solely be responsible for any delays resulting from the rejection of his/her design by the Safety Unit.

Note 4: Any materials not listed or addressed in part 4 of spec 02081 must be assumed to be Asbestos-Containing Materials. The Contractor shall notify the Project Officer immediately if any materials that are not listed are encountered, who will then notify the Authority's Industrial Hygienist for directive.

Note 5: The General Contractor shall be responsible for providing the Authority's Environmental Consultant with access to all assumed ACM in order to facilitate sampling/ inspection of these materials at no additional cost to the Authority. The turn-around-time for bulk sampling and analysis shall not be deemed as a basis for a delay claim against the Authority.

Note 6: The contractor may opt to remove all fiberglass insulated pipes as asbestos contaminated material in order to expedite his/her schedule; however, the additional cost of re-insulation shall be borne solely by the General Contractor.

Note 7: The general contractor must provide all material, manpower and equipment to access all assumed ACM materials for sampling by the Authority, at no extra cost to the Authority.

Note 8: Unless otherwise noted, all caulks/sealants (including concealed/inaccessible) are presumed to be ACM and PCB-containing. The Contractor shall refer to SCA specification section 1.01 in section 501900 for additional handling and disposal requirements.

Note 9: The Asbestos Contractor shall be responsible for protecting all areas (floors and fixed items) underneath the elevated containment. At a minimum, a layer of 6-mil poly shall be draped over all immovable objects underneath the elevated containment.

Note 10: Asbestos Contractor shall be responsible for all repairs to finish surfaces which are damaged during the course of the abatement work which are not included in the proposed scope of work.

Note 11: All connections/ disconnections to existing electrical panels, fixtures, pull boxes, etc. shall be conducted by a licensed electrician with an asbestos handler license.

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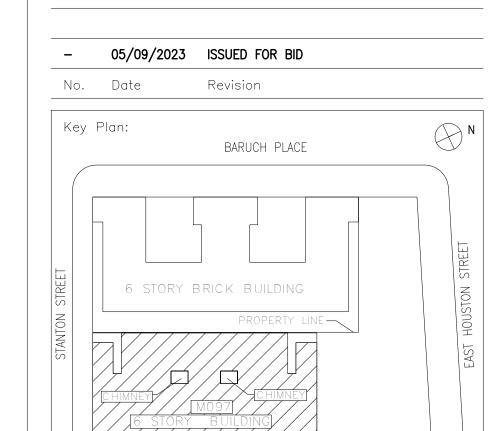
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420 COLUMBUS AVENUE, VALHALLA, NY 10595



Block # 325

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NASER HAMOUDEH, P.E.

Project Architect/Engineer:

JEFFREY RABINER, P.E.

Discipline Lead:

DAVE CHARBONNEAU

Designer:

Dave CHARBONNEAU

Drawn by:

LUIS LOAYZA

FABIO PEDONE AH- 93-16035

MANGIN STREET

Design No or LLW No.: Building ID: Date: 05/09/2023

BARD COLLEGE HS, MANHATTAN

Address:
525 EAST HOUSTON STREET

WASTE SYSTEM

NEW YORK, NY 10002

Drawing Title:


ASBESTOS NOTES

AND LEGEND

Drawing No.: **H101.00**

Sheets in Contract Set: 5 of 41

Sheets in DOB Set: - of 36

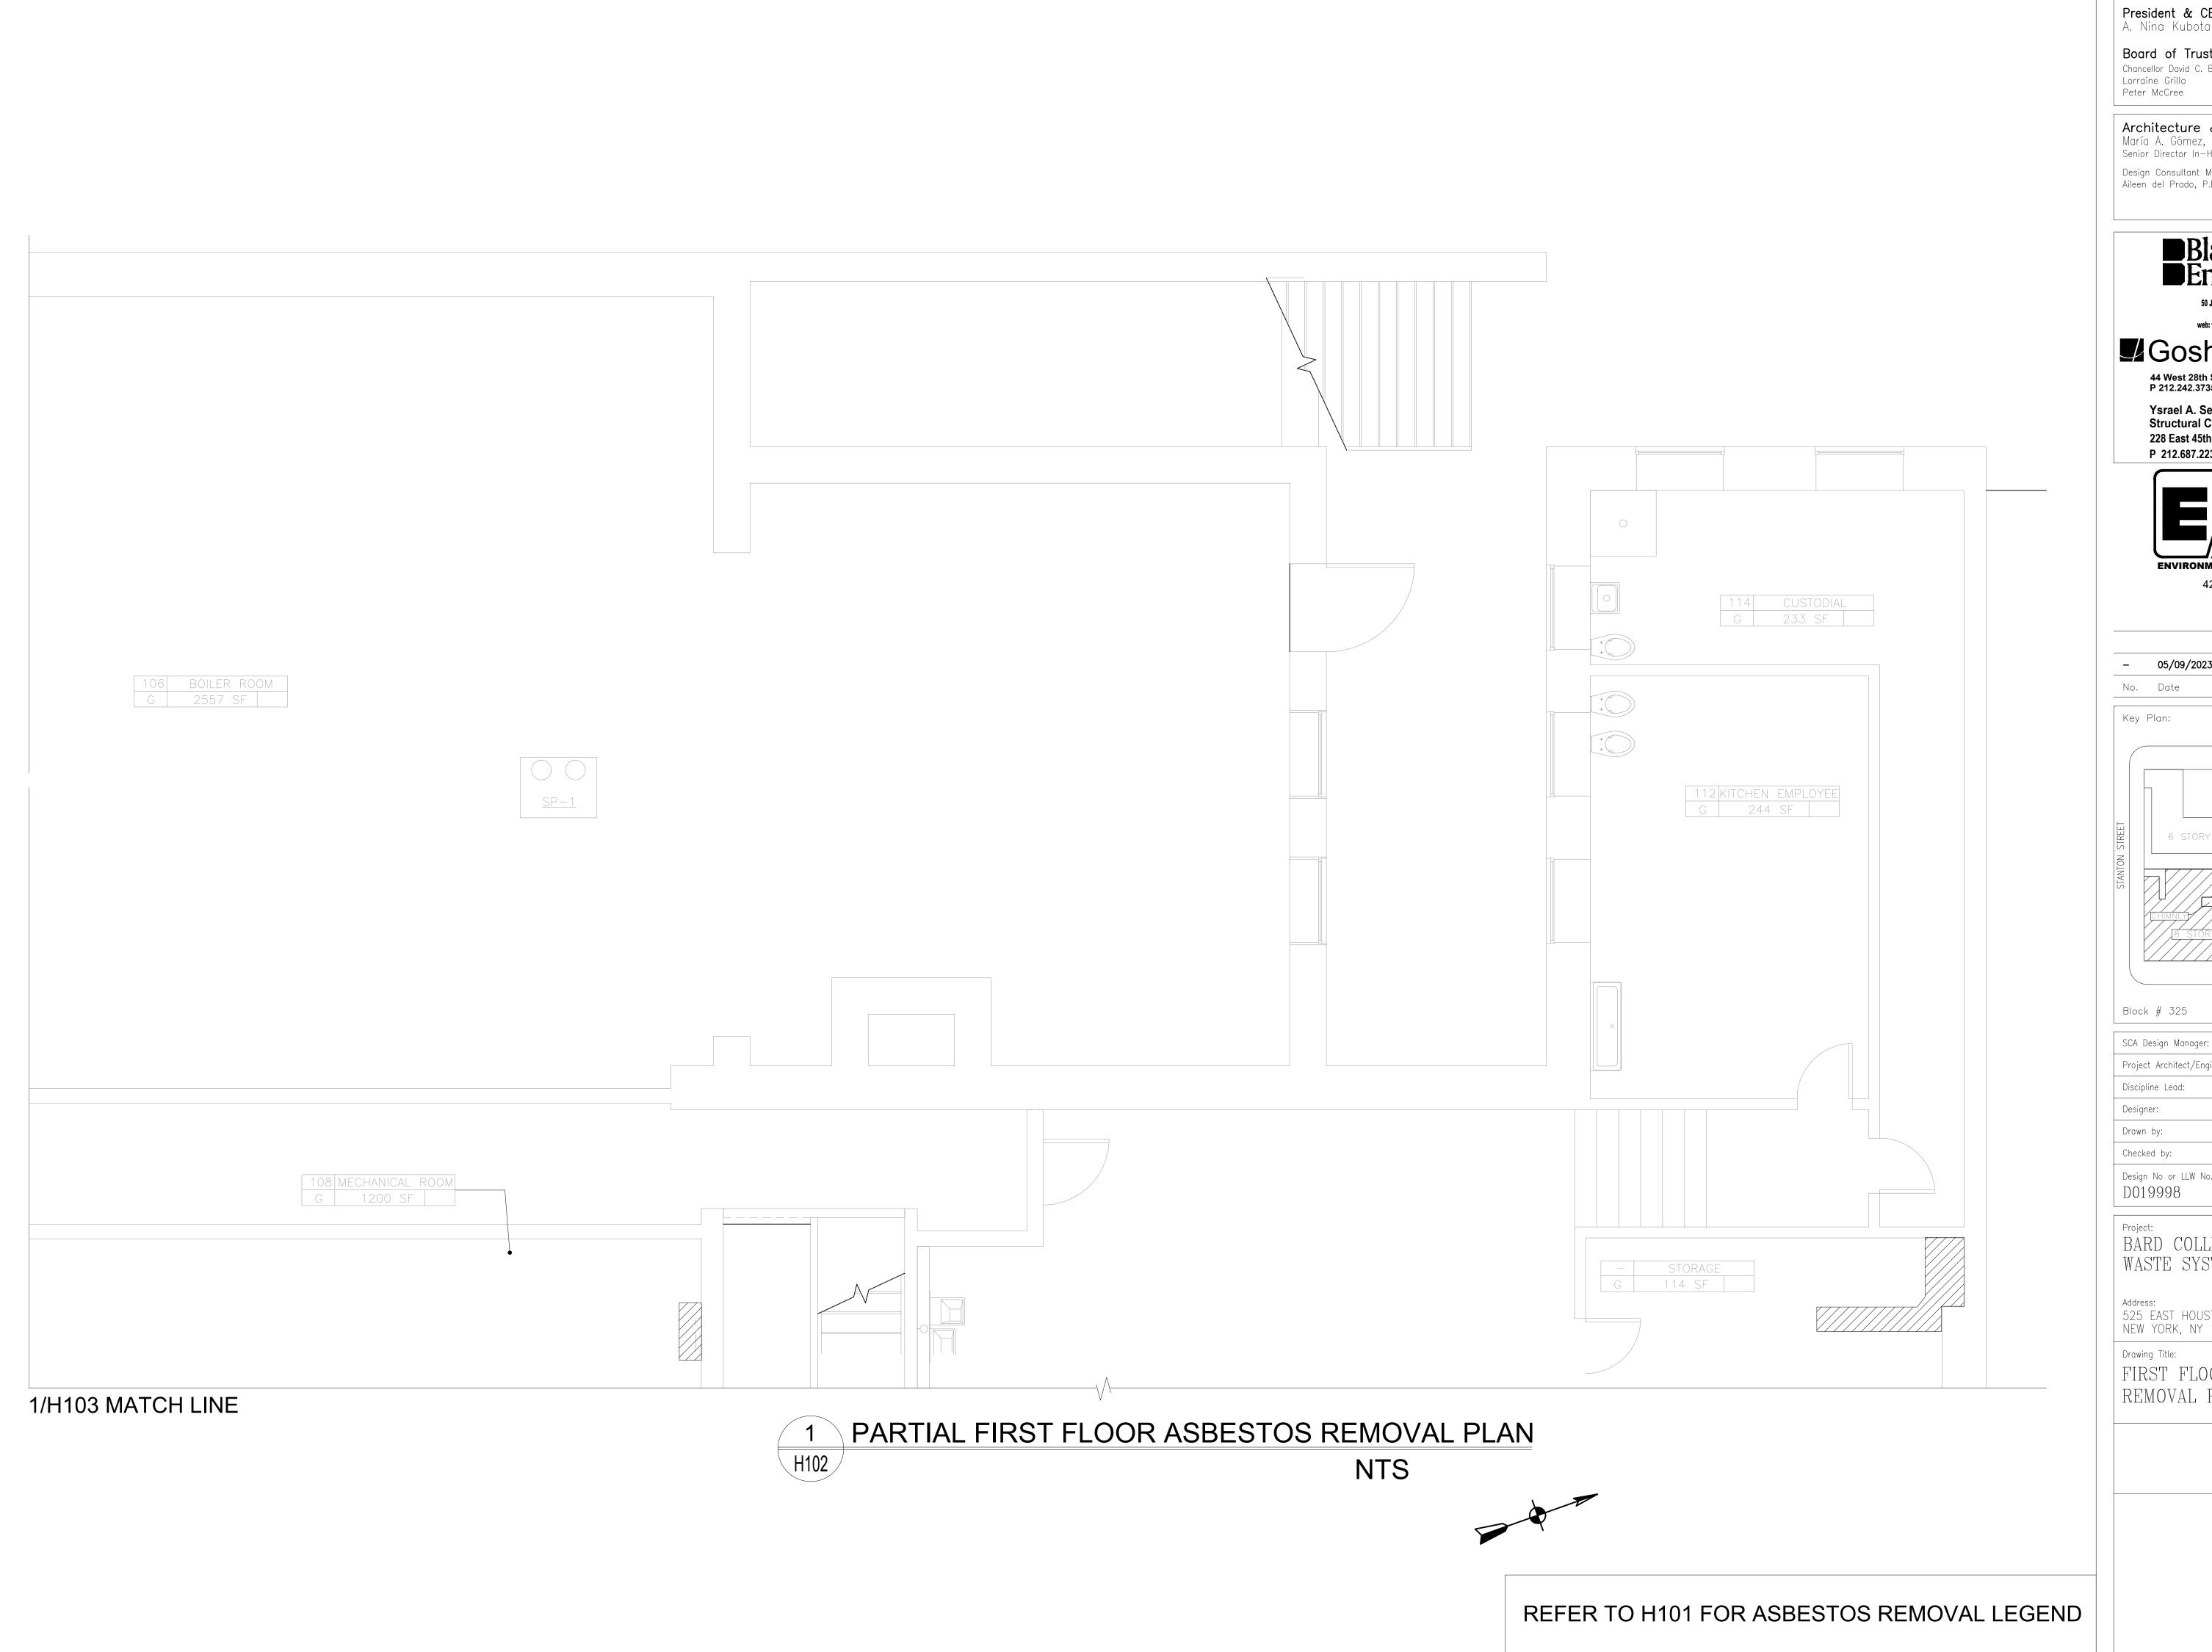

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420 COLUMBUS AVENUE, VALHALLA, NY 10595

- 05/09/2023 ISSUED FOR BID

Revision Key Plan: BARUCH PLACE 6 STORY BRICK BUILDING MANGIN STREET

Block # 325 NASER HAMOUDEH, P.E.

JEFFREY RABINER, P.E. Project Architect/Engineer: DAVE CHARBONNEAU DAVE CHARBONNEAU

LUIS LOAYZA FABIO PEDONE AH- 93-16035 Design No or LLW No.: Building ID:

BARD COLLEGE HS, MANHATTAN WASTE SYSTEM

Address:
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NEW YORK, NY 10002

Drawing Title:


FIRST FLOOR ASBESTOS REMOVAL PLAN

Lot # 25

05/09/2023

Sheets in Contract Set: 6 of 41

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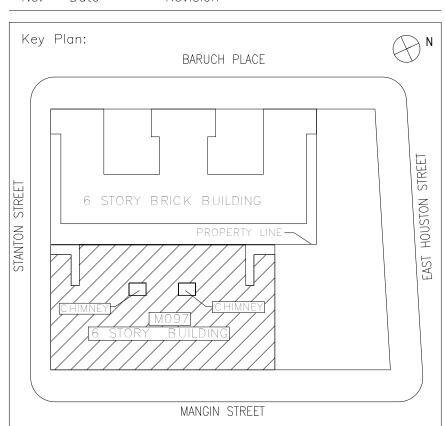
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420 COLUMBUS AVENUE, VALHALLA, NY 10595

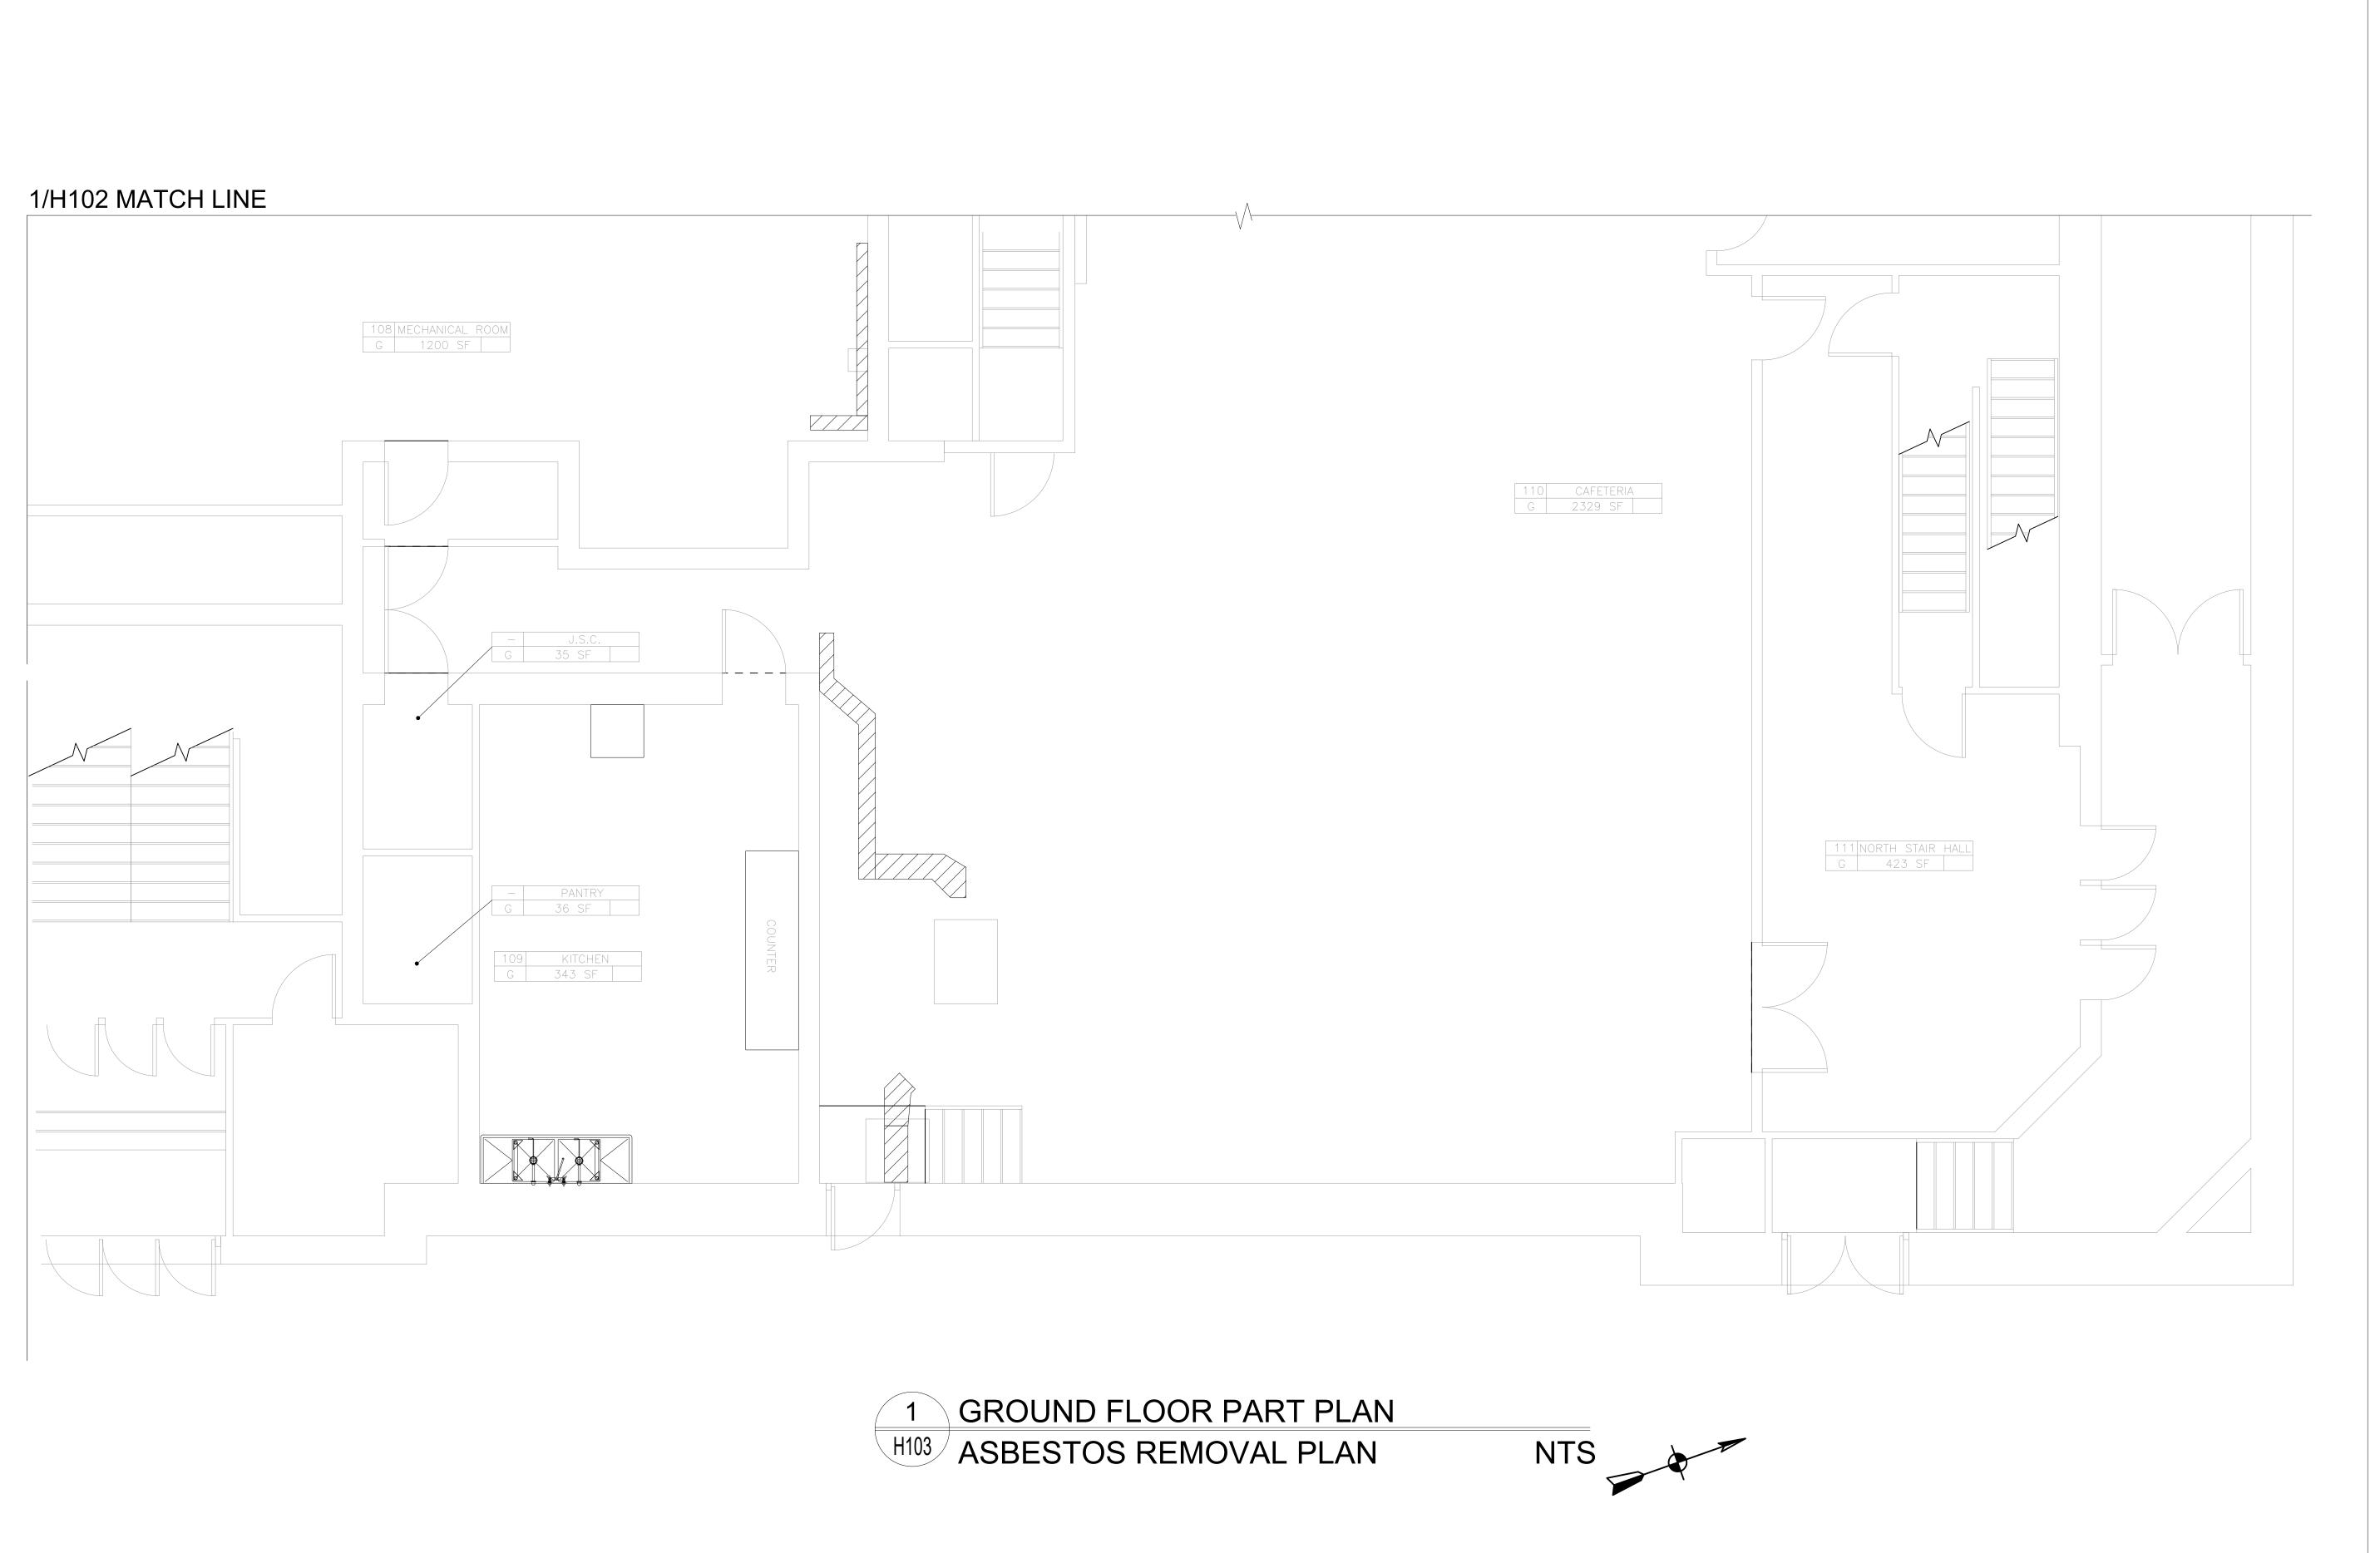05/09/2023 ISSUED FOR BID No. Date Revision



Block # 325 Lot # 25

SCA Design Manager: NASER HAMOUDEH, P.E. JEFFREY RABINER, P.E. Project Architect/Engineer: DAVE CHARBONNEAU DAVE CHARBONNEAU LUIS LOAYZA

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BARD COLLEGE HS, MANHATTAN

WASTE SYSTEM

Address: 525 EAST HOUSTON STREET NEW YORK, NY 10002

GROUND FLOOR PART PLAN ASBESTOS REMOVAL PLAN

H103.00

Sheets in Contract Set: 7 of 41

05/09/2023

Sheets in DOB Set: - of 36

REFER TO H101 FOR ASBESTOS REMOVAL LEGEND

KEY OF SYMBOLS

PIPE DOWN

BACKWATER VALVE

PIPE UP

PIPE CAP

CLEAN OUT

<i>'}}</i>	INDICATES ITEMS TO BE REMOVED
,	UNDERGROUND EXISTING WORK TO BE ABANDONED
<u></u>	EXISTING UNDERGROUND WORK TO REMAIN
ş	EXISTING WORK TO REMAIN
,	NEW WORK
SD	STORM PIPING
SAN	SANITARY PIPING
	VENT PIPING
	SANITARY/WASTE PIPING UNDERGROUND
$oldsymbol{\Theta}$	NEW CONNECTION POINT
	DISCONNECTION POINT

ABBREVIATIONS

SEP-1	SEWAGE EJECTOR PUMP
S	SANITARY
V	VENT
W	WASTE
SD	STORM
PD	PUMP DISCHARGE
DN	DOWN
U.O.N.	UNLESS OTHERWISE NOTED
TYP.	TYPICAL

SPECIAL INSPECTIONS:

1. SPECIAL INSPECTIONS REQUIRED IN ACCORDANCE WITH CHAPTER 17 AND THE APPLICABLE SECTIONS OF THE NYC CONSTRUCTION CODE ARE LISTED BELOW:

FIRE-RESISTANT PENETRATIONS AND JOINTS (BC 1704.27)

GENERAL NOTES:

1. ALL WORK SHALL BE PERFORMED IN ACCORDANCE WITH ALL APPLICABLE CODES AND STANDARDS.

CLEAN OUT DECK PLATE OR GRADE PLATE

- 2. CONTRACTOR SHALL OBTAIN AND PAY FOR ALL REQUIRED PERMITS AND APPROVALS ASSOCIATED WITH HIS WORK.
- 3. SHOP DRAWINGS FOR ALL EQUIPMENT AND SYSTEMS SHALL BE SUBMITTED FOR REVIEW PRIOR TO INSTALLATION.
- 4. PATCH AND PAINT CEILINGS AND WALLS THAT ARE DAMAGED DUE TO PLUMBING PIPING INSTALLATION. COLOR TO BE AS SELECTED BY ARCHITECT.
- 5. PAINT ALL EXPOSED PIPING TO MATCH SURROUNDING CONDITIONS. COLOR TO BE AS SELECTED BY THE ARCHITECT.
- 6. CONTRACTOR SHALL PROTECT ALL EXISTING AREAS, EQUIPMENT, AND MATERIALS WITHIN PROJECT AREA DURING CONSTRUCTION. ALL DAMAGED AREAS, EQUIPMENT AND MATERIALS SHALL BE REPAIRED AT NO COST TO THE OWNER BY THE CONTRACTOR.
- 7. ALL NEW AND EXISTING HORIZONTAL STORM PIPING SHALL BE PROVIDED WITH 1 INCH OF INSULATING MATERIAL HAVING A CONDUCTIVITY NOT EXCEEDING 0.23 BTU PER INCH/H X FT^2 X °F. REFER TO SPECIFICATIONS FOR ADDITIONAL INFORMATION.
- 8. ALL WATER SYSTEMS THAT HAVE BEEN AFFECTED BY THIS PROJECT SHALL BE DISINFECTED AS PER NYC PLUMBING CODE
- 9. ALL PLUMBING VENTS SHALL TERMINATE ABOVE THE DFE.
- 10. ALL EXISTING SANITARY, VENT, COLD WATER AND HOT WATER PIPING SYSTEMS HAVE ADEQUATE CAPACITY AND PRESSURE FOR FIXTURES TO FUNCTION AND WILL NOT RESULT IN THE EXISTING INSTALLATION TO BECOME OVERLOADED.

2014 NYC BUILDING DEPARTMENT **PLUMBING NOTES:**

- 1. ALL PLUMBING WORK SHALL MEET THE REQUIREMENTS OF THE 2014 NEW YORK CITY PLUMBING CODE.
- 2. PROTECTION OF PIPING AS DIRECTED IN SECTION PC 305 SHALL BE PROVIDED AS REQUIRED.
- 3. ALL PIPING AND MATERIALS SHALL BE AS DIRECTED IN SECTIONS PC 303 & PC 702.
- 4. PIPING JOINTS AND CONNECTIONS SHALL BE AS DIRECTED IN SECTIONS PC 605 & PC 702.
- 5. CONSTRUCTION, QUANTITIES, DEVICES, FIXTURES, FAUCETS, VALVES, AND FACILITIES FOR THE DISABLED SHALL BE AS DIRECTED IN CHAPTER 4.
- 6. TRAPS SHALL BE AS PER SECTION PC 1002.
- 7. CONSTRUCTION AND SPACING OF HANGERS AND SUPPORTS SHALL BE AS DIRECTED IN SECTION PC 308.
- 8. WATER SUPPLY SYSTEM, VALVES, AND TESTS SHALL BE AS DIRECTED IN CHAPTER 6. VALVES SHALL BE PROVIDED AT RISERS AND ELSEWHERE AS PER SECTION PC 606.
- 9. SANITARY DRAINAGE PIPING, SIZING, GRADING AND OFFSETS SHALL BE AS DIRECTED IN CHAPTER 7.
- 10. VENT SIZING, GRADING, CONNECTIONS, LOCATIONS AND OFFSETS SHALL BE AS DIRECTED IN CHAPTER 9.
- 11. CLEAN OUT FOR SANITARY AND WASTE SHALL BE AS DIRECTED PER SECTION PC 708.
- 12. ALL PLUMBING WORK SHALL BE DONE BY OR UNDER THE DIRECT SUPERVISION OF A LICENSED MASTER PLUMBER AS PER SECTION 28-408 OF THE 2014 NYC GENERAL ADMINISTRATIVE PROVISIONS CODE.
- 13. ALL NEW OR ALTERED WATER SYSTEMS SHALL BE DISINFECTED IN ACCORDANCE WITH PC 610.1

SCOPE OF WORK

THE FOLLOWING IS A SCOPE OF WORK SUMMARY FOR THIS PROJECT. IT DESCRIBES ALL OF THE PLUMBING COMPONENTS OF WORK WHICH ARE INCLUDED IN THIS PROJECT:

- CUT AND PATCH EXISTING CAFETERIA FLOOR TO ACCESS EXISTING SANITARY AND STORM PIPING CONNECTED TO THE EXISTING OUTFALL. DISCONNECT THE EXISTING 6" BACK PITCHED PIPING FROM THE EXISTING COMBINED SANITARY/STORM OUTFALL AND ABANDON. DISCONNECT ALL STORM PIPING FROM THE COMBINED SANITARY/STORM OUTFALL AND ROUTE PIPING TO NEW STORM TRAP.
- PROVIDE NEW 6" STORM TRAP WITHIN 4'X3' CONCRETE PIT WITH ACCESS HATCH LOCATED IN THE KITCHEN. REMOVE, STORE AND RECONNECT EXISTING EQUIPMENT AS REQUIRED TO INSTALL THE PIT AND ASSOCIATED PIPING.
- 3. PROVIDE NEW 6" BACKWATER VALVE WITHIN THE CONCRETE PIT.
- DISCONNECT, STORE AND RECONNECT EXISTING 8" BACKWATER VALVE AS REQUIRED TO MODIFY OUTFALL TO CONNECT NEW STORM PIPING.
- DISCONNECT EXISTING STORM PIPING WITHIN THE CEILING OF THE CAFETERIA, MECHANICAL ROOM AND ASSOCIATED SPACES, AND REMOVE. CONNECT NEW STORM PIPING TO EXISTING PIPING WITHIN CEILING AND ROUTE TO THE NEW STORM TRAP. INSULATE ALL EXISTING AND NEW HORIZONTAL STORM PIPING.
- PROVIDE NEW DUPLEX SEWAGE EJECTOR PUMP WITHIN THE MECHANICAL ROOM TO SERVE THE EXISTING PLUMBING FIXTURES UPSTREAM OF THE BACK PITCHED PIPING WITHIN THE FIRST

	DRAWING INDEX
DWG #	DRAWING TITLE
P001.00	KEY OF SYMBOLS, ABBREVIATIONS AND GENERAL NOTES
P002.00	PLUMBING SCHEDULES
P061.00	FIRST FLOOR PLUMBING REMOVALS PLAN WEST
P062.00	FIRST FLOOR PLUMBING REMOVALS PLAN EAST AND SECTIONS
P201.00	FIRST FLOOR PLUMBING NEW WORK PLAN WEST, PART PLAN AND SECTION
P202.00	FIRST FLOOR PLUMBING NEW WORK PLAN EAST AND SECTIONS
P301.00	SANITARY AND STORM DRAINAGE RISER DIAGRAMS
P401.00	PLUMBING DETAILS

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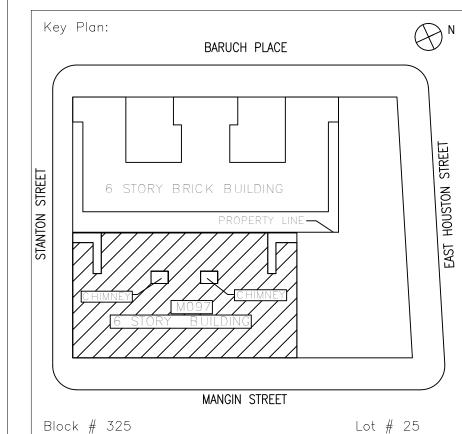
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Designer:		DANIEL GIANN	IOTTA
Drawn by:		DANIEL GIANN	IOTTA
Checked by:		JOHN HIGGINS	S, P.E.
Design No or LLW No.:	Building	ID:	Date:

BARD COLLEGE HS, MANHATTAN WASTE SYSTEM

525 EAST HOUSTON STREET NEW YORK, NY 10002

Drawing Title:

KEY OF SYMBOLS, ABBREVIATIONS AND GENERAL NOTES


DOB NOW JOB #M00660122-I1



33 of 42

Sheets in DOB Set: 30 of 37

05/09/2023

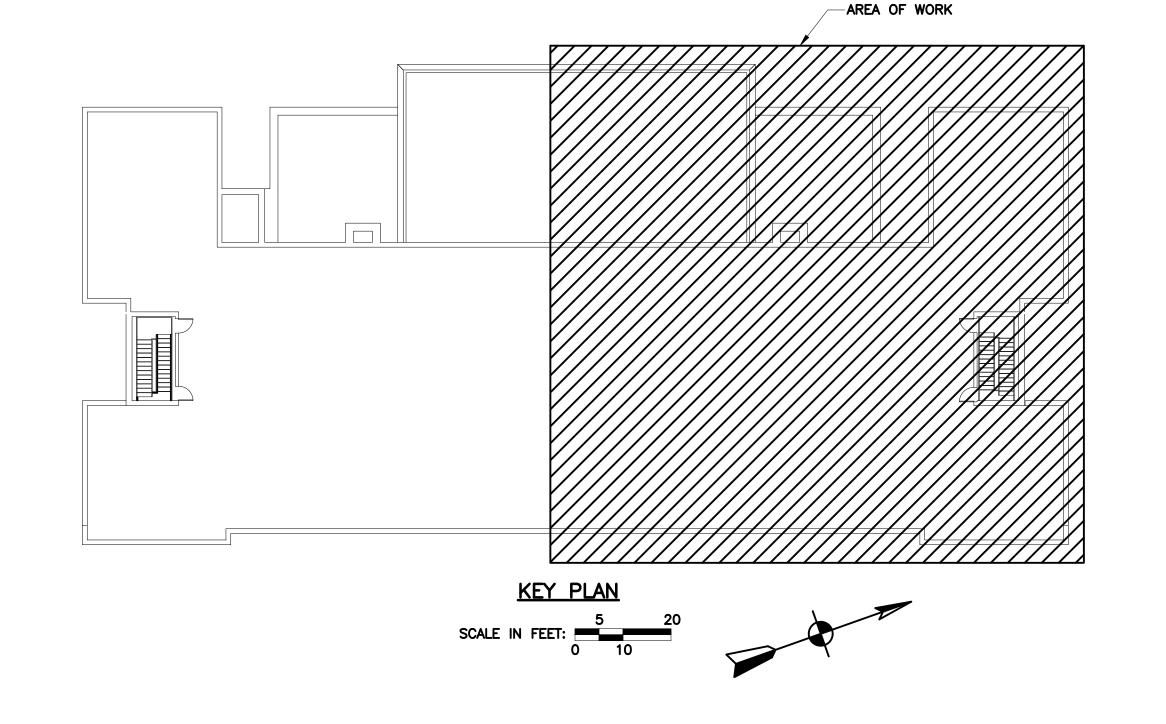

	PLUMBING MATERIALS				
PIPING SYSTEM	REQUIREMENT				
	INTERIOR (ABOVE GROUND)	SERVICE WEIGHT CAST IRON (SVCI) NO-HUB WITH MECHANICAL STAINLESS STEEL COUPLINGS. GALVANIZED STEEL PIPE SCHEDULE 40, WITH THREADED DRAINAGE FITTINGS ALLOWED FOR 3" DIA. AND SMALLER.			
STORM PIPING	INTERIOR (UNDER GROUND)	SERVICE WEIGHT CAST IRON BELL AND SPIGOT WITH LEAD AND OAKUM JOINTS.			
	INTERIOR (ABOVE GROUND AND HOUSE DRAIN LINES)	SERVICE WEIGHT CAST IRON (SVCI) NO-HUB WITH MECHANICAL STAINLESS STEEL COUPLINGS. GALVANIZED STEEL PIPE SCHEDULE 40, WITH THREADED DRAINAGE FITTINGS ALLOWED FOR 3" DIAMETER AND SMALLER.			
SANITARY PIPING (WASTE & VENT)	INTERIOR (PUMP DISCHARGE)	GALVANIZED STEEL PIPE SCHEDULE 40, WITH THREADED DRAINAGE FITTINGS, VICTAULIC FITTING IN CONJUCTION WITH GROOVE PIPE, 2" AND LARGER IS PERMITTED.			
	INTERIOR (UNDER GROUND)	SERVICE WEIGHT CAST IRON BELL AND SPIGOT WITH LEAD AND OAKUM JOINTS.			

	SEWAGE EJECTOR PUMP SCHEDULE										
				HEAD ER)	IG (*F)		ELECT	RICAL			
UNIT TAG	SERVICE	TYPE	МЧЭ	TOTAL DYNAMIC HEA (FEET OF WATER)	MAX. OPERATING TEMPERATURE (°F)	MIN. MOTOR HORSEPOWER	VOLTS	PHASE	HERTZ	BASIS OF SELECTION (MANUFACTURER AND MODEL NUMBER)	REMARKS
SEP-1	FIRST FLOOR FIXTURES	SUMP (DUPLEX)	25	25	110	1	208	3	60	WEIL 2436 SUBMERSIBLE GRINDER	SEE NOTE BELOW

^{1.} PROVIDE 42" INSIDE DIAMETER X 36" DEEP FIBERGLASS BASIN WITH ANTI-FLOATATION FLANGE. COORDINATE ALL REQUIREMENTS WITH MANUFACTURER

Lorraine Grillo Peter McCree

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Senior Director In—House Design Studio Design Consultant Management Studio Aileen del Prado, P.E. LEED AP BD+C, Senior Director

Consultants:

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GoshowArchitects

44 West 28th Street, 5 FL / New York, NY 10001 P 212.242.3735 / F 212.242.7460

Ysrael A. Seinuk Structural Consultant 228 East 45th Street / New York, NY 10017 P 212.687.2233 / F 646.487.5555

NOTE: Drawing may be printed at reduced scale

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- 05/09/2023 ISSUED FOR BID

No. Date Revision

Key Plan: BARUCH PLACE 6 STORY BRICK BUILDING MANGIN STREET

SCA Design Manager:	NASER HAMOU	IDEH, P.E.		
Project Architect/Engine	er: JEFFREY RABII	JEFFREY RABINER, P.E.		
Discipline Lead:	JOHN HIGGINS	JOHN HIGGINS, P.E.		
Designer:	DANIEL GIANNO	DANIEL GIANNOTTA		
Drawn by:	DANIEL GIANNO	DANIEL GIANNOTTA		
Checked by:	JOHN HIGGINS	, P.E.		
Design No or LLW No.:	Building ID: M097	Date: 05/09/2023		

Design No or LLW No.: | Building ID:

BARD COLLEGE HS, MANHATTAN WASTE SYSTEM

Address:
525 EAST HOUSTON STREET
NEW YORK, NY 10002

Block # 325

Drawing Title:

PLUMBING SCHEDULE

DOB NOW JOB #M00660122-I1


P002.00

Lot # 25

Sheets in Contract Set: 34 of 42

Sheets in DOB Set: 31 of 37

^{2.} PROVIDE WEIL SERIES 8230 SUBMERSIBLE LIQUID LEVEL CONTROLS WITH 4 LEVEL SENSING SWITCHES WITH 20' CORDS MOUNTED ON STAINLESS STEEL PIPE AND COVER BRACKET. SYSTEM SHALL PROVIDE ALL PUMPS OFF, LEAD PUMP OPERATION ALONG WITH ALTERNATION, TWO PUMP EMERGENCY PROTECTION AND HIGH WATER ALARM CONDITION. PROVIDE DUPLEX CONTROL PANEL FOR PUMP WEIL MODEL 8158, NEMA-1 UL LISTED IN CABINET WITH HINGED DOOR. PROVIDE ALL POWER AND CONTROL WIRING IN FULL ACCORDANCE WITH MANUFACTURER'S WRITTEN INSTALLATION INSTRUCTIONS. PUMPS SHALL BE ALTERNATING LEAD-LAG CONTROL.

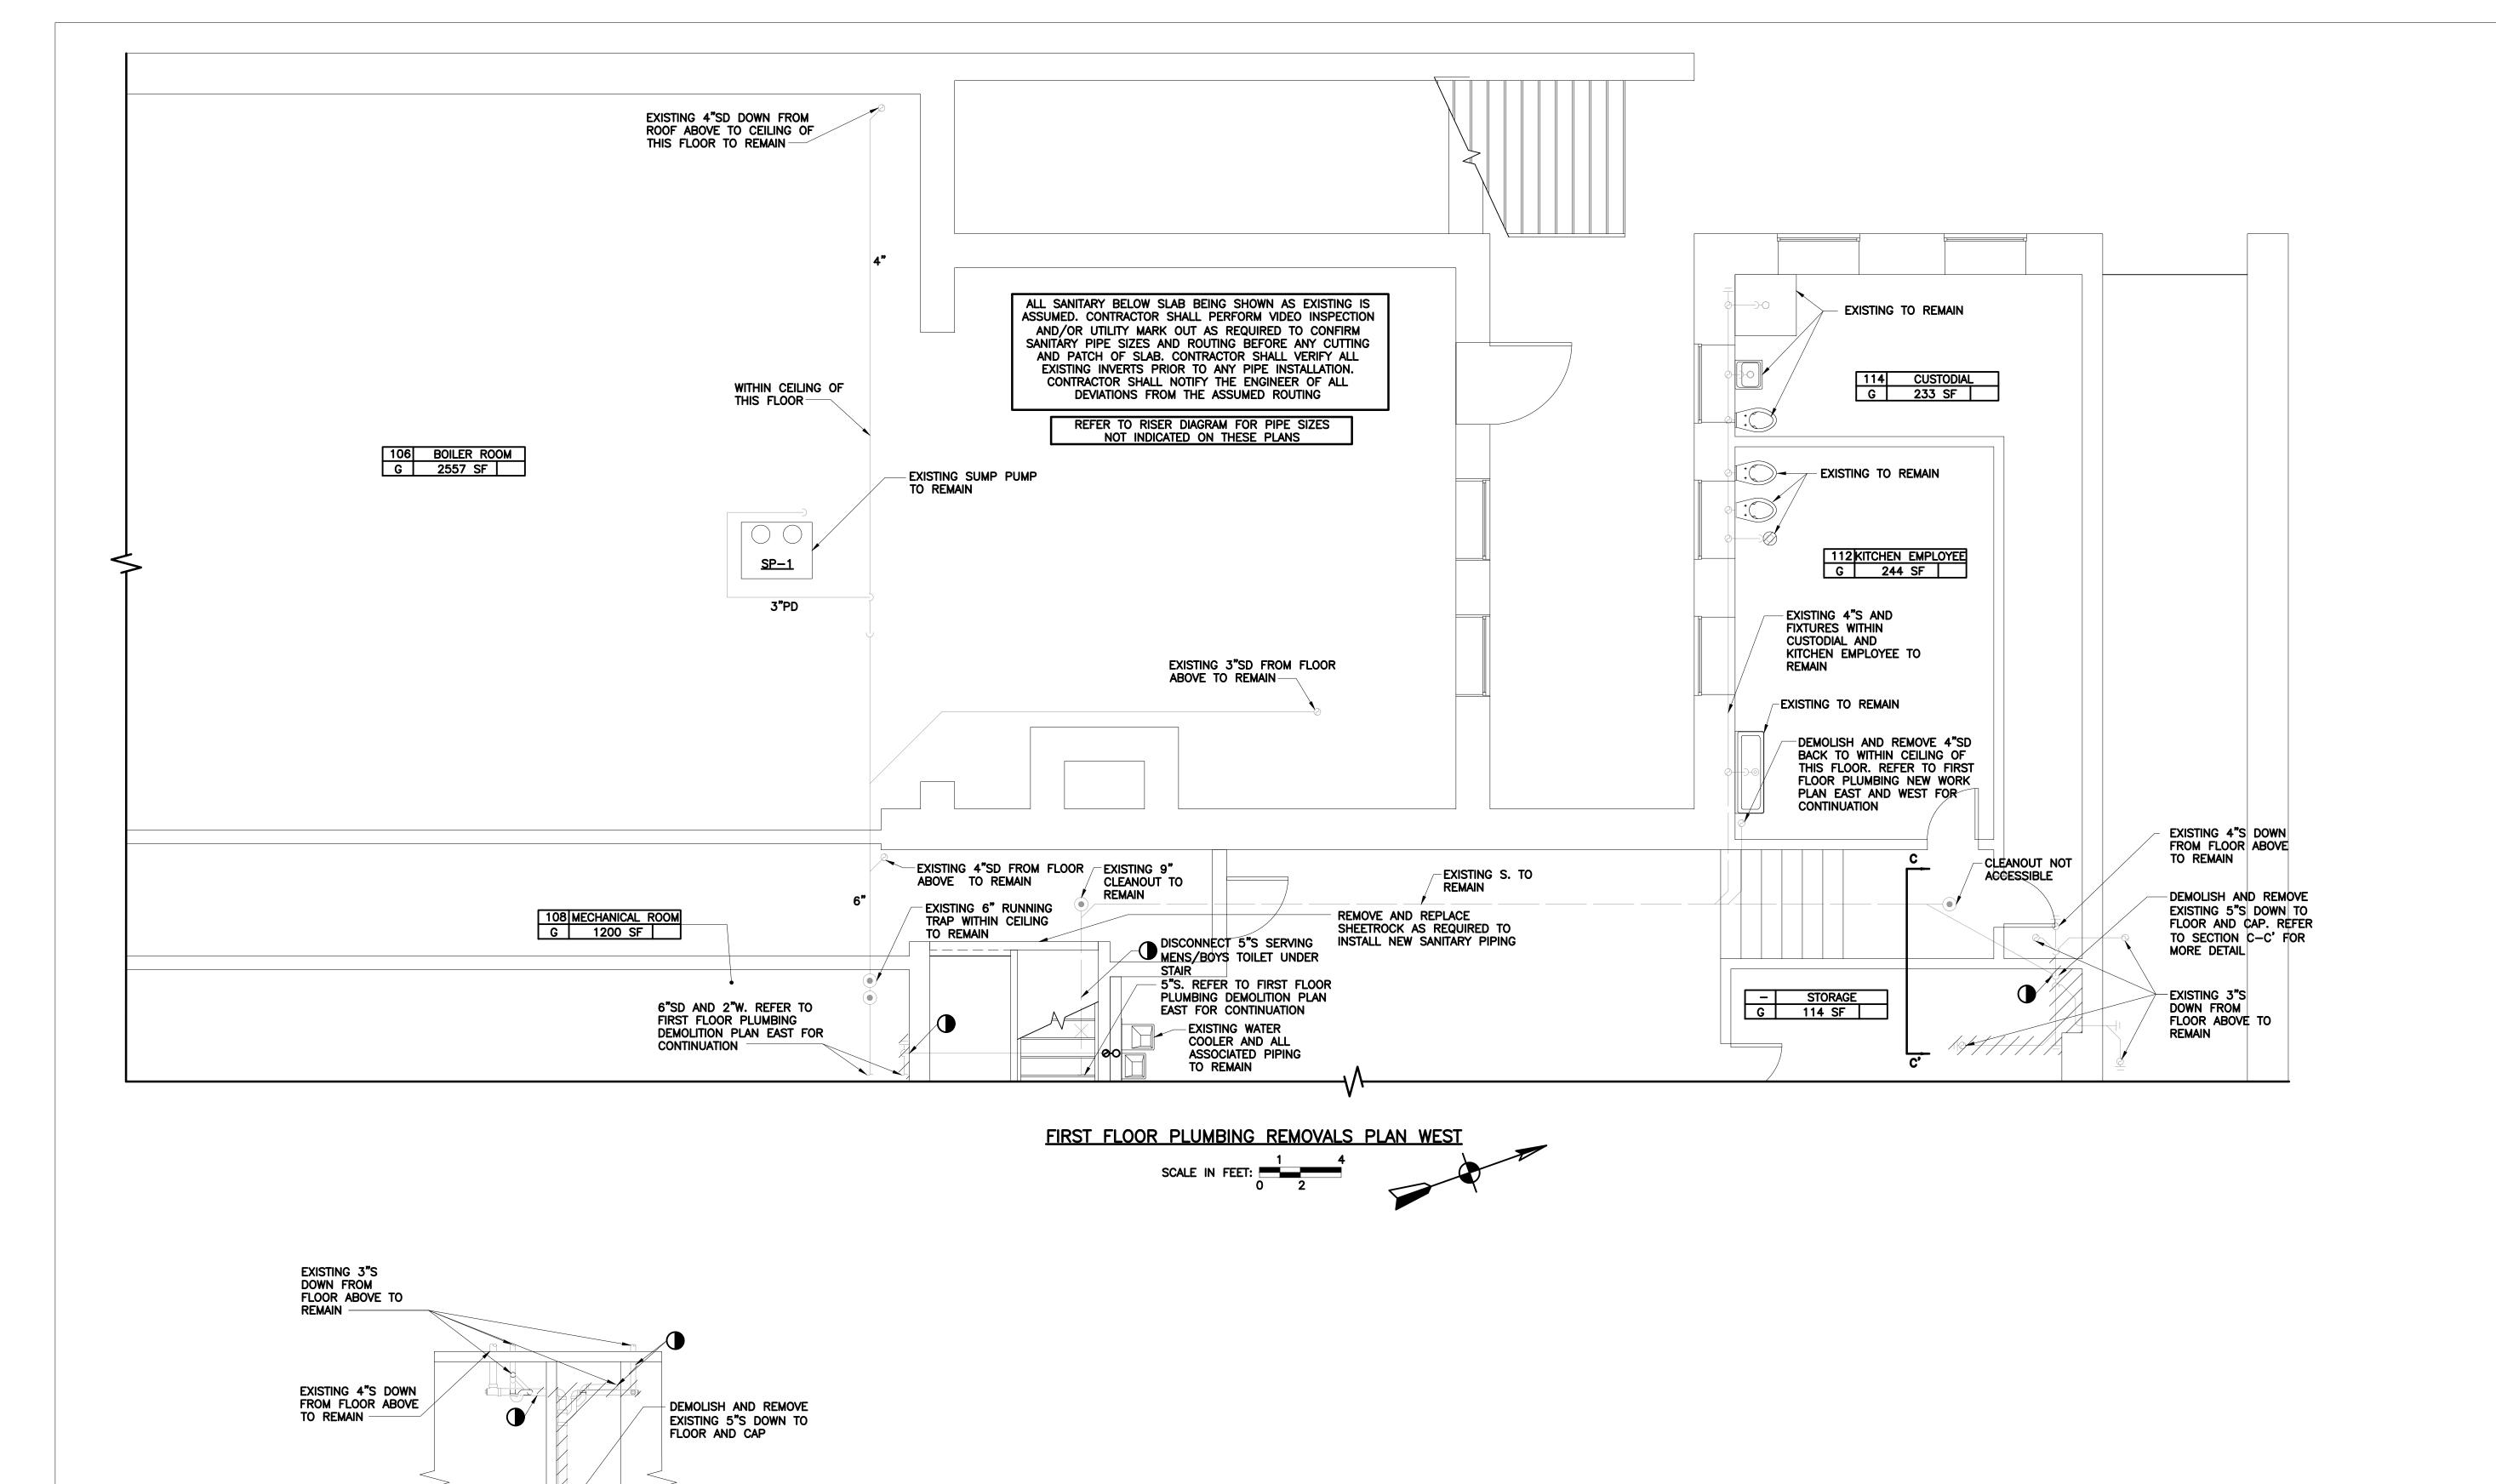

STORAGE

EXISTING 5"S TO REMAIN

SECTION C-C'

DISCONNECT EXISTING

PIPING AND PROVIDE NEW CLEANOUT CAP AT FLOOR

CUSTODIAL

President & CEO A. Nina Kubota

Peter McCree

Board of Trustees Chancellor David C. Banks, Chairman Lorraine Grillo



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Design Consultant Management Studio

Aileen del Prado, P.E. LEED AP BD+C, Senior Director

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Ysrael A. Seinuk Structural Consultant 228 East 45th Street / New York, NY 10017 P 212.687.2233 / F 646.487.5555

NOTE: Drawing may be printed at reduced scale

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- 05/09/2023 ISSUED FOR BID

No. Date Revision

STORY BRICK BUILDING

PROPERTY LINE

CHIMNEY

MO97

CHIMNEY

MO97

BARUCH PLACE

1

STORY BRICK BUILDING

CHIMNEY

MO97

MO

MANGIN STREET

Block # 325

SCA Design Manager:

NASER HAMOUDEH, P.E.

Project Architect/Engineer:

JEFFREY RABINER, P.E.

Discipline Lead:

DANIEL GIANNOTTA

Drawn by:

DANIEL GIANNOTTA

Checked by:

JOHN HIGGINS, P.E.

Checked by: JOHN HIGGINS,

Design No or LLW No.: Building ID:

M097 05/09/2023

Lot # 25

BARD COLLEGE HS, MANHATTAN WASTE SYSTEM

Address:
525 EAST HOUSTON STREET
NEW YORK, NY 10002

Drawing Title:


FIRST FLOOR PLUMBING REMOVALS PLAN WEST


DOB NOW JOB #M00660122-I1




Sheets in Contract Set: 35 of 42

Sheets in DOB Set: 32 of 37

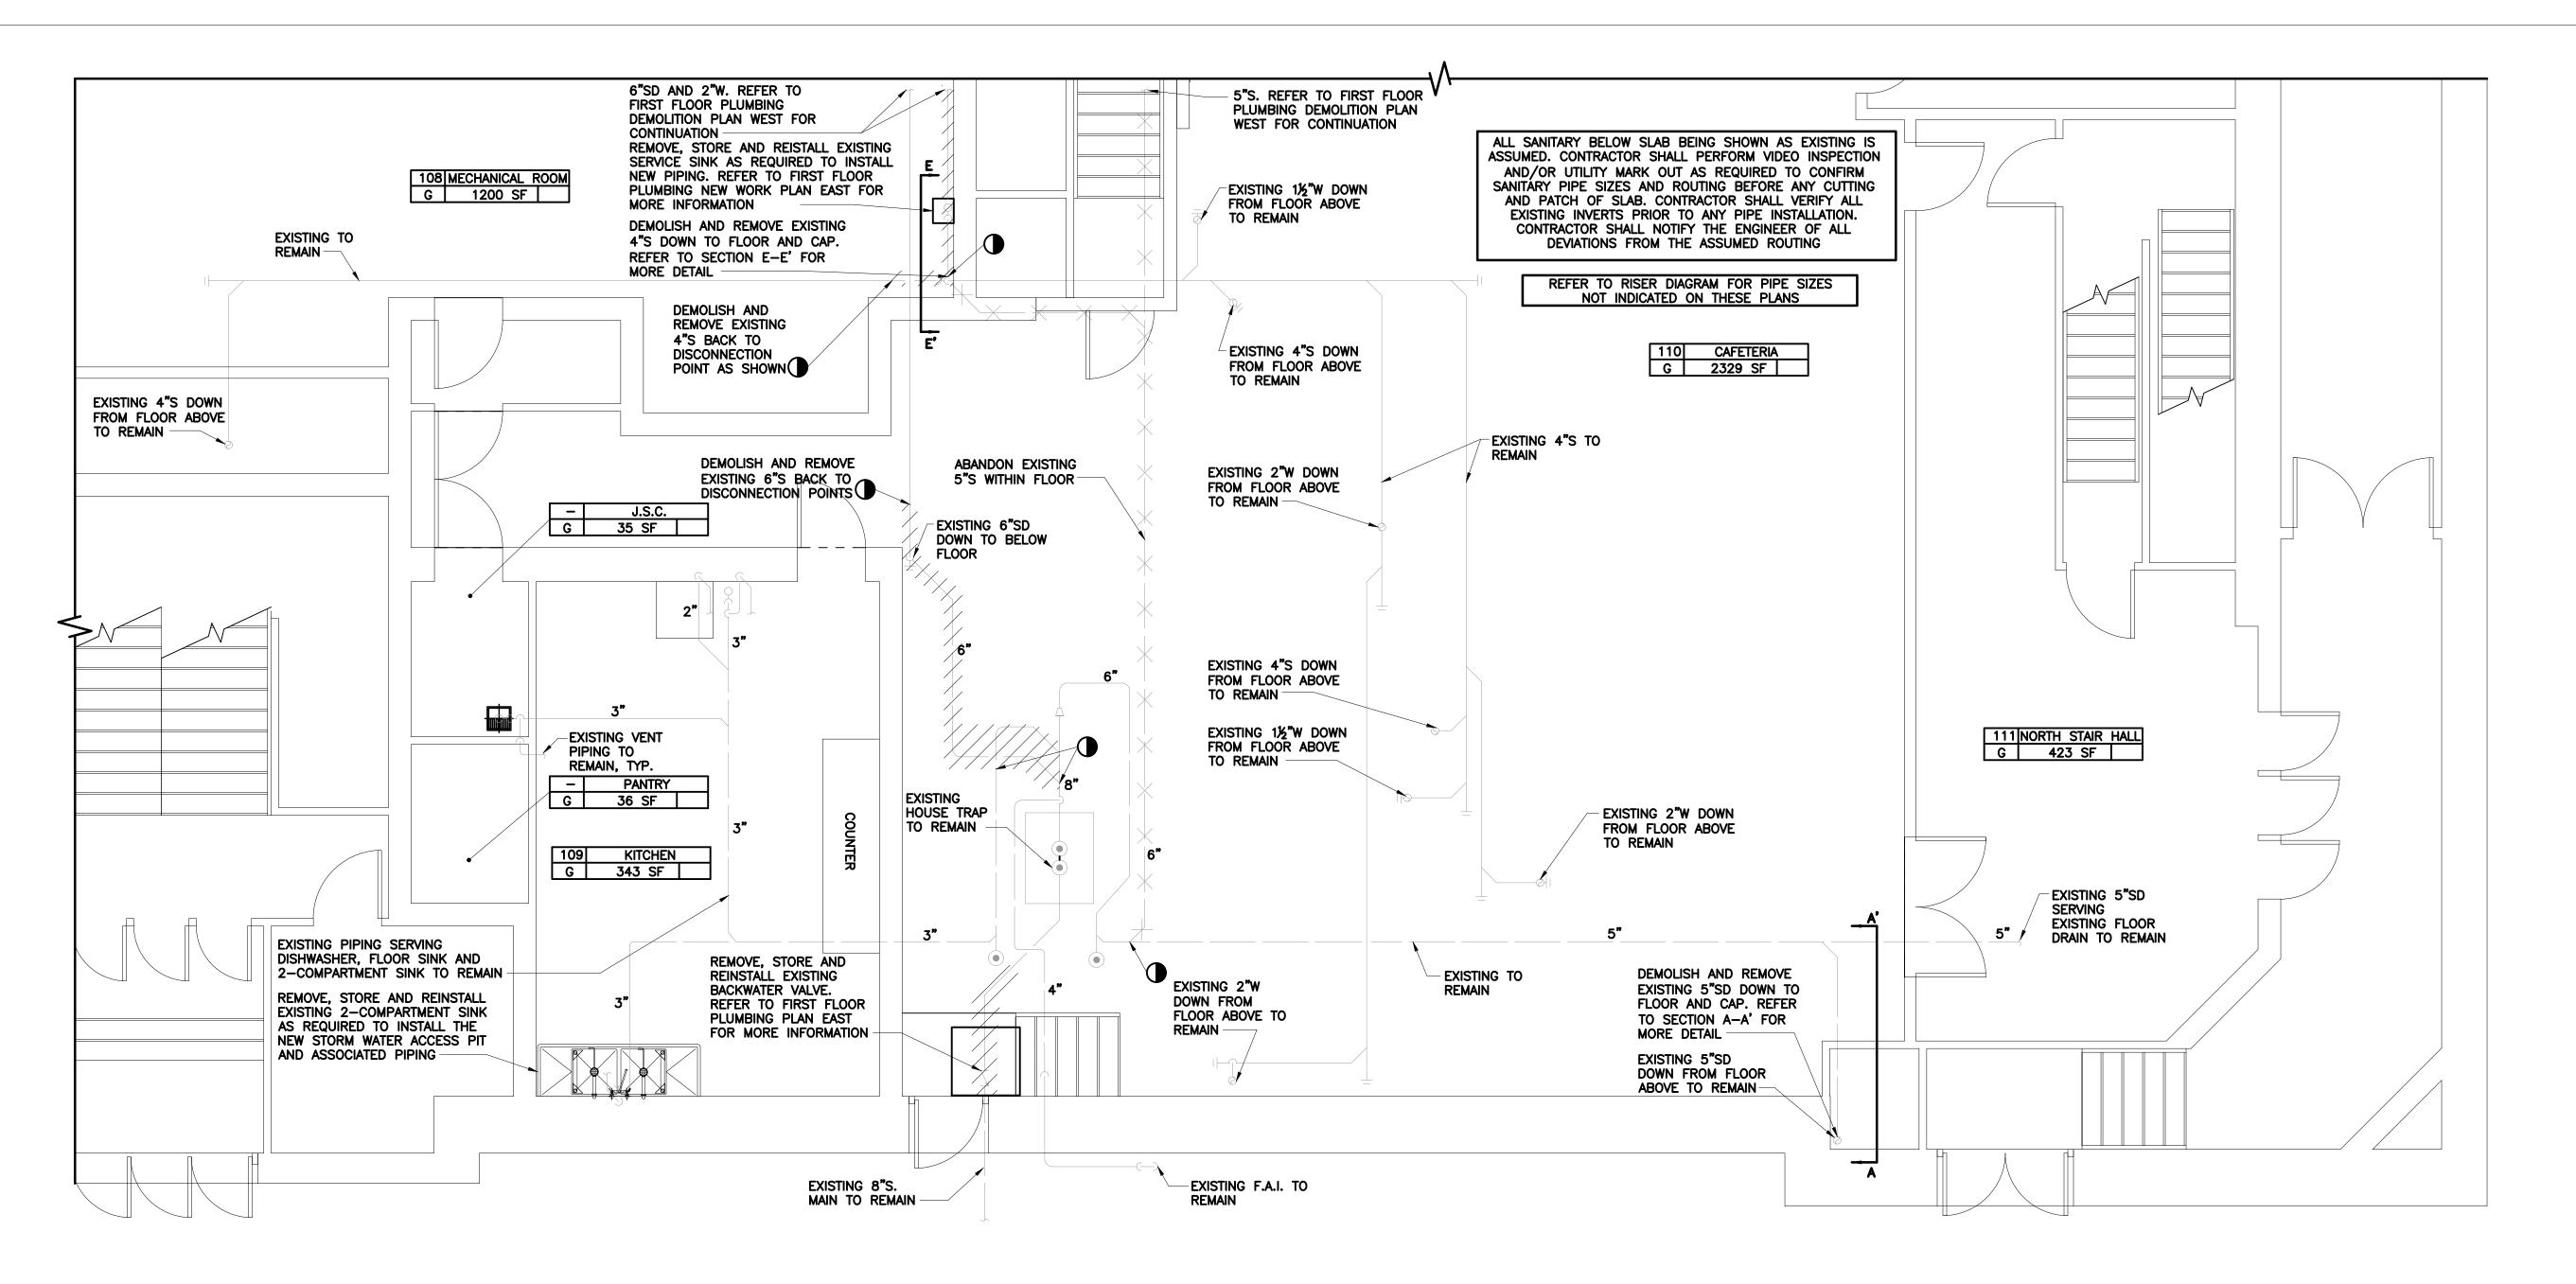

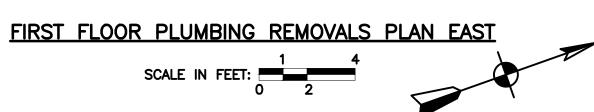

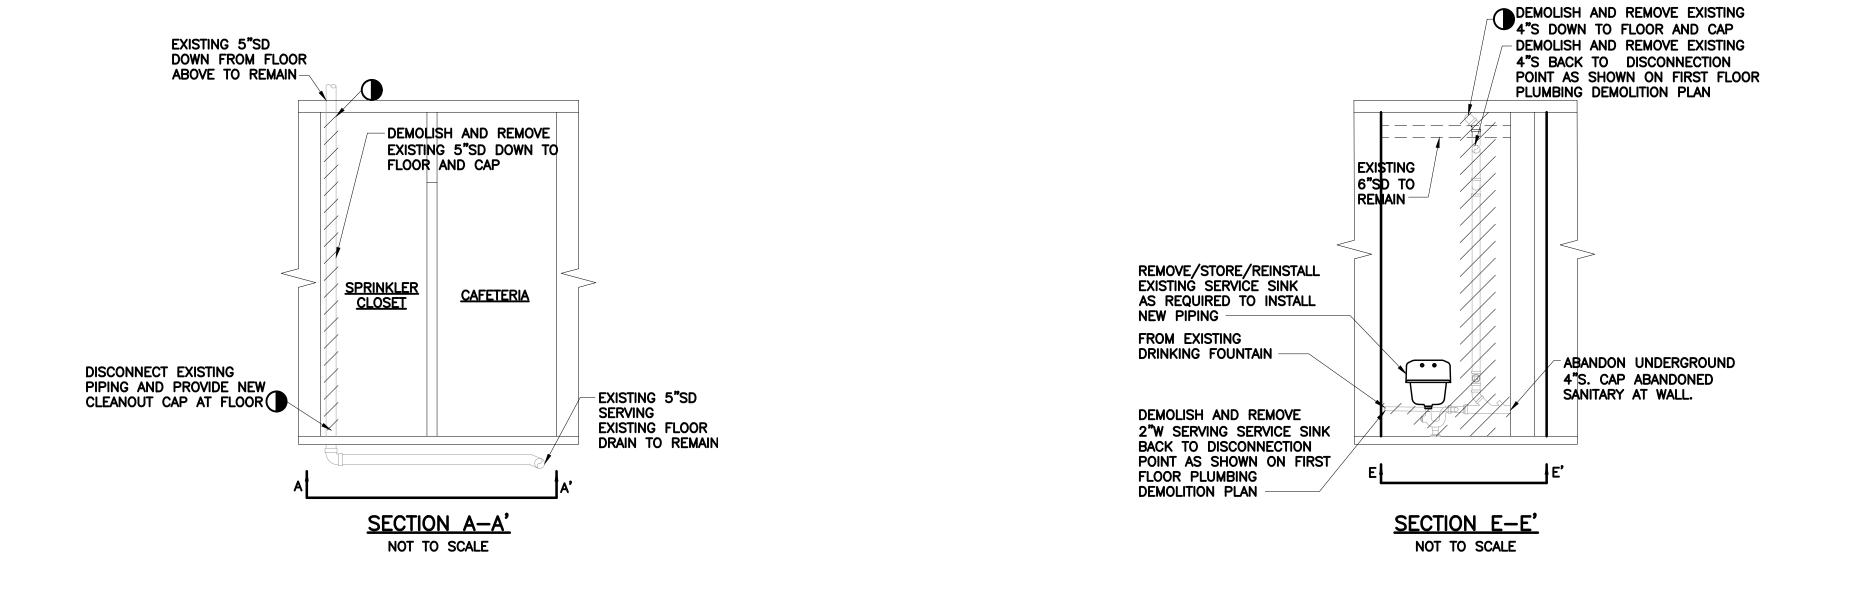

Lorraine Grillo

Peter McCree

Consultants:

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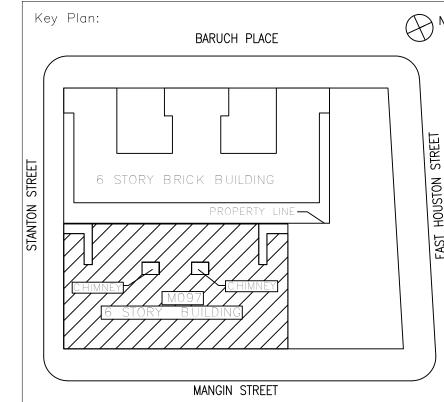
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05/09/2023 ISSUED FOR BID

Revision

No. Date



Block # 325	Lot # 25
SCA Design Manager:	NASER HAMOUDEH, P.E.
Project Architect/Engineer:	JEFFREY RABINER, P.E.
Discipline Lead:	JOHN HIGGINS, P.E.
Designer:	DANIEL GIANNOTTA
Drawn by:	DANIEL GIANNOTTA
Checked by:	JOHN HIGGINS, P.E.

Design No or LLW No.: Building ID: 05/09/2023

BARD COLLEGE HS, MANHATTAN WASTE SYSTEM

525 EAST HOUSTON STREET NEW YORK, NY 10002

FIRST FLOOR PLUMBING REMOVALS PLAN EAST AND SECTIONS


DOB NOW JOB #M00660122-I1

Drawing No.:

Sheets in Contract Set: 36 of 42

Sheets in DOB Set:

33 of 37

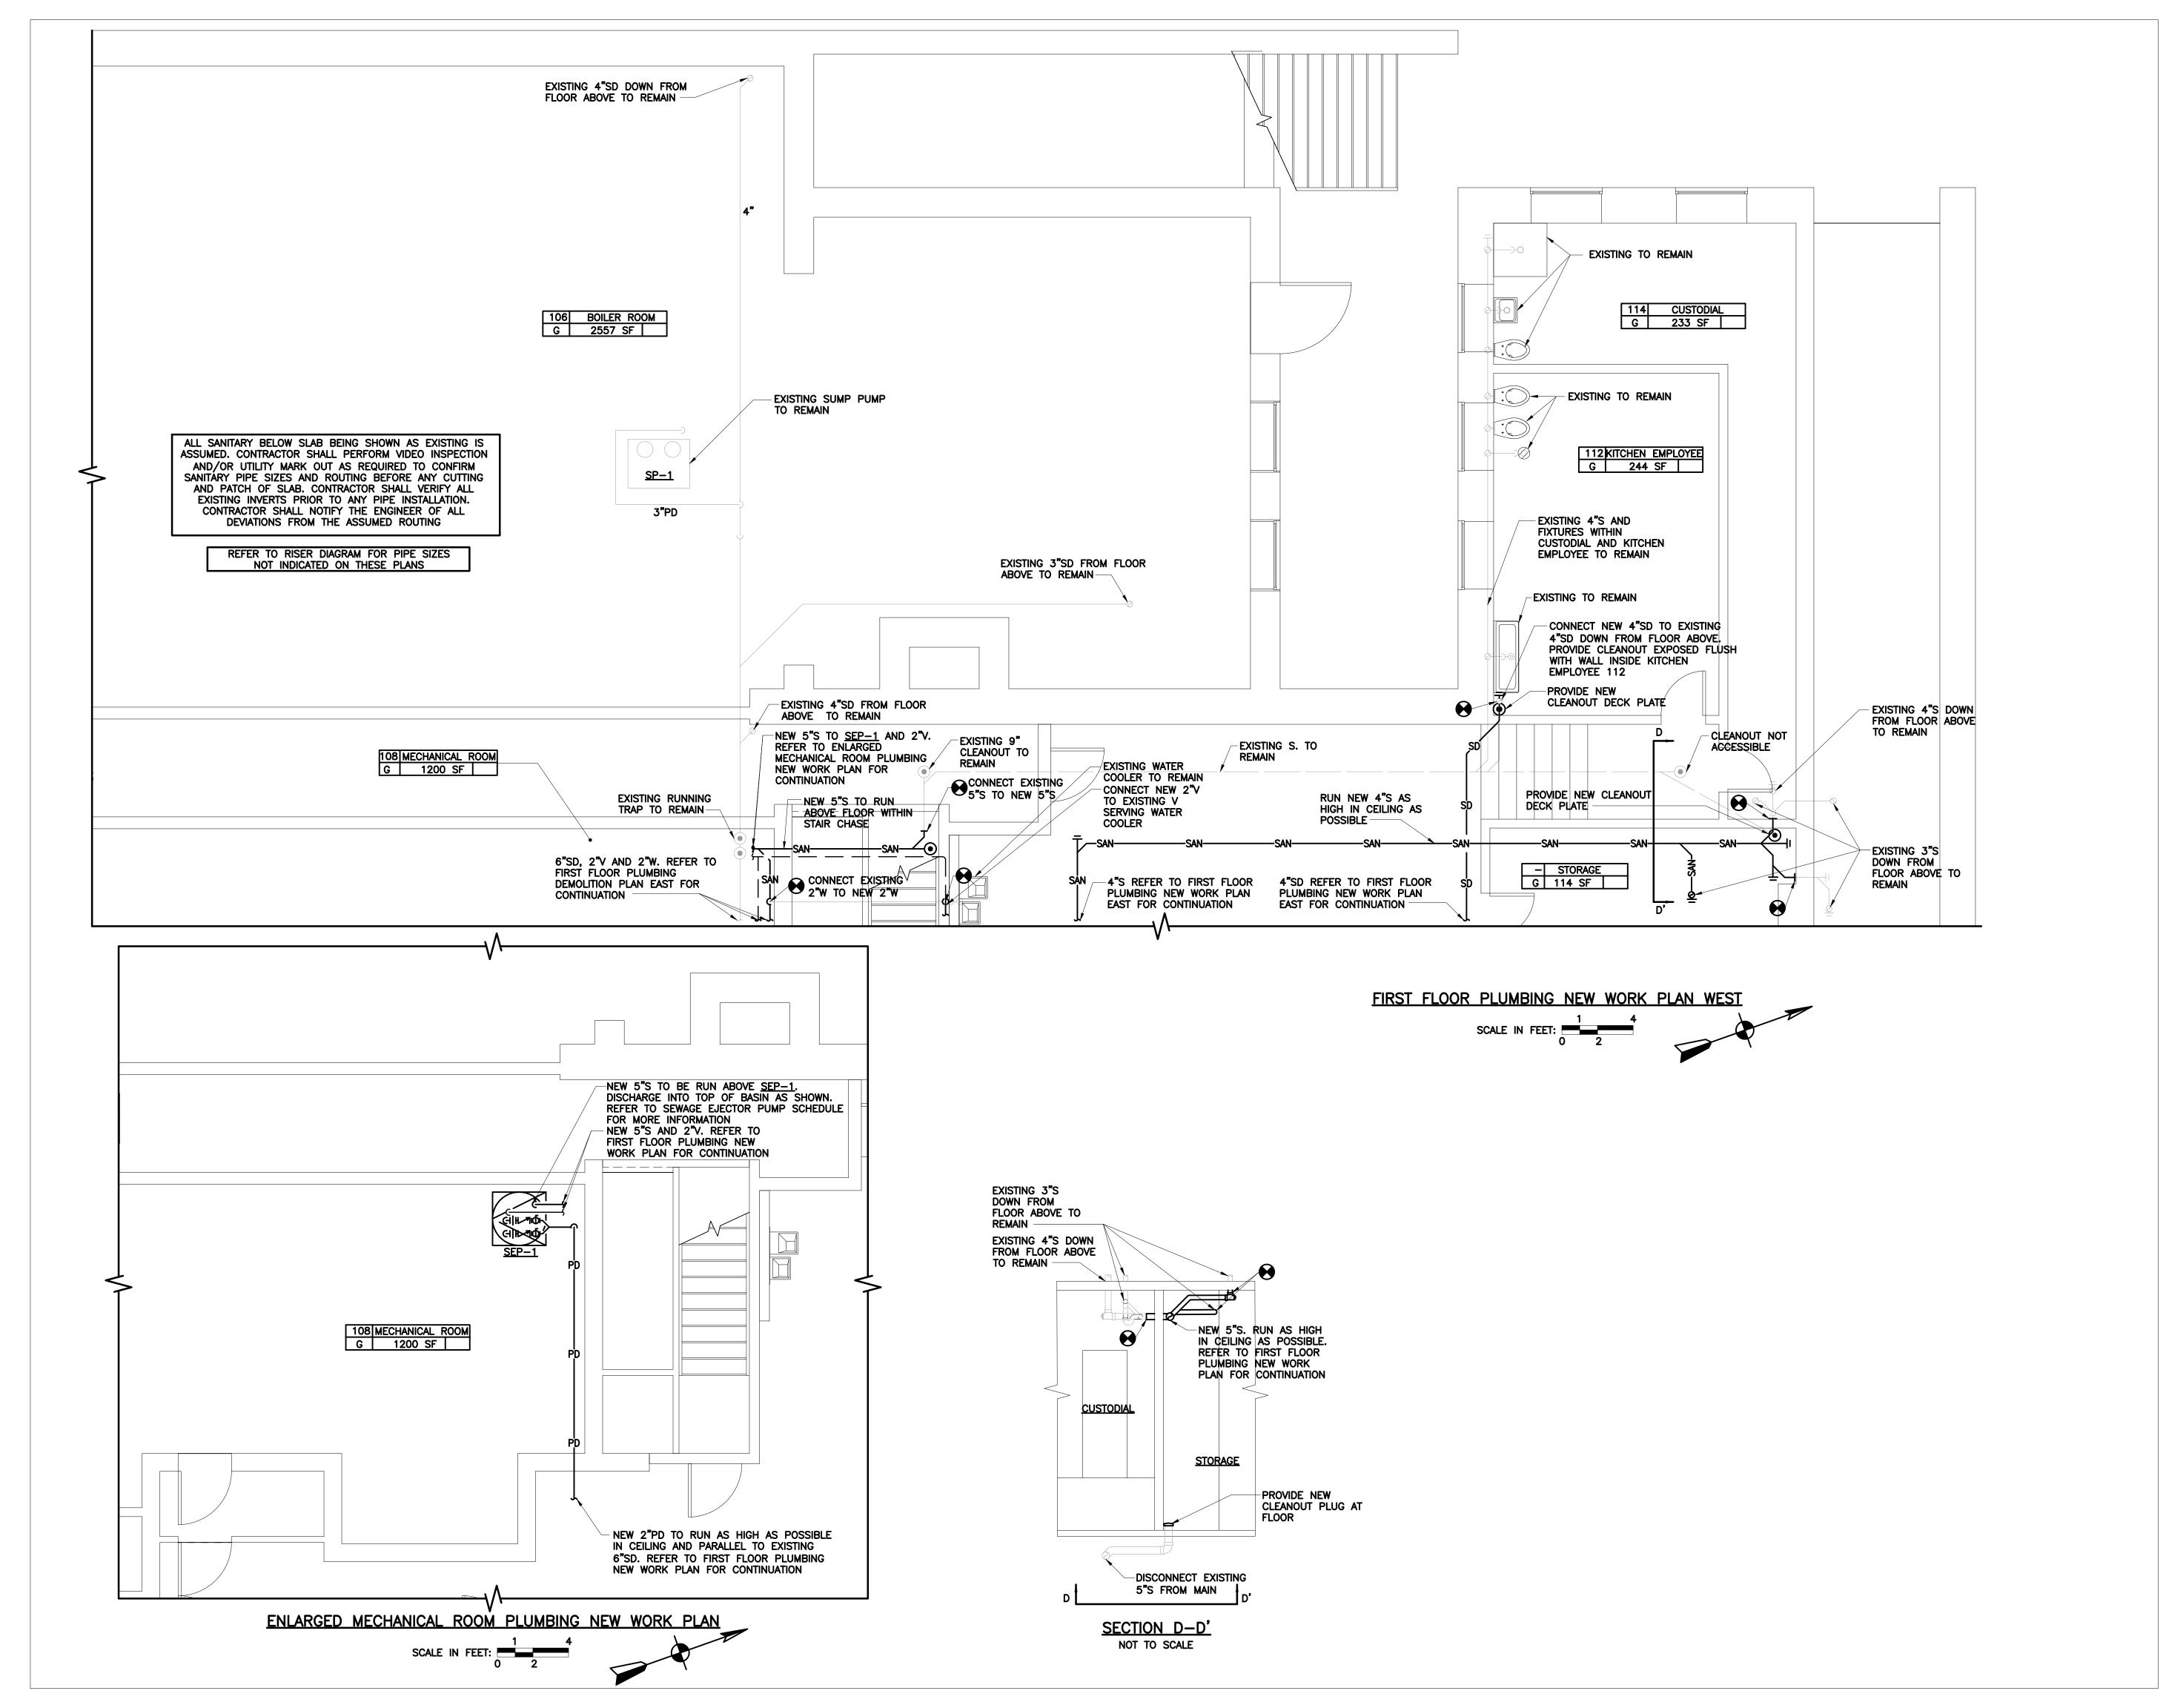

Lorraine Grillo

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SC/

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María A Gómez P.F. LEED AP RD+C Acting Vice

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- 05/09/2023 ISSUED FOR BID

No. Date Revision

Rey Plan:

BARUCH PLACE

6 STORY BRICK BUILDING

PROPERTY LINE

CHIMNEY

MO97

CHIMNEY

MO97

MANGIN STREET

Block # 325

SCA Design Manager:

Project Architect/Engineer:

Discipline Lead:

Designer:

Daniel Giannotta

Daniel Giannotta

Checked by: JOHN HIGGINS, P.E.

Design No or LLW No.: Building ID: Date:

05/09/2023

BARD COLLEGE HS, MANHATTAN WASTE SYSTEM

Address:
525 EAST HOUSTON STREET
NEW YORK, NY 10002

Drawing Title:


FIRST FLOOR PLUMBING NEW WORK PLAN WEST, PART PLAN AND SECTION


DOB NOW JOB #M00660122-I1


P201.00

Sheets in Contract Set: 37 of 42

Sheets in DOB Set: 34 of 37

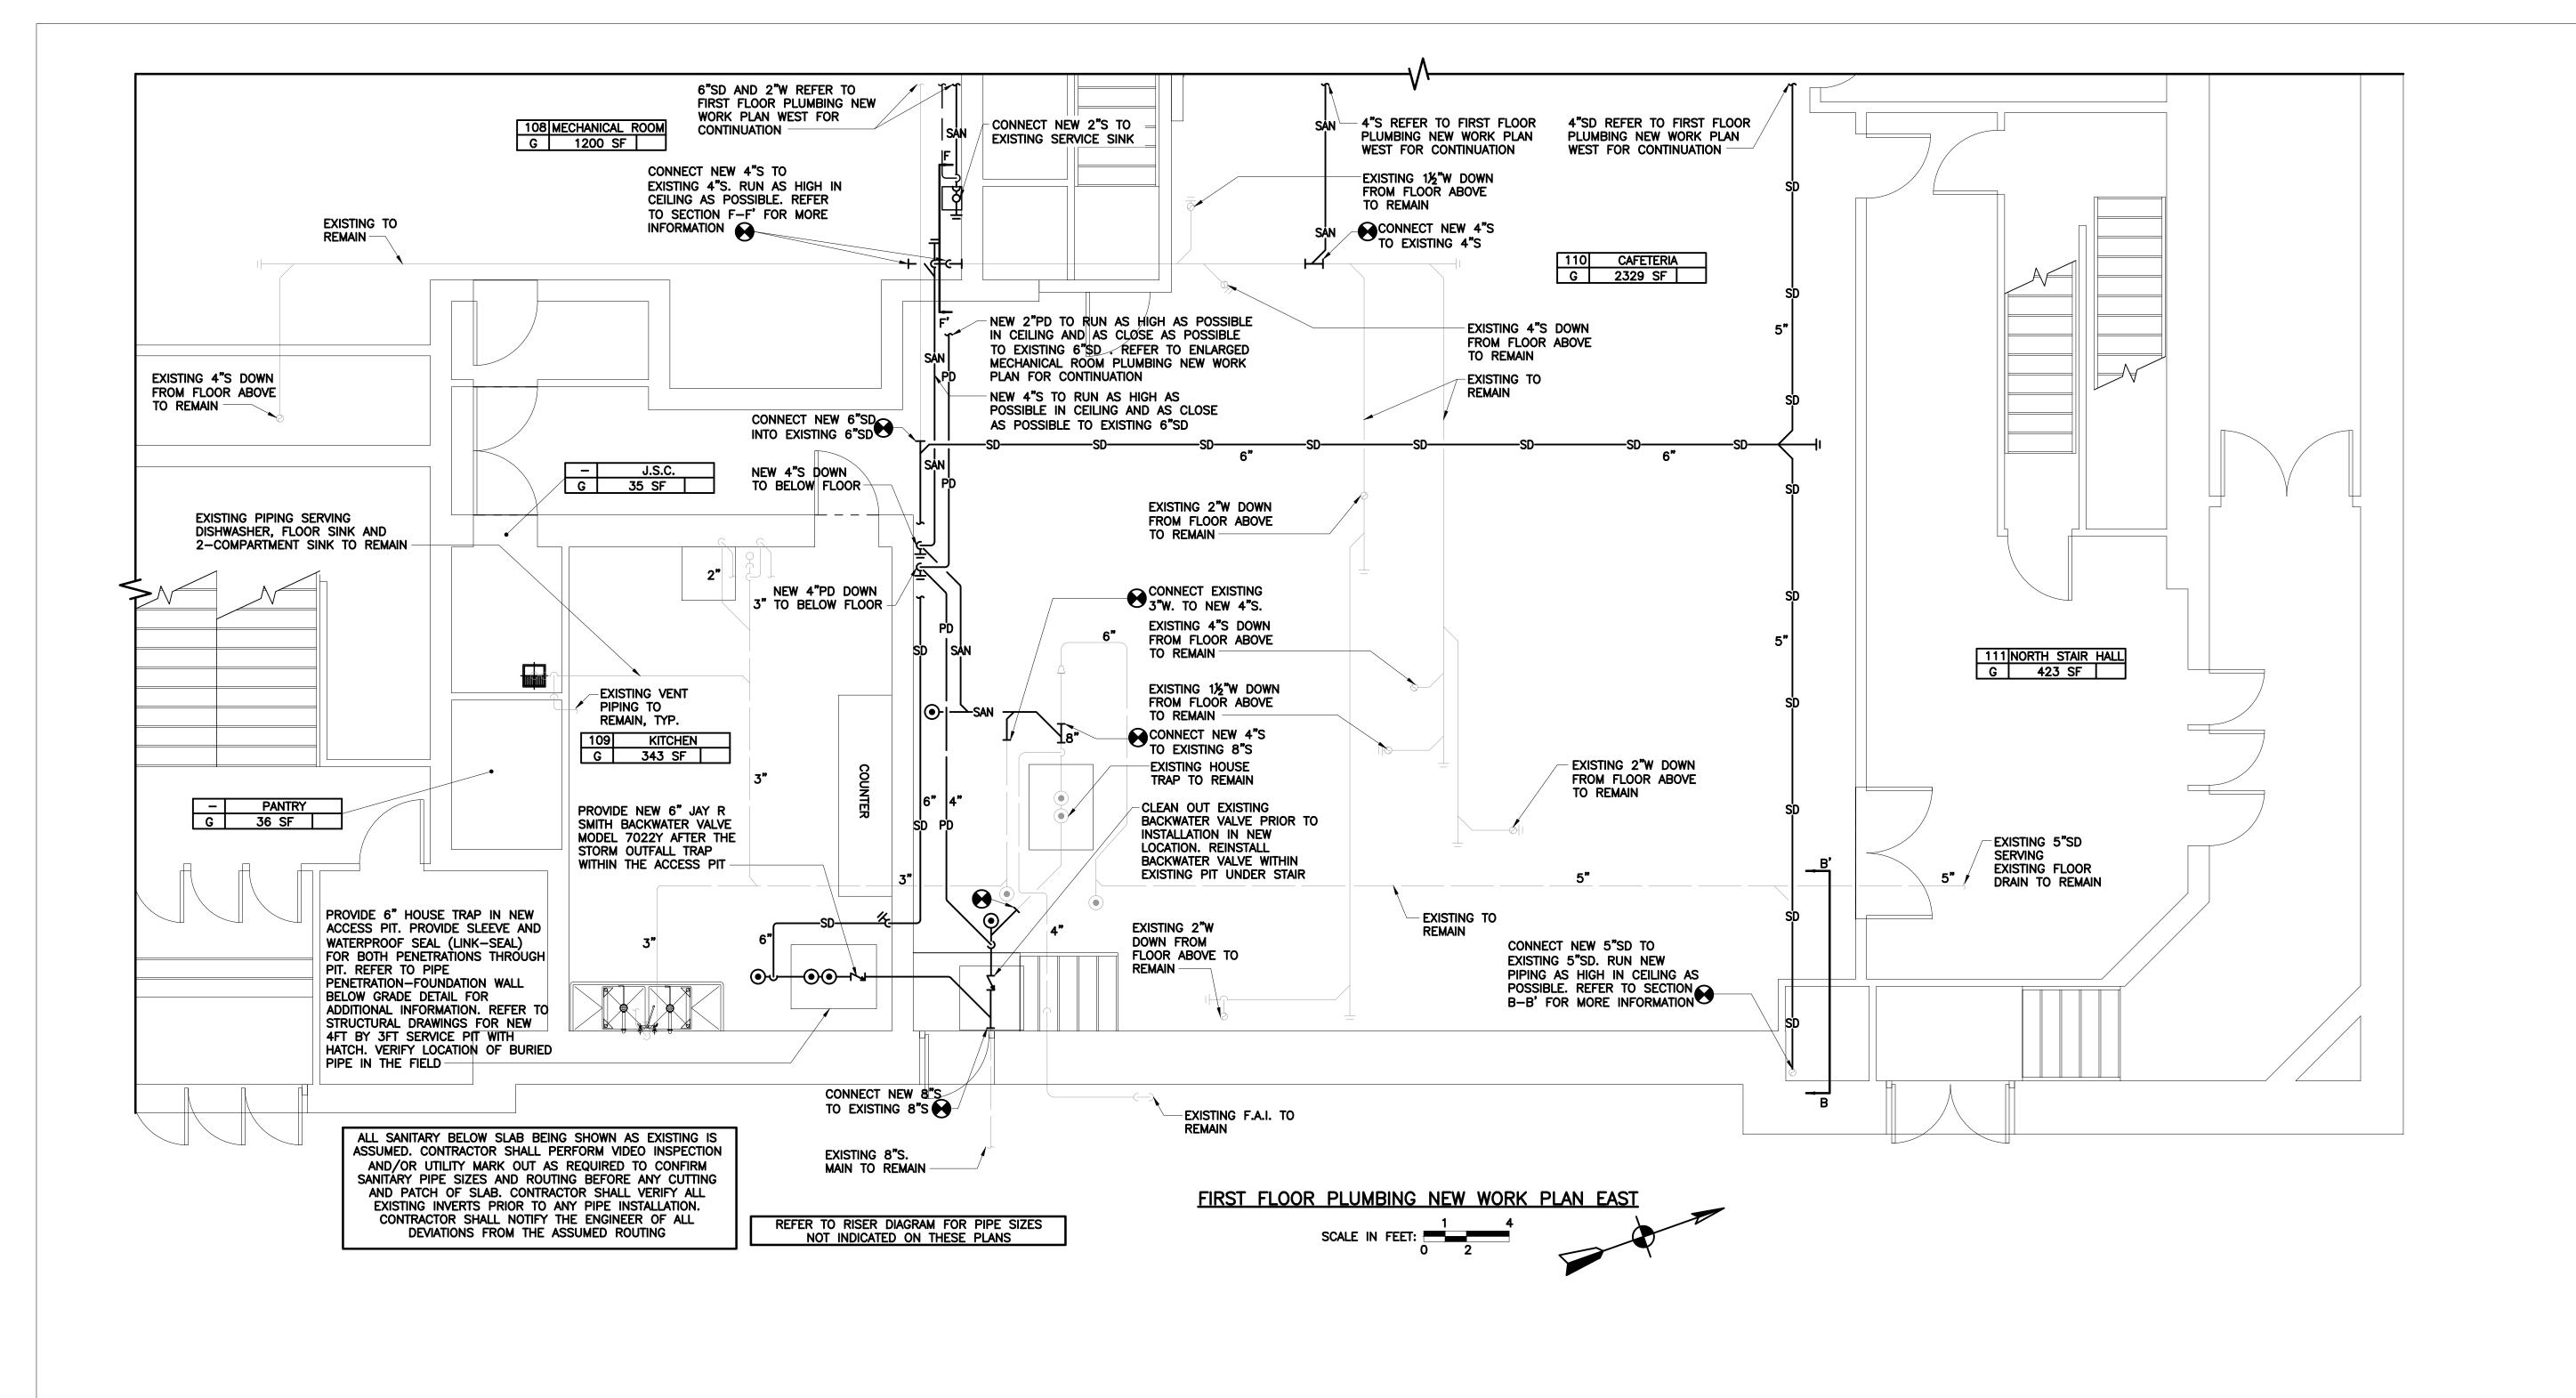

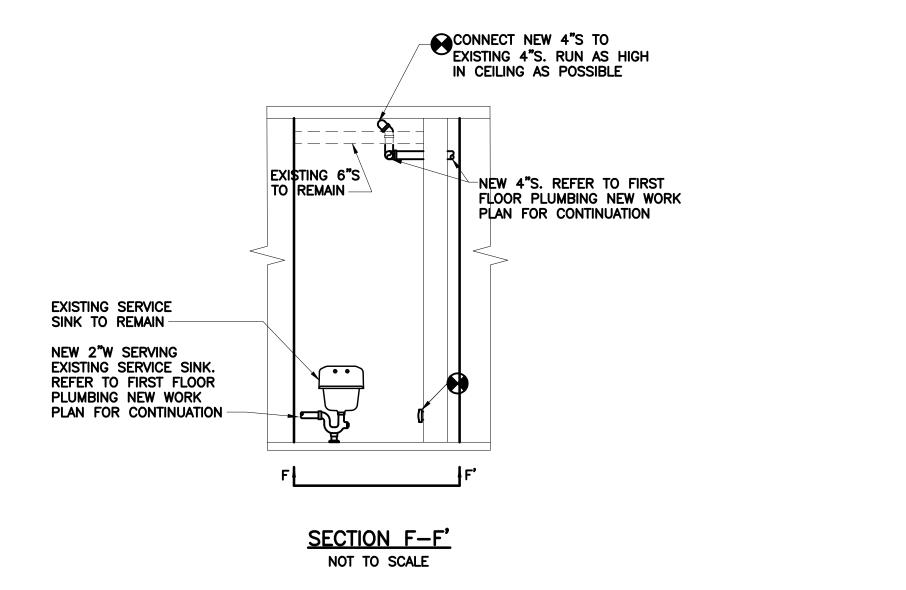

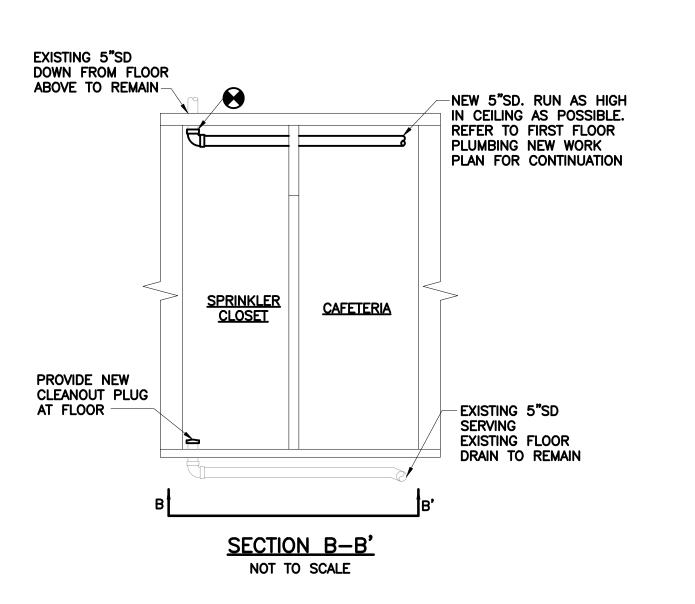

Lorraine Grillo

Peter McCree

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- 05/09/2023 ISSUED FOR BID

No. Date Revision

BARUCH PLACE

6 STORY BRICK BUILDING

PROPERTY LINE

CHIMNEY

MO97

CHIMNEY

B STORY BUILDING

SCA Design Manager:	NASER HAMOUDEH, P.E.
Project Architect/Engineer:	JEFFREY RABINER, P.E.
Discipline Lead:	JOHN HIGGINS, P.E.
Designer:	DANIEL GIANNOTTA
Drawn by:	DANIEL GIANNOTTA
	101111 111001110 7 5

MANGIN STREET

Lot # 25

Checked by: JOHN HIGGINS, P.E.

Design No or LLW No.: Building ID: Date: 05/09/2023

BARD COLLEGE HS, MANHATTAN WASTE SYSTEM

Address:
525 EAST HOUSTON STREET
NEW YORK, NY 10002

awina Title:

Block # 325


FIRST FLOOR PLUMBING NEW WORK PLAN EAST AND SECTIONS


DOB NOW JOB #M00660122-I1

P202.00

Sheets in Contract Set: 38 of 42

Sheets in DOB Set: 35 of 37

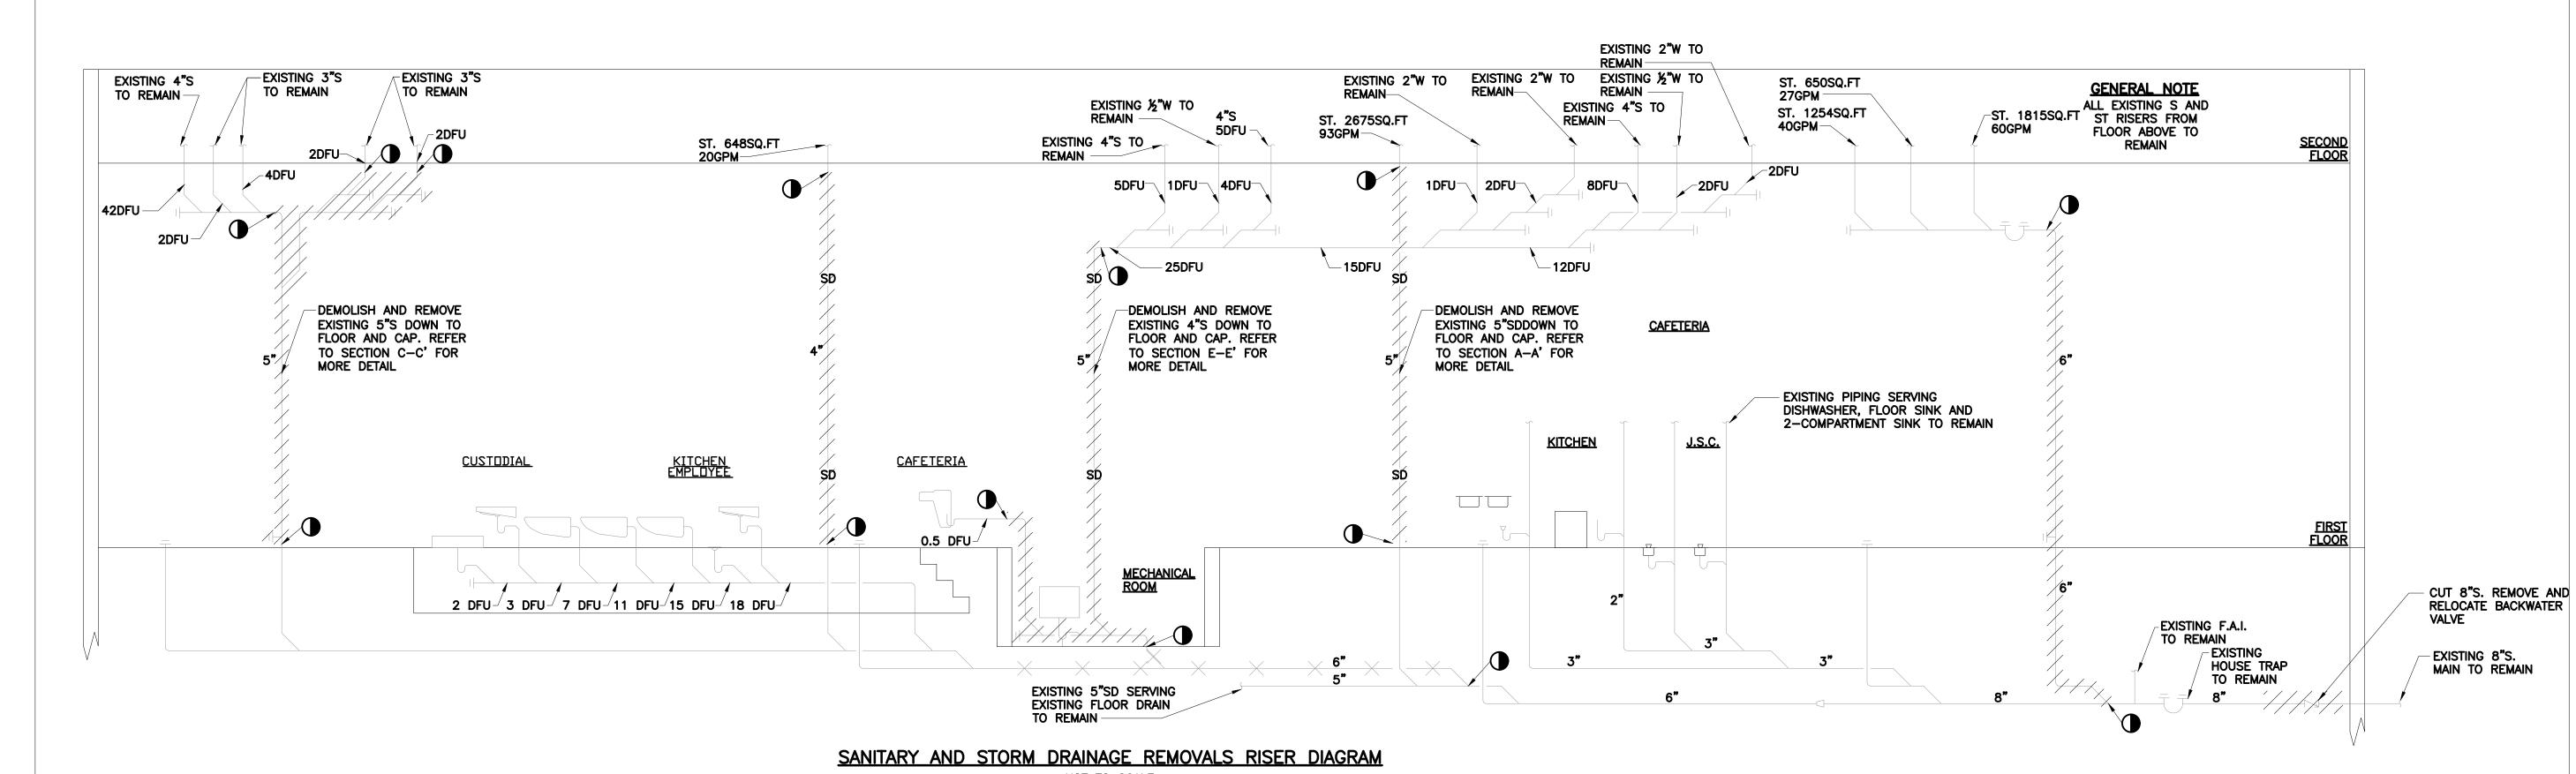

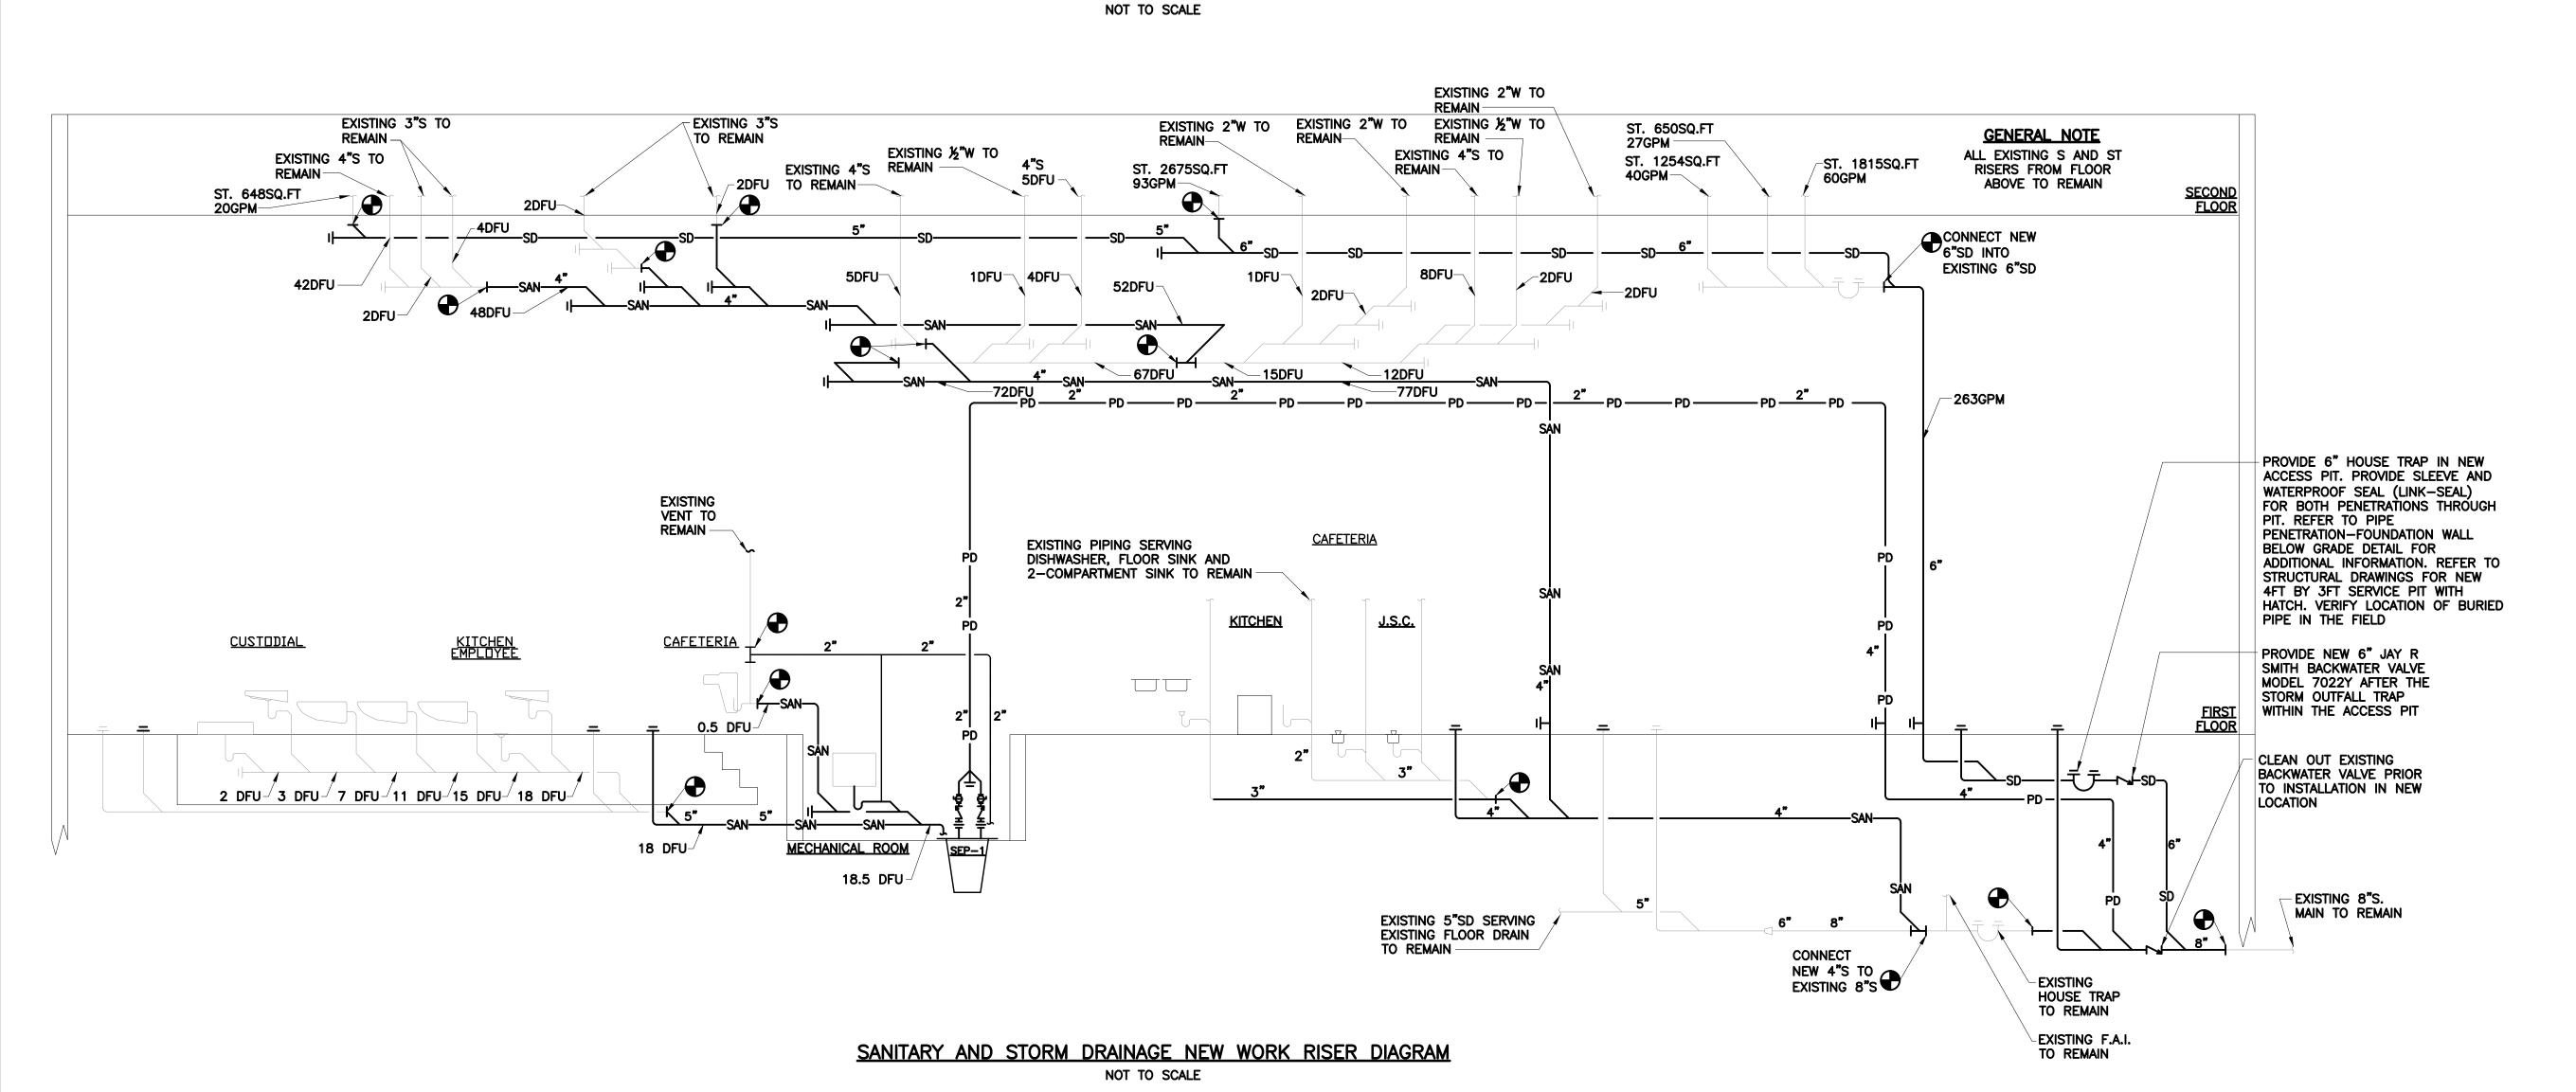

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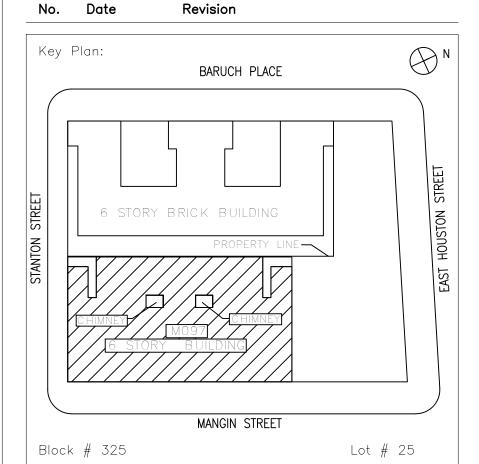
44 West 28th Street, 5 FL / New York, NY 10001 P 212.242.3735 / F 212.242.7460

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SCA Design Manager:		NASER HAMOU	DEH, P.E.
Project Architect/Engine	er:	JEFFREY RABIN	NER, P.E.
Discipline Lead:		JOHN HIGGINS	, P.E.
Designer:		DANIEL GIANNOTTA	
Drawn by:		DANIEL GIANNO	OTTA
Checked by:		JOHN HIGGINS	, P.E.
Design No or LLW No.:	Building	ID:	Date:

Project:
BARD COLLEGE HS, MANHATTAN
WASTE SYSTEM

Address:
525 EAST HOUSTON STREET
NEW YORK, NY 10002

Drawing Title:
SANITARY AND STORM
DRAINAGE RISER DIAGRAMS


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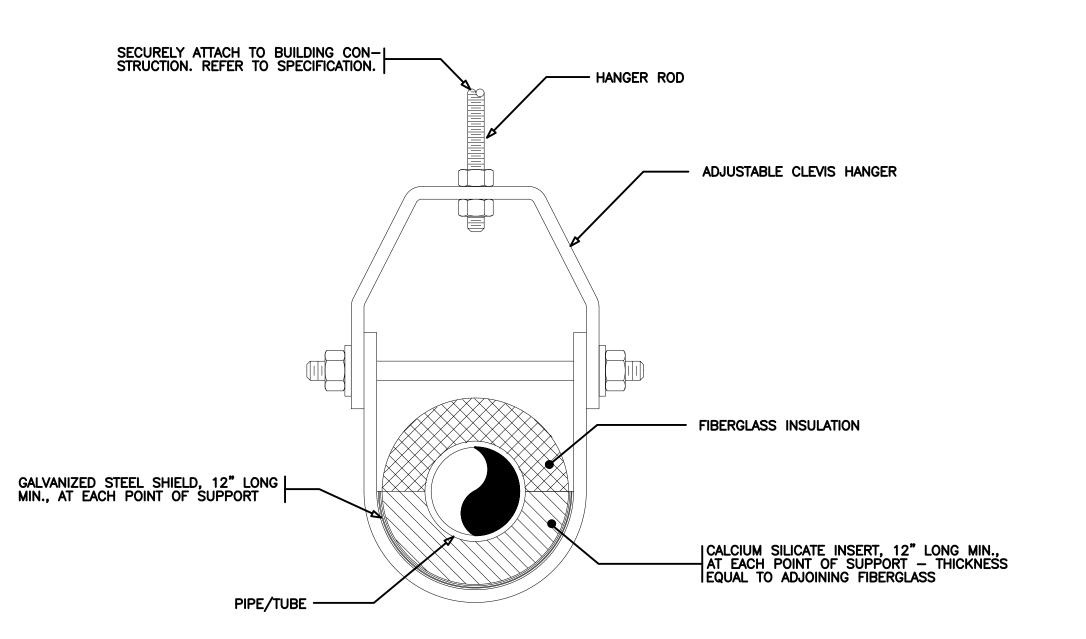
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Sheets in Contract Set: 39 of 42

05/09/2023


Sheets in DOB Set: 36 of 37



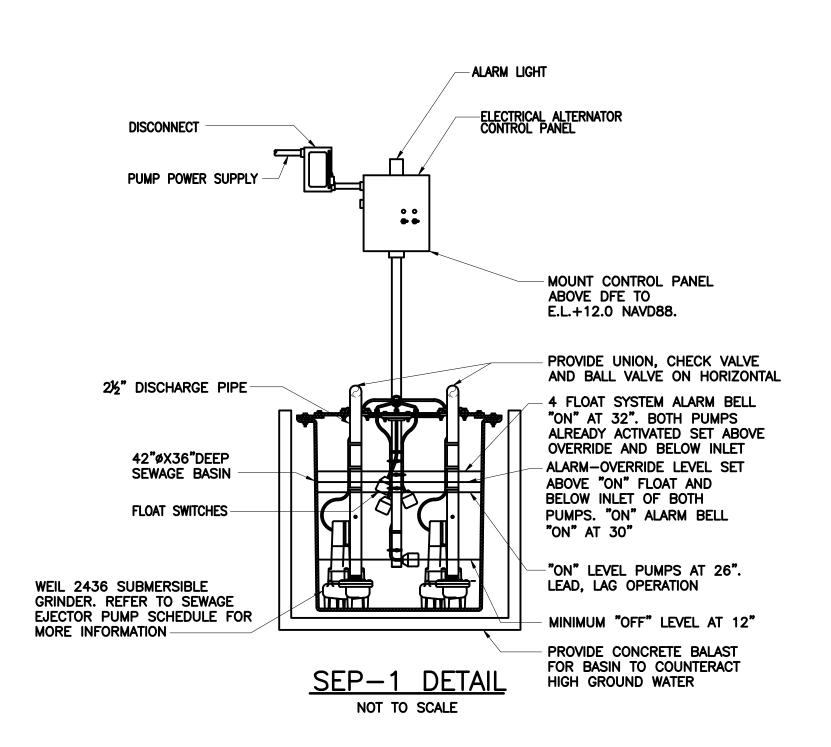


ADJUSTABLE CLEVIS PIPE SUPPORT

FOR INSULATED PIPING/TUBING LARGER THAN 1"
NOT TO SCALE

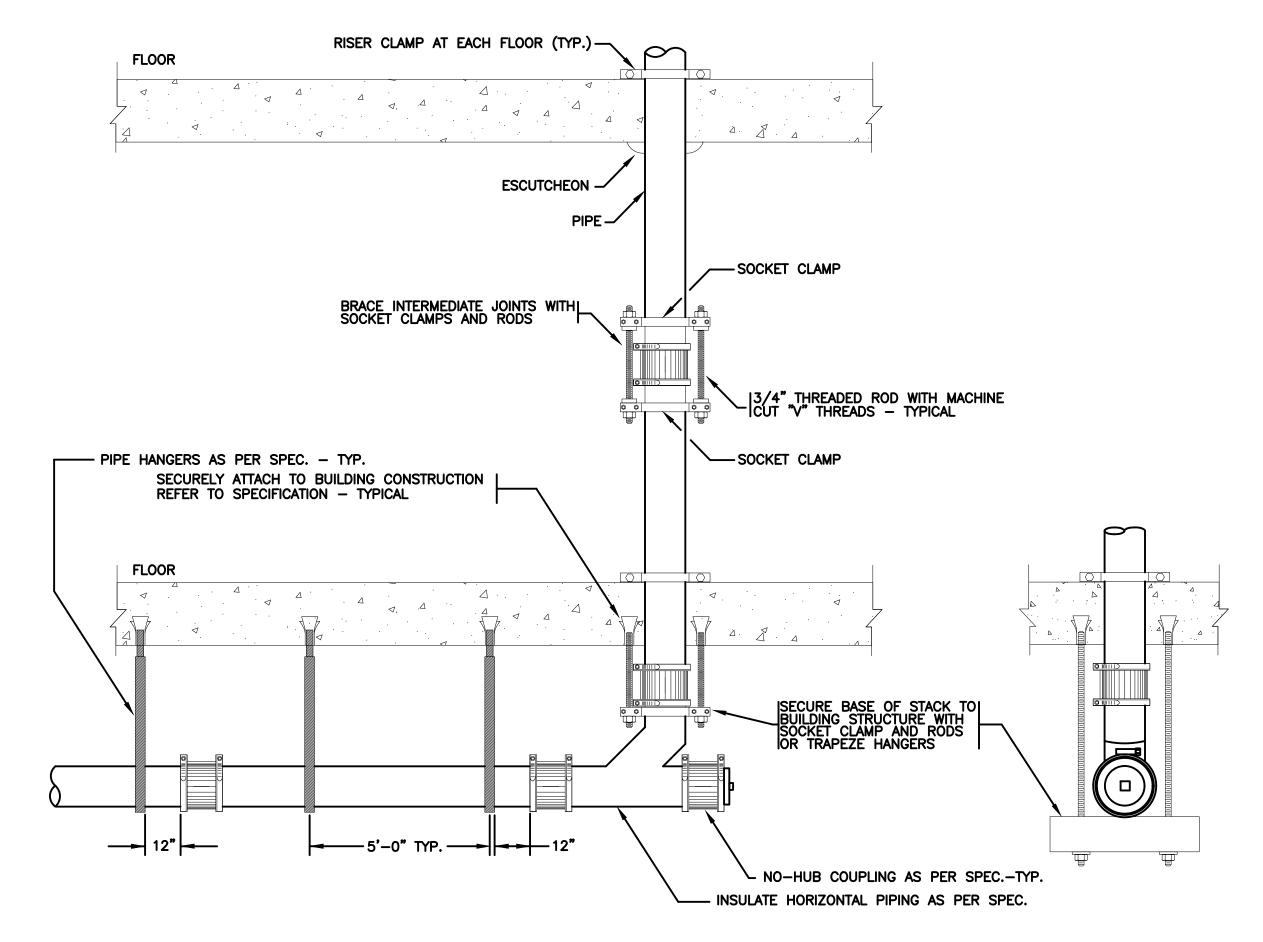

NO-HUB PIPE BRACING FOR VERTICAL PIPING
NOT TO SCALE

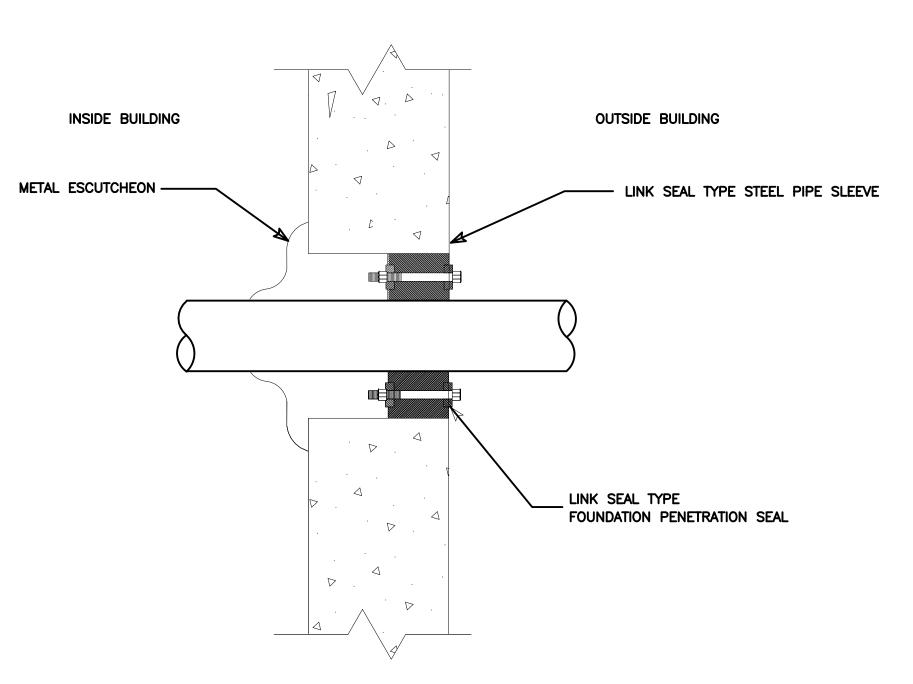

PIPE PENETRATION — FOUNDATION WALL BELOW GRADE

NOT TO SCALE

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A. Nina Kubota

Lorraine Grillo Peter McCree

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Ysrael A. Seinuk Structural Consultant 228 East 45th Street / New York, NY 10017 P 212.687.2233 / F 646.487.5555

NOTE: Drawing may be printed at reduced scale


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- 05/09/2023 ISSUED FOR BID

No. Date Revision

Key Plan:

BARUCH PLACE

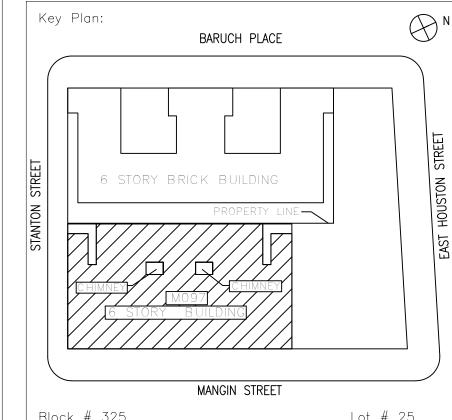

BIOCK # 325	LOT # 25		
SCA Design Manager:	NASER HAMOUDEH, P.E.		
Project Architect/Engineer:	JEFFREY RABINER, P.E.		
Discipline Lead:	JOHN HIGGINS, P.E.		
Designer:	DANIEL GIANNOTTA		
Drawn by:	DANIEL GIANNOTTA		
Checked by:	JOHN HIGGINS, P.E.		

BARD COLLEGE HS, MANHATTAN WASTE SYSTEM

Address: 525 EAST HOUSTON STREET NEW YORK, NY 10002


Drawing Title:
PLUMBING DETAILS

DOB NOW JOB #M00660122-I1

P401.00

Sheets in Contract Set: 40 of 42

Sheets in DOB Set: 37 of 37

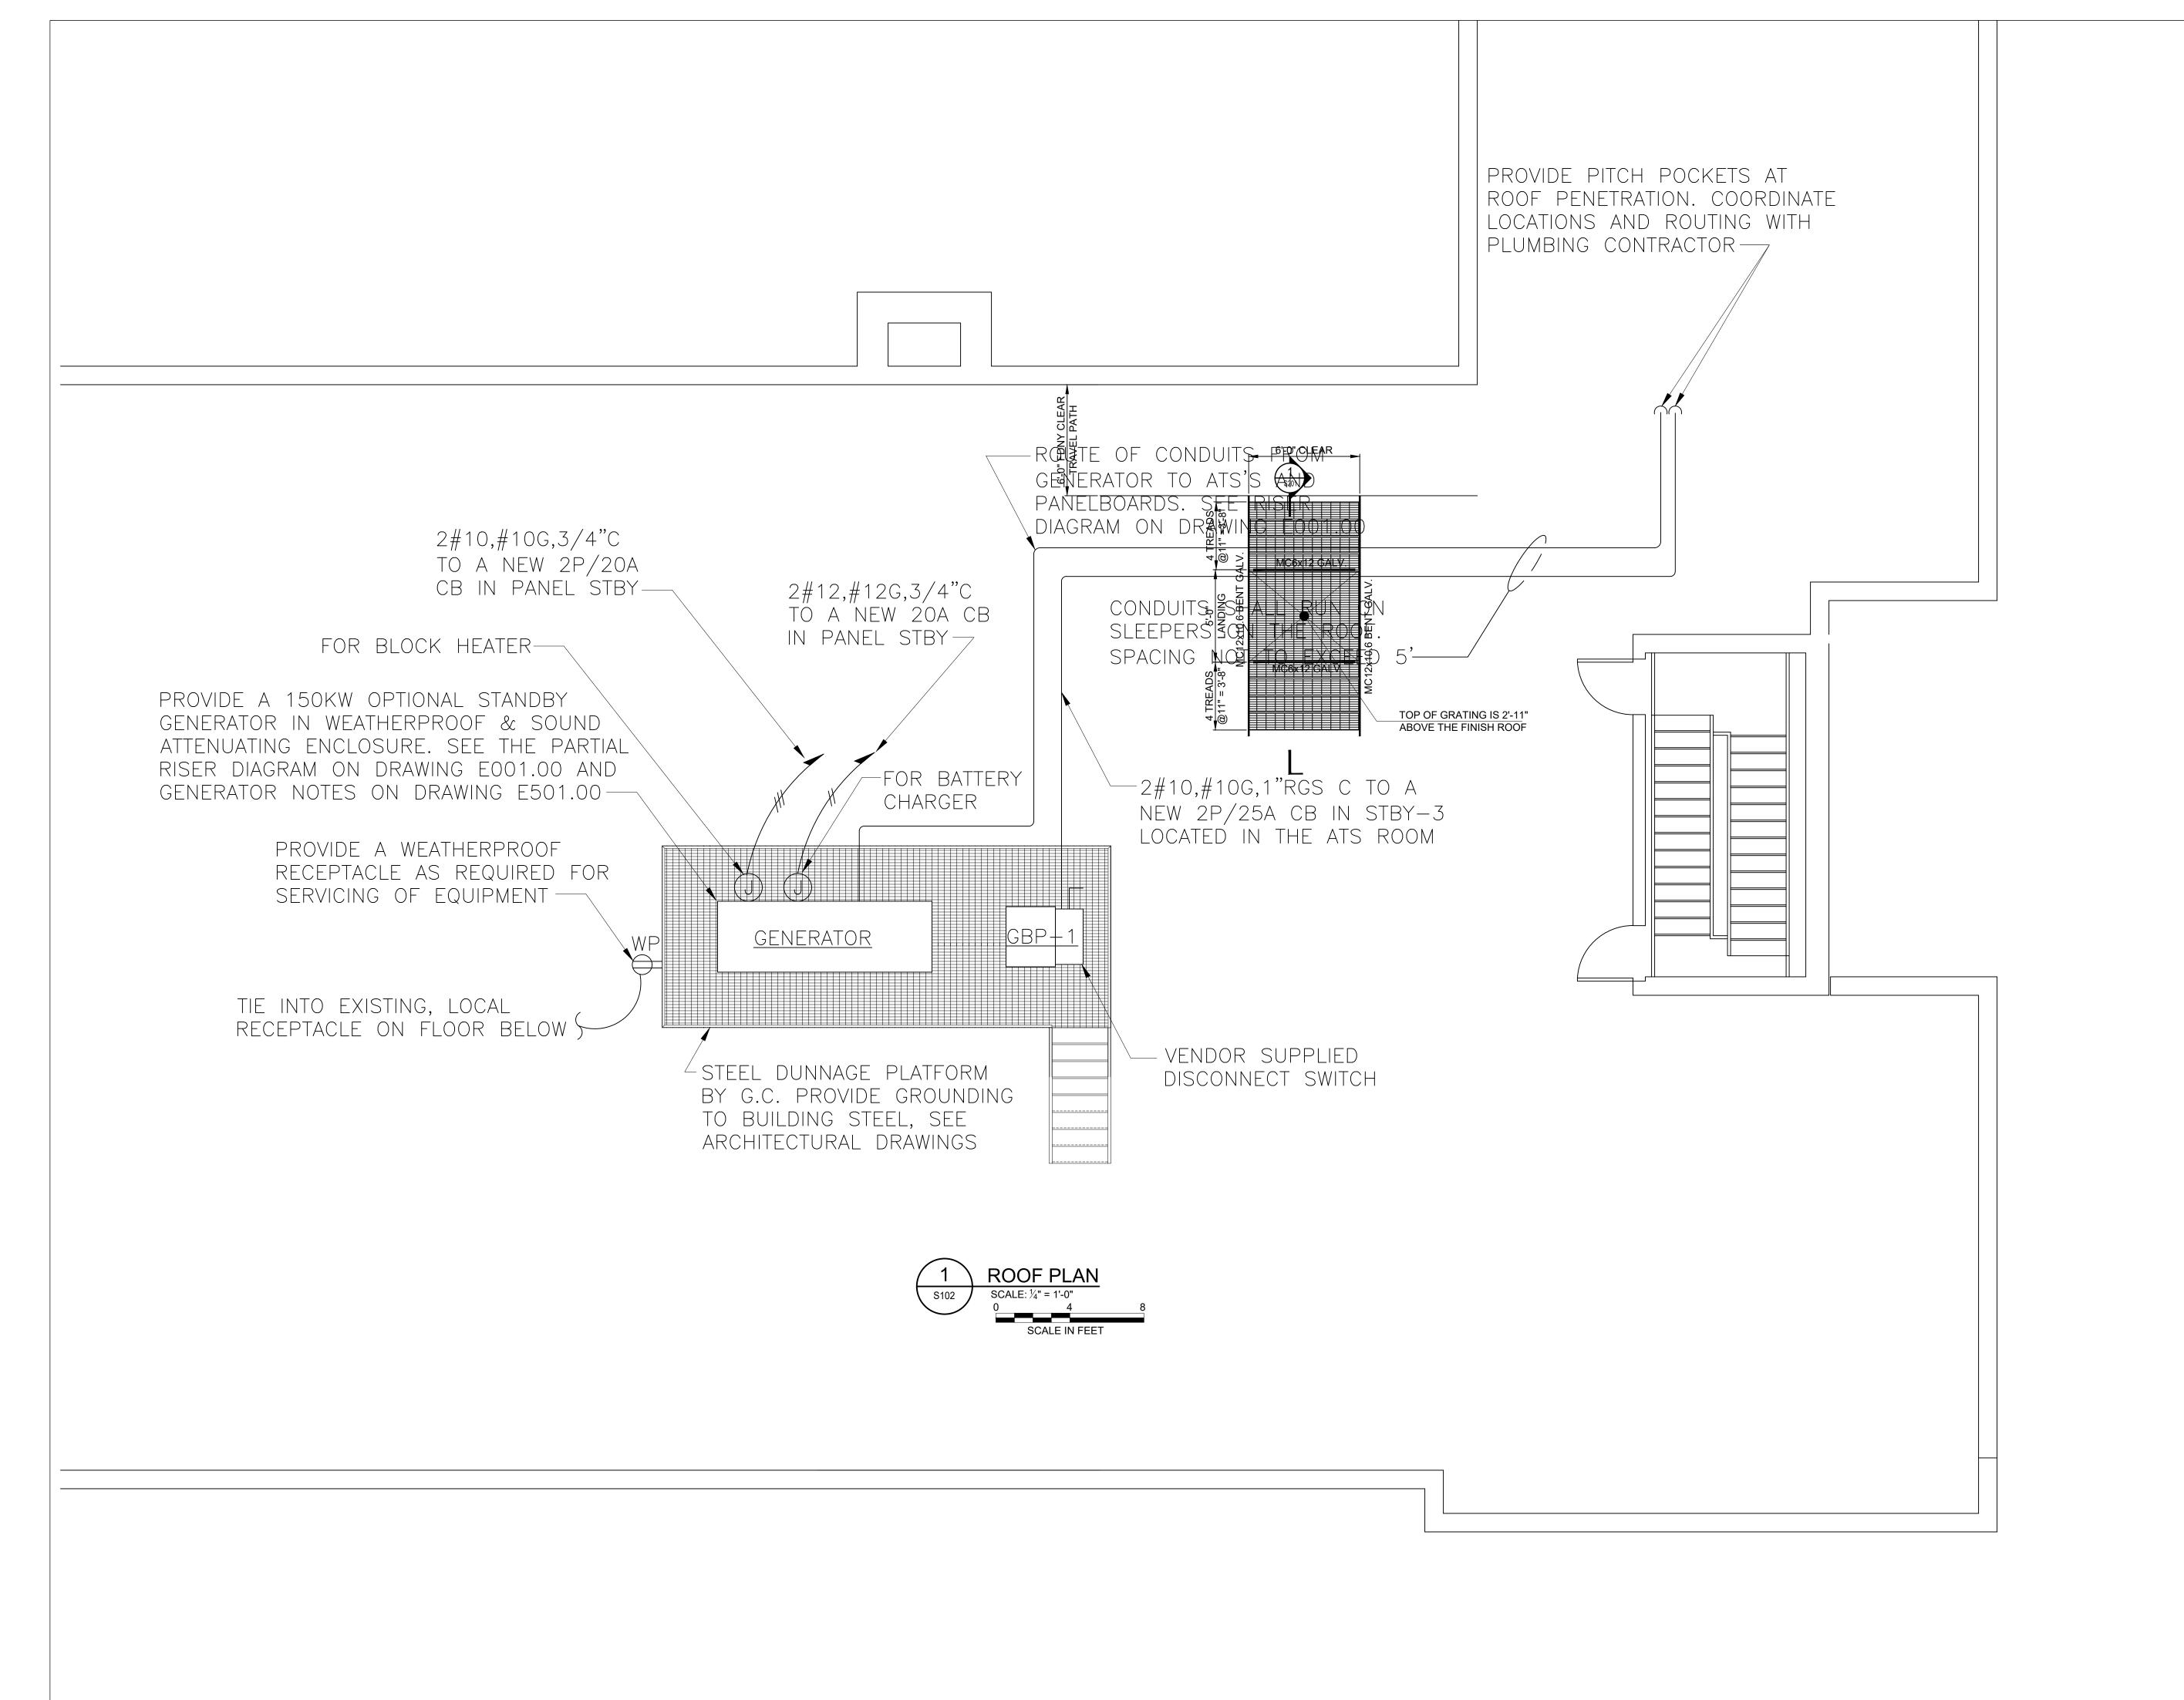

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Senior Director In-House Design Studio

Design Consultant Management Studio
Aileen del Prado, P.E. LEED AP BD+C, Senior Director



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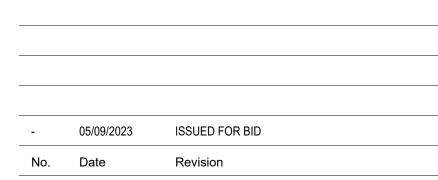
GoshowArchitects


44 West 28th Street, 5 FL / New York, NY 10001 P 212.242.3735 / F 212.242.7460

Ysrael A. Seinuk **Structural Consultant** 228 East 45th Street / New York, NY 10017 P 212.687.2233 / F 646.487.5555

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Block # 325	Lot # 25	
SCA Design Manager:	NASER HAMOUDEH, P.E.	
Project Architect/Engineer:	DAMIAN E. MONTEIRO, PE	
Discipline Lead:	JOHN HIGGINS, PE	
Designer:	QUINEE QUINTANA, PE	
Drawn by:	VLAD SCHNEIDER	
Checked by:	DAMIAN E. MONTEIRO, PE	

Design No or LLW No.: Building ID: 05/09/2023 M097

BARD COLLEGE HS, MANHATTAN WASTE SYSTEM

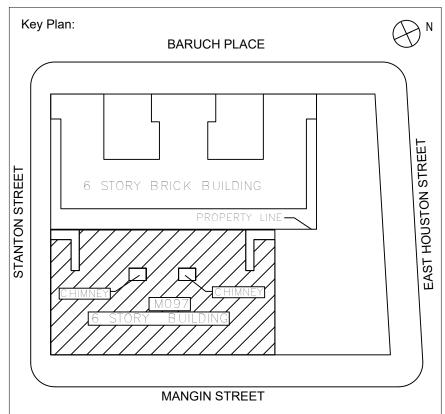525 EAST HOUSTON STREET NEW YORK, NY 10002


ROOF PLAN

DOB NOW Job# M00660122-S2

S102.00

Sheets in Contract Set: 31 of 42

Sheets in DOB Set: 28 of 37

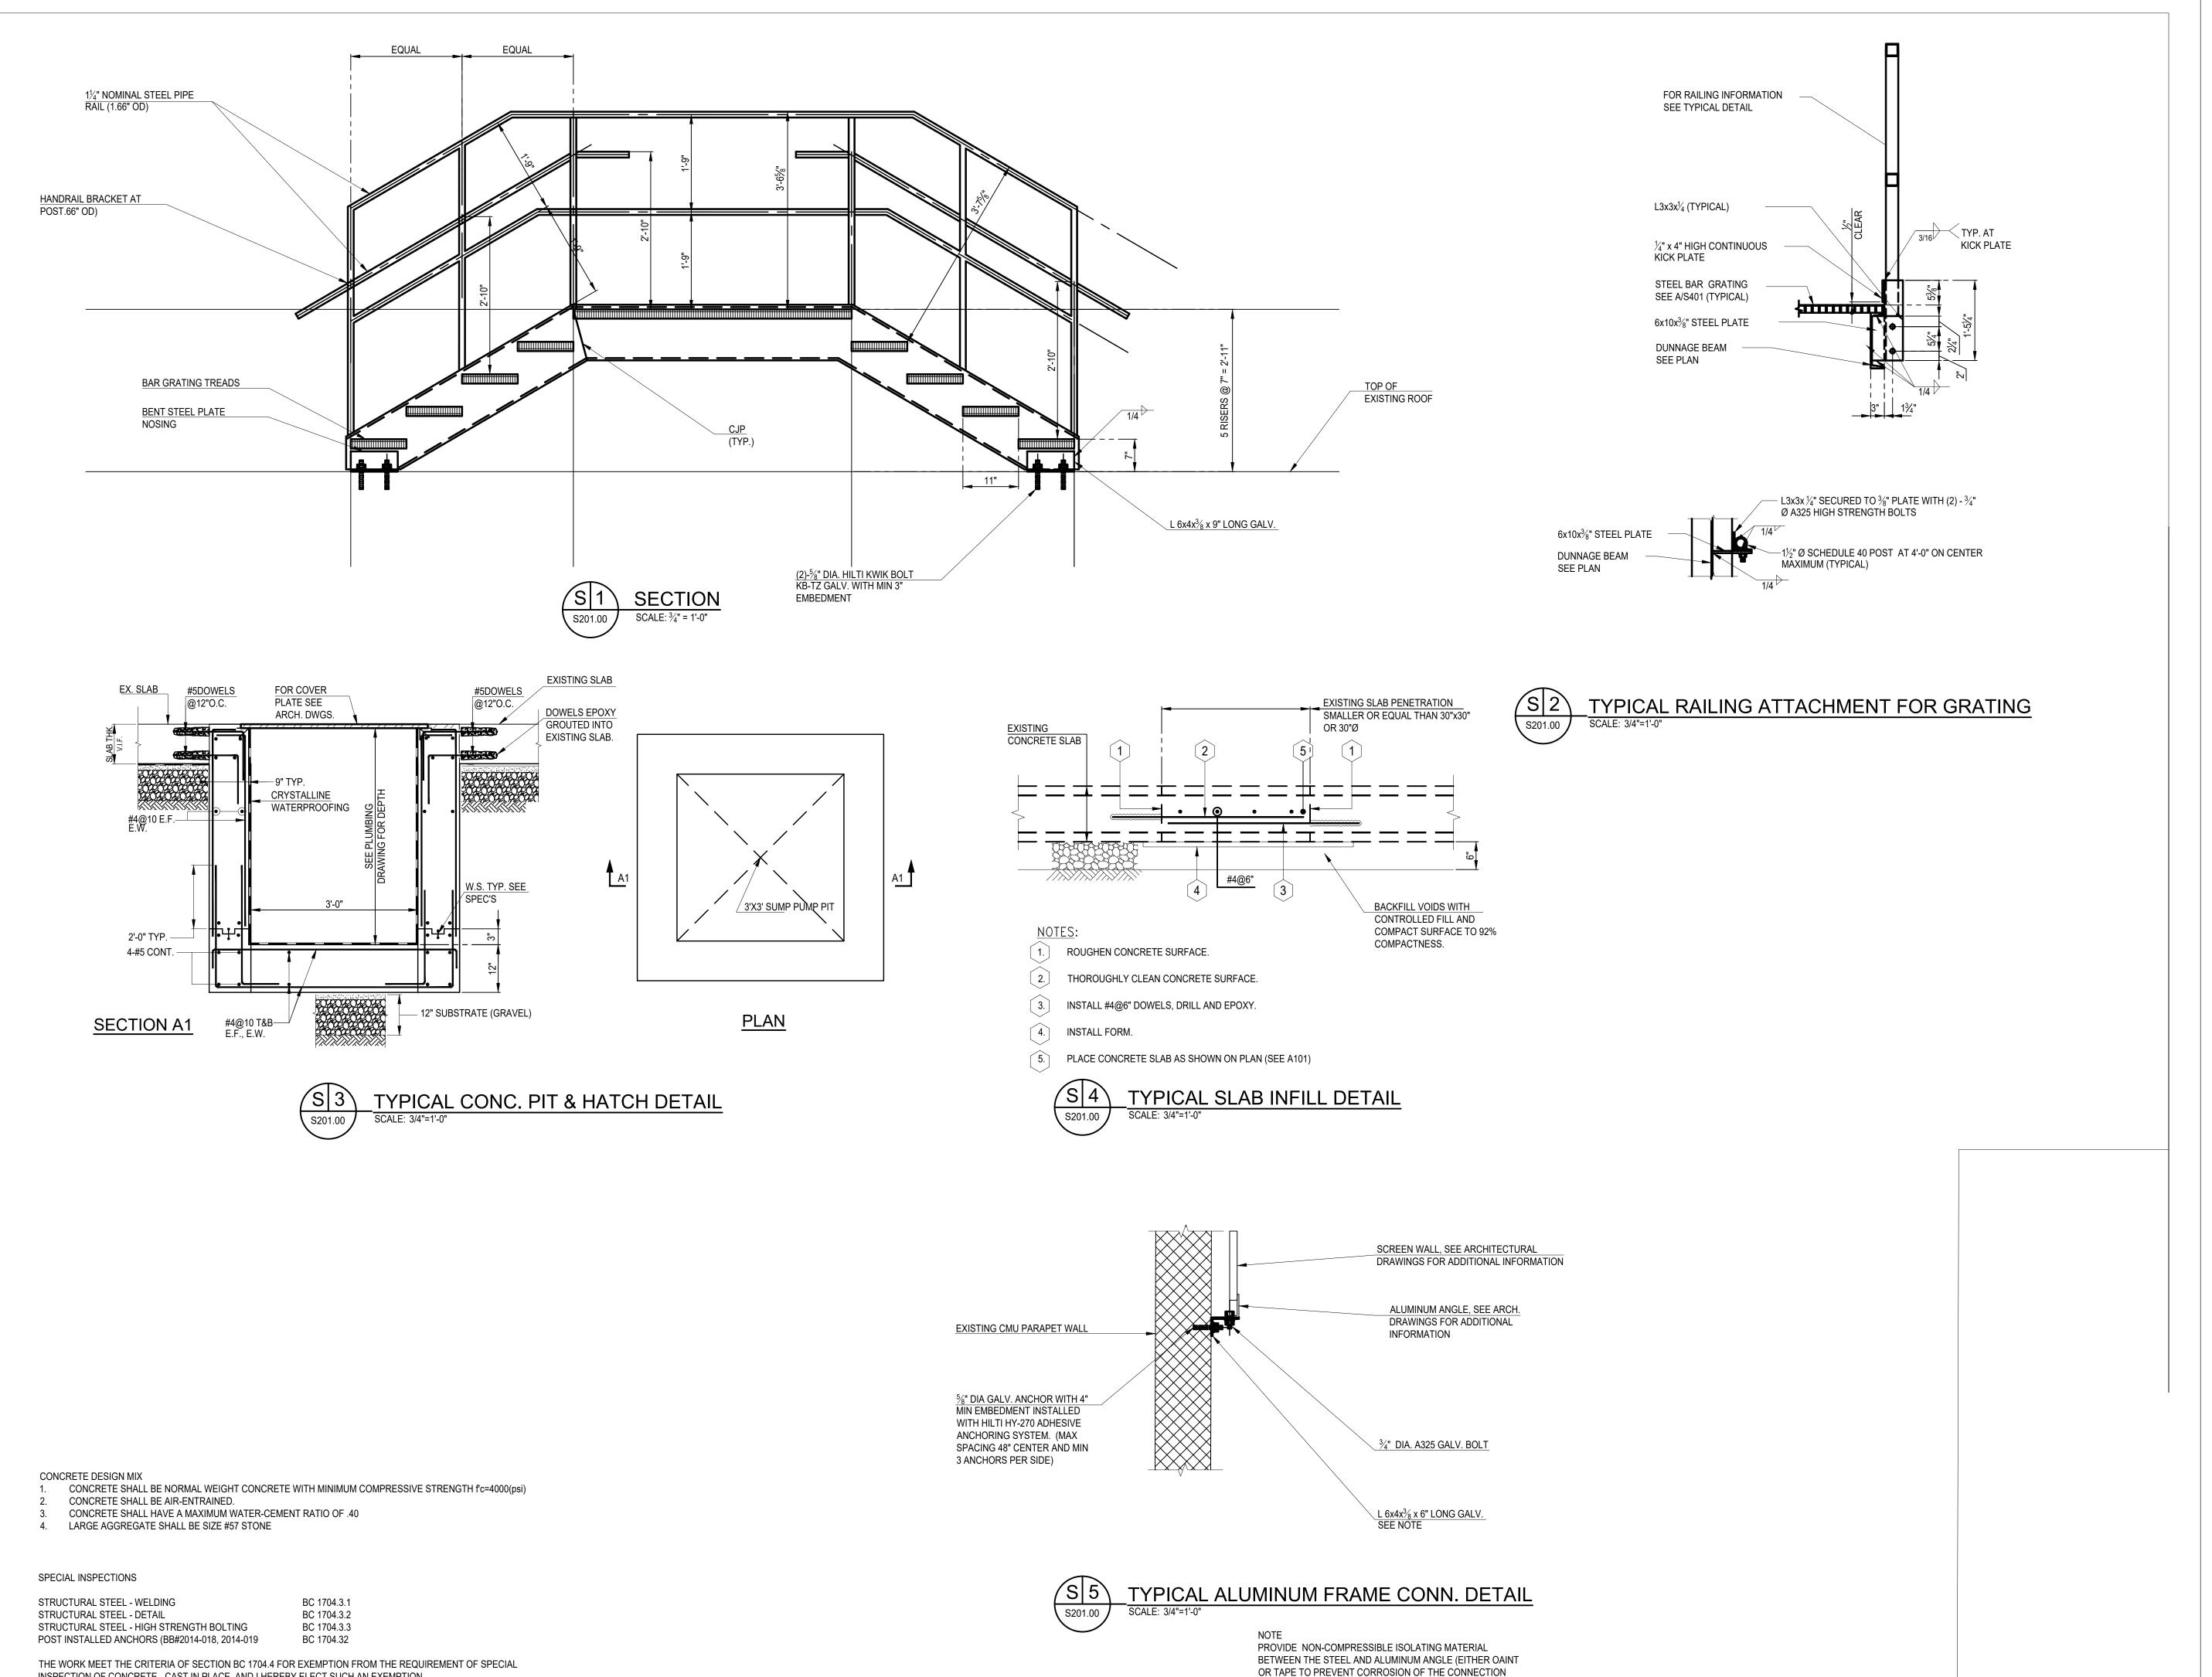

INSPECTION OF CONCRETE - CAST IN PLACE, AND I HEREBY ELECT SUCH AN EXEMPTION.

THE REQUIREMENT OF CONCRETE TESTING AND OF THE TR2 FORM AND/OR TR3 FORM.

THE WORK MEET THE EXEMPTION CRITERIA OF BUILDINGS BULLETIN 2009-026, ITEM IV, AND I HEREBY ELECT TO WAIVE

President & CEO A. Nina Kubota

Lorraine Grillo

Board of Trustees Chancellor David C. Banks, Chairman

Peter McCree Architecture & Engineering María A. Gómez, P.E. LEED AP BD+C, Acting Vice President

Design Consultant Management Studio Aileen del Prado, P.E. LEED AP BD+C, Senior Director

Senior Director In-House Design Studio

Consultants:

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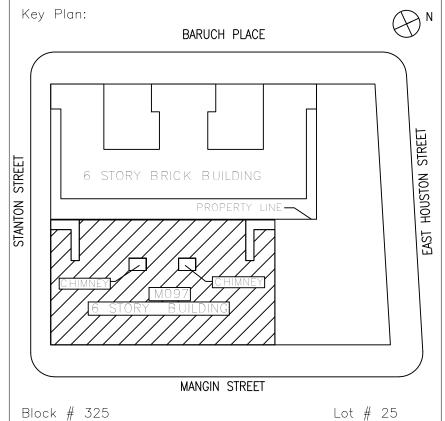
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P 212.687.2233 / F 646.487.5555

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05/09/2023 ISSUED FOR BID No. Date Revision



NASER HAMOUDEH, P.E. SCA Design Manager: DAMIAN E. MONTEIRO, PE Project Architect/Engineer: JOHN HIGGINS, PE Discipline Lead: QUINEE QUINTANA, PE Designer: VLAD SCHNEIDER Drawn by: DAMIAN E. MONTEIRO, PE Checked by:

Design No or LLW No.: | Building ID:

05/09/2023

BARD COLLEGE HS, MANHATTAN WASTE SYSTEM

525 EAST HOUSTON STREET NEW YORK, NY 10002

Drawing Title:

SECTIONS AND DETAILS - 1

DOB NOW Job# M00660122-S2

\$201.00

Sheets in Contract Set: **32** of 42

Sheets in DOB Set: **29** of 37

BARD COLLEGE HIGH SCHOOL-MANHATTAN

525 EAST HOUSTON STREET, NEW YORK, NY 10002

DESIGN NO.: D019998

WASTE SYSTEM LLW NO.: 121691
PARAPETS LLW NO.: 127952
FXTERIOR MASONRY LLW NO.: 127953



NEW YORK CITY SCHOOL CONSTRUCTION AUTHORITY 30-30 THOMSON AVENUE, LONG ISLAND CITY, NEW YORK 11101

A. NINA KUBOTA, PRESIDENT & CEO MARIA A. GOMEZ, P.E., LEED AP BD+C, ACTING VICE PRESIDENT President & CEO
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Peter McCree

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María A. Gómez, P.E. LEED AP BD+C, Acting Vice President
Senior Director In—House Design Studio

Design Consultant Management Studio

Aileen del Prado, P.E. LEED AP BD+C, Senior Director

Consultan

■Bladykas ■Engineering, P.C.

50 Jackson Avenue, Suite 300, Syosset, NY 11791 tel: 516.364.8700 ●fax: 516.364.8707 web: www.bladykas.com ●e-mail: info@bladykas.com

GoshowArchitects

44 West 28th Street, 5 FL / New York, NY 10001 P 212.242.3735 / F 212.242.7460

Ysrael A. Seinuk Structural Consultant 228 East 45th Street / New York, NY 10017 P 212.687.2233 / F 646.487.5555

NOTE: Drawing may be printed at reduced scale


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- 05/09/2023 ISSUED FOR BID

No. Date Revision

Key Plan:

BARUCH PLACE

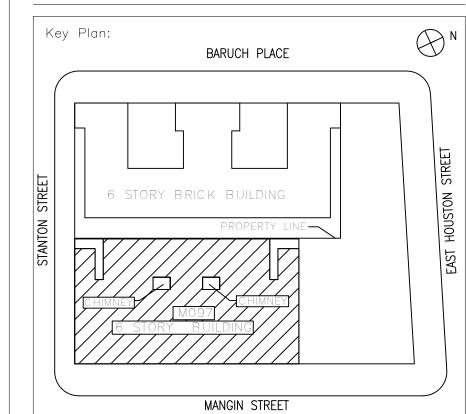

	Block # 325	Lot # 25
	SCA Design Manager:	NASER HAMOUDEH, P.E.
	Project Architect/Engineer:	JEFFREY RABINER, P.E.
•	Discipline Lead:	JOHN HIGGINS, P.E.
	Designer:	DANIEL GIANNOTTA
	Drawn by:	DANIEL GIANNOTTA
	Checked by:	JOHN HIGGINS, P.E.

Project:
BARD COLLEGE HS, MANHATTAN
WASTE SYSTEM

Address:
525 EAST HOUSTON STREET
NEW YORK, NY 10002

Design No or LLW No.: Building ID:

Drawing Title:

COVER SHEET

DOB NOW JOB #M00660122-I1

T001.00

Sheets in Contract Set: 01 of 42

05/09/2023

Sheets in DOB Set: 01 of 37

GENERAL NOTES:

THE FOLLOWING NOTES SHALL APPLY THROUGHOUT. EXCEPTIONS ARE SPECIFICALLY NOTED ON EACH DRAWINGS.

- 1. THE CONTRACTOR SHALL, UNLESS OTHERWISE PROVIDED IN THE CONTRACT DOCUMENTS, SECURE AND PAY FOR THE REQUIRED CONSTRUCTION PERMIT(S), FEES, LICENSES AND INSPECTIONS NECESSARY FOR THE PROPER EXECUTION OF THE WORK. APPLICATION FOR CONSTRUCTION PERMITS SHALL BE PROCESSED THROUGH THE BUILDING CODE COMPLIANCE DIVISION OF THE AUTHORITY.
- 2. COORDINATION OF ALL WORK UNDER THIS CONTRACT SHALL BE MAINTAINED TO ENSURE THE QUALITY AND TIMELY COMPLETION OF THE WORK/PROJECT.
- 3. THE CONTRACTOR SHALL PERFORM ALL CUTTING AND PATCHING REQUIRED TO COMPLETE THE WORK OR TO MAKE ITS PARTS FIT TOGETHER PROPERLY WITHOUT COMPROMISING THE QUALITY OF THE WORK.
- 4. THE CONTRACTOR SHALL BE RESPONSIBLE FOR ADEQUATELY BRACING AND PROTECTING ALL WORK DURING CONSTRUCTION AGAINST DAMAGE, BREAKAGE, COLLAPSE, DISTORTIONS, AND OFF ALIGNMENTS ACCORDING TO CODES AND STANDARDS OF GOOD PRACTICE
- 5. ALL ELEVATIONS SHOWN ARE BASED ON THE NORTH AMERICAN VERTICAL DATUM OF 1988 (NAVD88) AS ESTABLISHED AND MAINTAINED BY NATIONAL GEODETIC SURVEY OF THE NATIONAL OCEAN SERVICE, NATIONAL OCEANIC AND ATMOSPHERIC ADMINISTRATION OR SUCCESSOR AGENCY.
- 6. THE TERM "FINISH FLOOR" SHALL MEAN THE NORMAL FINISHED SURFACE OF THE FLOOR LEVEL. ALL ELEVATIONS GIVEN FOR EXISTING BUILDINGS ARE TO FINISHED FLOOR. THE CONTRACTOR SHALL FIELD VERIFY ALL ELEVATIONS FOR EXISTING STRUCTURES PRIOR TO THE COMMENCEMENT OF WORK.
- 7. THE CONTRACTOR SHALL PATCH AND REPAIR ALL FLOORS, WALLS CEILINGS, ETC. DAMAGED OR EXPOSED DUE TO WORK OR REMOVALS AND FINISH TO MATCH ADJOINING SURFACES.
- 8. THE CONTRACTOR SHALL COORDINATE OPENINGS IN THE EXTERIOR WALLS FOR THE INSTALLATION OF CONDUITS AND BOXES FOR ELECTRICAL EQUIPMENT.
- 9. WHERE MANUFACTURES' NAMES AND PRODUCT NUMBERS ARE INDICATED ON THE DRAWINGS, IT SHALL BE CONSTRUED TO MEAN THE ESTABLISHING OF QUALITY AND PERFORMANCE STANDARDS OF SUCH ITEMS. ALL OTHER PRODUCTS MUST BE SUBMITTED TO THE ENGINEER FOR APPROVAL BEFORE THEY SHALL BE DEEMED EQUAL.
- 10. FIRESTOPPING SHALL BE INSTALLED AT ALL PENETRATIONS OF FIRE—RATED CONSTRUCTION AS PER SPECIFICATIONS. FIRESTOPPING MATERIALS ARE TO BE APPROPRIATE FOR, AND BE PART OF A LISTED AND LABELED ASSEMBLY IN ACCORDANCE WITH THE BUILDING CODE OR HAVE OTCR OR MEA APPROVAL.
- 11. DIMENSIONS ON PLANS ARE INDICATED FROM SURFACE TO SURFACE BETWEEN WALLS, PARTITIONS AND OTHER ITEMS EXCLUSIVE OF FINISHES.
- 12. SIZE OF MASONRY UNITS AND WOOD MEMBERS ON PLANS, BUILDING ELEVATIONS AND SECTIONS ARE SHOWN AS NOMINAL SIZE.
- 13. DRAWINGS ARE NOT TO BE SCALED. USE DIMENSIONS ONLY. ALL DIMENSIONS AND CONDITIONS SHOWN AND ASSUMED ON THE DRAWINGS MUST BE VERIFIED AT THE SITE BY THE CONTRACTOR BEFORE ORDERING ANY MATERIAL OR DOING ANY WORK. ANY DISCREPANCIES IN THE DRAWINGS AND SPECIFICATIONS SHALL BE REPORTED TO THE AUTHORITY. NO CHANGE IN DRAWINGS OR SPECIFICATIONS IS PERMISSIBLE WITHOUT WRITTEN CONSENT OF THE ARCHITECT/ENGINEER. NO WORK SHALL PROCEED UNTIL SUCH DISCREPANCY HAS BEEN RECTIFIED.
- 14. ALL WORK ON THESE DRAWINGS SHALL BE CONSIDERED NEW WORK WHETHER STATED OR NOT EXCEPT WHERE SPECIFICALLY NOTED AS "EXISTING TO REMAIN".
- 15. THE CONTRACTOR SHALL PATCH AND REPAIR ALL DAMAGED OR EXPOSED SURFACES DUE TO CONTRACT WORK. ALL NEWLY INSTALLED, PATCHED WORK AND ALL AFFECTED AREAS SHALL BE PAINTED. ALL PAINTING WORK SHALL BE PERFORMED TO COVER THE ENTIRE HORIZONTAL OR VERTICAL SURFACE TO THE CLOSEST CORNER IN ALL FOUR DIRECTIONS. COLOR TO MATCH EXISTING.

3. SEE SPECIFICATION SECTION S01535 FOR DETAILS

STONE, TERRA-COTTA AND BRICKS TO THE EXISTING.

2. USE NON-POWER HAND TOOLS TO CUT MORTAR FOR POINTING.

SITE SAFETY AND PROTECTION NOTES:

REFLECTING THE ENTIRE SITE AND SHALL SHOW ANY PHASED PROTECTION.

4. NO WORK IS TO PROCEED UNTIL SITE SAFETY PLANS ARE APPROVED BY SCA.

STATE HISTORIC PRESERVATION OFFICE:

OCCUPANTS AND GENERAL PUBLIC AND EXPOSURE TO THE CONSTRUCTION PROCESS.

THIS BUILDING IS DESIGNATED ON THE NATIONAL REGISTER OF HISTORIC PLACES AS DETERMINED

BY THE STATE HISTORIC PRESERVATION OFFICE (SHPO) ALL WORK PERFORMED ON THIS PROJECT

ELEVATIONS AND THE CONTRACTOR SHALL MATCH COLOR, SIZE, SHAPE AND TEXTURE OF THE

1. SUBMIT TO THE SCA FOR REVIEW A SITE SAFETY PLAN(S) PREPARED AND SIGNED BY A NEW YORK CITY LICENSED SITE

SAFETY MANAGER. THE PLAN(S) SHALL BE COMPLETE, REFLECTING THE ENTIRE SITE AND SHALL BE COMPLETE,

2. THE SITE SAFETY PLAN(S) SHALL INCLUDE, BUT SHALL NOT BE LIMITED TO, NOTES, SIDEWALKS BRIDGES, EGRESS,

SCAFFOLDING, FIRE PROTECTION ETC. THEY SHOULD ADDRESS ANY POTENTIAL INTERACTION BETWEEN THE BUILDING

- 16. THE CONTRACTOR SHALL FURNISH AND INSTALL NEW MATERIALS AT NO ADDITIONAL COST TO THE AUTHORITY FOR THE FOLLOWING CONDITIONS:
- A) ANY EXISTING WORK THAT HAS BEEN REMOVED OR DAMAGED IN ORDER TO PERFORM THE CONTRACT WORK.


 B) TO FURNISH THE WORK OF THIS CONTRACT IN WORKMANLIKE MANNER.
- 17. THE CONTRACTOR SHALL BE RESPONSIBLE FOR ADEQUATELY BRACING AND PROTECTING ALL WORK DURING CONSTRUCTION AGAINST DAMAGE, BREAKAGE, COLLAPSE, DISTORTIONS AND OFF ALIGNMENTS ACCORDING TO CODES AND STANDARDS OF GOOD
- 18. THE CONTRACTOR SHALL INCLUDE ALL PREPARATORY AND ASSOCIATED SUPPLEMENTARY WORK TO PROVIDE A COMPLETE AND FINISHED INSTALLATION.
- 19. PROVIDE GUARDS, RAILS, BARRICADES, FENCES, SIDEWALK SHEDS, CATCH PLATFORMS, DECKING, NIGHT LIGHTING, ETC., AS REQUIRED BY THE 2014 NEW YORK CITY BUILDING CODE, SECTION 3307.3 AND AS REQUIRED TO PROVIDE ADEQUATE PROTECTION. ALSO, COMPLY WITH SECTION S01900 OF THE SPECIFICATION.
- 20. THE CONTRACTOR SHALL KEEP WORK SITE FREE FROM DEBRIS AND ACCUMULATED REFUSE, AND SHALL HAVE SOLE RESPONSIBILITY FOR PROTECTING ALL DANGEROUS AREAS FROM ENTRY BY UNAUTHORIZED PARTIES. SITE SHALL BE LEFT BROOM CLEAN AT THE END OF EACH WORKING DAY.
- 21. THE CONTRACTOR SHALL MAINTAIN FREE AND UNOBSTRUCTED ACCESS FROM ALL ADJACENT SPACES INTO THE EXISTING FIRE STAIRS TO OUTSIDE OF THE BUILDING AT ALL TIMES.
- 22. THE DRAWINGS INDICATE THE GENERAL ARRANGEMENT AND LOCATION OF PIPING, FIXTURES, OUTLETS, ETC. MAKE NECESSARY MODIFICATIONS IN THE LAYOUT WORK THAT MAY BE REQUIRED TO SUIT ACTUAL FIELD CONDITIONS. THE ARCHITECT SHALL BE NOTIFIED PRIOR TO MAKING ANY SUCH MODIFICATIONS. INSTALL ALL EQUIPMENT AND PIPING TO MAINTAIN THE VISUAL AESTHETICS OF THE BUILDING IN A NEAT AND WORKMANLIKE MANNER.
- 23. CONTRACTOR IS ENCOURAGED TO VISIT SITE AND FAMILIARIZE HIMSELF WITH EXISTING CONDITIONS AND CONSTRUCTION DOCUMENTS PRIOR TO SUBMITTING BID.
- 24. CONDUITS AND PIPES SHALL BE INSTALLED TO ALLOW CLEARANCE AND ACCESS NECESSARY FOR ADJACENT OUTLETS AND EQUIPMENT.
- 25. IN THE BOILER ROOM, SYSTEM CONDUITS, SHALL NOT BE RUN OVER BOILERS.
- 26. PULL AND JUNCTION BOXES SHALL BE SURFACE TYPE, UNLESS OTHERWISE NOTED. THE JUNCTION AND PULL BOXES SHALL BE LOCATED APPROXIMATELY WHERE INDICATED ON THE PLAN TO SUIT CONDUIT ENTRANCE, BUT SHALL, IN ALL CASES, BE LOCATED TO AVOID INTERFERENCE WITH ALL OTHER EQUIPMENT AND SHALL BE LOCATED SO THAT COVERS ARE READILY ACCESSIBLE.
- 27. SPECIAL INSPECTIONS SHALL BE CARRIED OUT IN ACCORDANCE WITH APPLICABLE BUILDING CODE SECTIONS.
- 28. IN UNFINISHED PORTIONS OF THE BUILDING, SUCH AS BOILER ROOM, FAN ROOMS, PIPE SPACES, ETC., LOCATIONS OF CONDUIT AND OUTLETS ARE APPROXIMATE AND SHALL CLEAR PIPING AND ALL OTHER CONSTRUCTION. CONDUITS IN THESE PORTIONS OF THE BUILDING SHALL BE RUN EXPOSED BUT MAY BE RUN CONCEALED WITH THE UNDERSTANDING THAT ALL OUTLETS MUST BE EXTENDED AS DIRECTED TO CLEAR ANY INTERFERENCE WITH FIXTURES.
- 29. ALL WORK INSTALLED IN CORRIDORS AND STAIRWAYS SHALL NOT AFFECT THE EGRESS OF SAME.
- 30. ADDITIONAL NOTES THAT ARE APPLICABLE TO THIS PROJECT MAY BE FOUND THROUGHOUT THE CONTRACT DRAWINGS.

SUMMARY OF WORK

THE WORK AT BARD COLLEGE HIGH SCHOOL M097 SHALL BE AS INDICATED AND CALLED FOR IN THE CONTRACT DOCUMENTS AND SHALL INCLUDE, BUT NOT BE LIMITED TO, THE FOLLOWING GENERAL ITEMS OF WORK:


- 1. REMOVE AND ABATE ALL ASBESTOS AND HAZARDOUS MATERIALS AS IDENTIFIED BY IEH.
- 2. REMOVE PORTIONS OF THE CAFETERIA FLOOR TO EXPOSE UNDERFLOOR SANITARY PIPING. REPAIR THE FLOOR AFTER THE PLUMBING WORK IS COMPLETE.
- 3. MODIFY THE EXISTING SANITARY AND VENT PIPING TO ABANDON A SECTION OF BACK-PITCHED PIPE. PROVIDE NEW SEWAGE EJECTOR PIT AND EJECTOR PUMP.
- 4. PROVIDE FALL PROTECTION FENCING OVER EXISTING OPENINGS AT THE ROOFTOP PARAPET WALL.
- 5. PROVIDE STEEL STAIRS AND CROSSOVER AT THE ROOF OVER EXISTING GAS PIPES AND ELECTRICAL CONDUITS. SECURE THE CROSSOVER TO THE ROOF STRUCTURE AND FLASH INTO THE ROOF WATERPROOF MEMBRANE.
- 6. REPLACE BRICKWORK AT TWO SETS OF AUDITORIUM EGRESS STAIRS, REPLACE COPING STONE AT TOP OF PROPERTY LINE WALL AND REPLACE WROUGHT IRON FENCE AT TOP OF PROPERTY LINE WALL. PROVIDE WATERPROOF MEMBRANE TIED TO STAIRS AND WALLS TO PREVENT WATER INFILTRATION INTO THE CELLAR STORAGE ROOMS.
- 7. AT THE NORTH STAIR BULKHEAD, REPOINT EXTERIOR BRICK AND REPLACE SLATE LEDGE. AT THE INTERIOR SIDE OF THE NORTH STAIR BULKHEAD ABOVE THE 5TH FLOOR, REPLACE PLASTER AND PAINT TO REPAIR WATER DAMAGE.
- 8. AT THE FRONT BALCONY NEAR THE CUSTODIAN'S OFFICE, PROVIDE WATER PROOF MEMBRANE, REPOINT BRICKS AND MODIFY THE DRAIN PIPE. INSIDE THE CUSTODIAN'S OFFICE, REPAIR DAMAGED PLASTER AND PAINT THE ENTIRE ROOM.
- 9. ABANDON SECTION OF BACK-PITCHED SANITARY PIPE. PROVIDE SEWAGE EJECTOR PUMP, SANITARY AND STORM PIPING TO ELEVATE PIPING ABOVE THE DFE AND TO SEPARATE SANITARY AND STORM SYSTEMS.

SITE PLAN (N.T.S.):

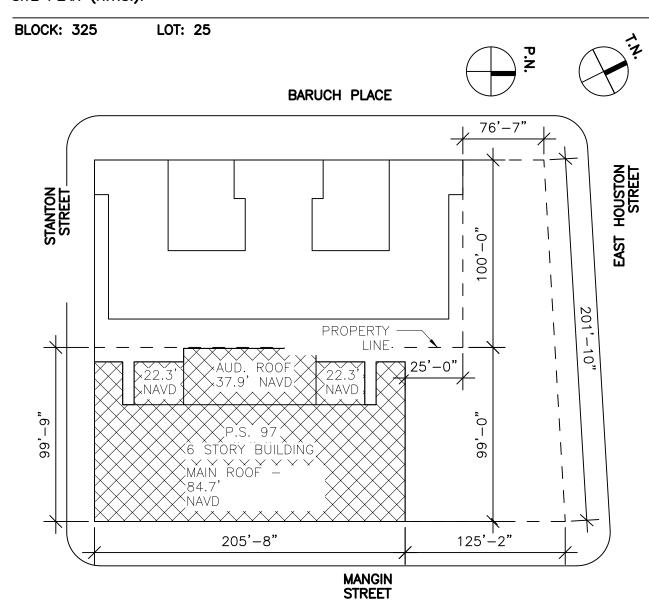

LOCATION PLAN (N.T.S.):

BLOCK: 325 LOT: 25 T.N.

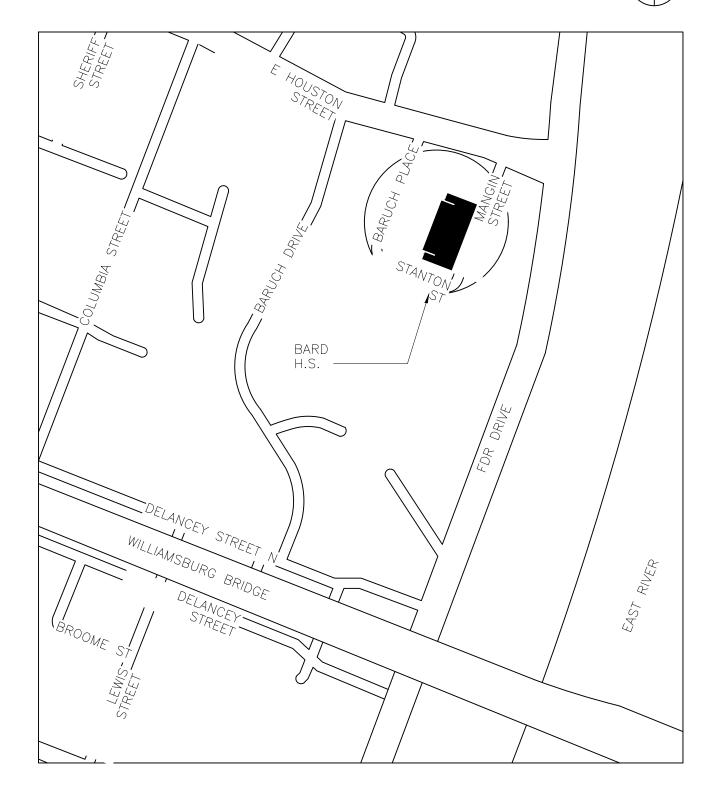

LIST OF DRAWINGS:

DRAWING NO	DRAWING TITLE	CONTRACT SET SHEET NO.	DOB SET SHEET NO.
	OB NO. M00660122-I1		
T001.00	COVER SHEET	1	1
T002.00	DRAWING LIST, LOCATION MAPS, GENERAL NOTES AND SUMMARY OF WORK	2	2
T003.00	BUILDING DEPARTMENT NOTES, FEMA FIRM ELEVATIONS AND FIRM MAPS	3	3
T004.00	ZONE OF PUBLIC PROTECTION PLAN	4	4
NO DOB NO	U JOB NO.	<u> </u>	
H101.00	ASBESTOS NOTES AND LEGEND	5	_
H102.00	FIRST FLOOR ASBESTOS REMOVAL PLAN	6	_
H103.00	GROUND FLOOR PART PLAN ASBESTOS REMOVAL PLAN	7	_
OOB NOW J	OB NO. M00660122-S1	<u> </u>	
A001.00	GENERAL NOTES - ARCHITECTURAL	8	5
A002.00	2ND FLOOR EGRESS PLAN & ROOF ACCESS PLAN	9	6
A061.00	SELECTIVE REMOVALS PLAN - 1ST FLOOR	10	7
A062.00	SELECTIVE REMOVALS PLAN — 2ND FLOOR	11	8
A063.00	SELECTIVE REMOVALS PLAN - 3RD FLOOR	12	9
A064.00	SELECTIVE REMOVALS PLAN - ROOF	13	10
A081.00	NORTH REAR EGRESS STAIR SELECTIVE DEMOLITION	14	11
A082.00	SOUTH REAR EGRESS STAIR SELECTIVE DEMOLITION	15	12
A083.00	MAIN ENTRANCE BALCONY SELECTIVE DEMOLITION	16	13
	1ST FLOOR CAFETERIA SLAB SELECTIVE DEMOLITION	17	14
A085.00	NORTH BULKHEAD SELECTIVE DEMOLITION	18	15
A101.00	CONSTRUCTION PLAN - 1ST FLOOR	19	16
A102.00	CONSTRUCTION PLAN - 2ND FLOOR	20	17
A102.00	CONSTRUCTION PLAN - 3RD FLOOR	21	17
A104.00	CONSTRUCTION PLAN - ROOF	22	19
A401.00	NORTH REAR EGRESS STAIR REPAIR WORK	23	20
A402.00	SOUTH REAR EGRESS STAIR REPAIR WORK	24	21
A403.00	MAIN ENTRANCE BALCONY REPAIR WORK	25	22
A404.00	1ST FLOOR CAFETERIA SLAB REPLACEMENT	26	23
A405.00	NORTH BULKHEAD MASONRY REPAIR	27	24
A406.00	ROOF PARAPET BARRIER FENCE	28	25
	ACCESS STAIR AT ROOFTOP AND DETAILS	29	26
	MASONRY DETAILS	30	27
	OB NO. M00660122-S2		
	ROOF PLAN	31	28
	SECTIONS AND DETAILS-1	32	29
	OB NO. M00660122-I1	1 1	
	KEY OF SYMBOLS, ABBREVIATIONS AND GENERAL NOTES	33	30
	PLUMBING SCHEDULE	34	31
	FIRST FLOOR PLUMBING REMOVALS PLAN WEST	35	32
	FIRST FLOOR PLUMBING REMOVALS PLAN EAST AND SECTIONS	36	33
P201.00	FIRST FLOOR PLUMBING NEW WORK PLAN WEST, PART PLAN AND SECTION	37	34
P202.00	FIRST FLOOR PLUMBING NEW WORK PART PLAN EAST AND SECTIONS	38	35
P301.00	SANITARY AND STORM DRAINAGE RISER DIAGRAMS	39	36
	PLUMBING DETAILS	40	37
	W JOB NO.	, , , , , , , , , , , , , , , , , , , 	
E001.00	FIRST FLOOR ELECTRICAL NOTES AND SYMBOL LIST	41	
E201.00	FIRST FLOOR ELECTRICAL NEW WORK PLAN, KEY PLAN, AND DETAIL	42	_

NYCECC COMPLIANCE

THE PLANS IN THIS APPLICATION OUTLINE THE ALTERATION OF AN EXISTING BUILDING THAT HAS BEEN LISTED IN THE NEW YORK STATE REGISTER OF HISTORIC PLACES AND THEY ARE EXEMPT FROM MANDATORY COMPLIANCE WITH THE 2020 ENERGY CONSERVATION CODE OF NYS PER SECTION C501.6.

CONCRETE NOTES (TR2 & TR3):

THE CONCRETE TO BE INSTALLED FOR THIS PROJECT INCLUDES EQUIPMENT PADS FOR MECHANICAL EQUIPMENT AND IS NOT SUPPORTING THE BUILDING STRUCTURE. THE QUANTITY TO BE PLACED IS LESS THAN 50 CUBIC YARDS AND THE CONCRETE WILL BE NON-STRUCTURAL SLAB SUPPORTED DIRECTLY ON THE BOILER ROOM FLOOR. THE CONCRETE TESTING AND SPECIAL INSPECTION INDICATED IN BC 1704.4 SHALL BE WAIVED IN ACCORDANCE WITH BC 1704.4 EXCEPTION 2.1. FORMS TR-2 AND TR-3 ARE NOT REQUIRED FOR THIS APPLICATION.

NOTE CONCERNING SPECIAL AND PROGRESS INSPECTIONS 1. THE CONTRACTOR SHALL COORDINATE WITH THE OWNER FOR RETAINING THE REQUIRED NEW YORK STATE LICENSED AND NEW YORK CITY APPROVED AND CERTIFIED SPECIAL

- INSPECTION AGENCIES AND CERTIFIED SPECIAL INSPECTION AGENCY PERSONNEL AND REPRESENTATIVES TO PERFORM REQUIRED SPECIAL INSPECTIONS PER CODE.

 2. THE SPECIAL INSPECTION AGENTS ARE TO PROVIDE THE COORDINATION OF NEW YORK CITY BUILDING DEPARTMENT PAPERWORK FOR THE "IDENTIFICATION OF RESPONSIBILITIES" AND THE "CERTIFICATION OF COMPLETED INSPECTIONS AND TESTS" PER THE TR-1 TECHNICAL
- BUILDING DEPARTMENT PAPERWORK FOR THE "IDENTIFICATION OF RESPONSIBILITIES" AND THE "CERTIFICATION OF COMPLETED INSPECTIONS AND TESTS" PER THE TR-1 TECHNICAL REPORT STATEMENT OF RESPONSIBILITY FORM AND PER THE TR-8 TECHNICAL REPORT STATEMENT OF RESPONSIBILITY FOR ENERGY CODE PROGRESS INSPECTIONS FORM.
- CONTACT THE DESIGN ARCHITECT/ENGINEER OF RECORD FOR ASSISTANCE IF REQUIRED.
 THE CONTRACTOR IS TO COORDINATE AND INCLUDE ANY ADDITIONAL SPECIAL PROGRESS
- 4. THE CONTRACTOR IS TO COORDINATE AND INCLUDE ANY ADDITIONAL SPECIAL, PROGRESS OR ENERGY CODE COMPLIANCE INSPECTION REQUIREMENTS AS MAY BE REQUIRED BY THE NEW YORK CITY BUILDING DEPARTMENT.

Board of Trustees
Chancellor David C. Banks, Chairman

Design Consultant Management Studio

President & CEO
A. Nina Kubota

Lorraine Grillo

Peter McCree

SCA
Sca

Architecture & Engineering
María A. Gómez, P.E. LEED AP BD+C, Acting Vice President
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Consultants:

■Bladykas ■Engineering, P.C.

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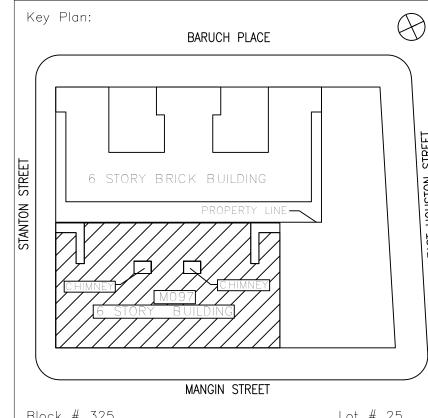
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Structural Consultant
228 East 45th Street / New York, NY 10017
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SCA Design Manager:

NASER HAMOUDEH, P.E.

Project Architect/Engineer:

JEFFREY RABINER, P.E.

Discipline Lead:

Designer:

DANIEL GIANNOTTA

Drawn by:

DANIEL GIANNOTTA

Checked by:

Design No or LLW No.:

Building ID:

Date:

Project:
BARD COLLEGE HS, MANHATTAN
WASTE SYSTEM

Address: 525 EAST HOUSTON STREET NEW YORK, NY 10002

DRAWING LIST, LOCATION MAPS, GENERAL NOTES AND SUMMARY OF WORK

DOB NOW JOB #M00660122-I1

T002.00

Sheets in Contract Set: 02 of 42

05/09/2023

Sheets in DOB Set: 02 of 37

3. ALL WORK SHALL PRESERVE THE APPEARANCE OF THE INTERIOR AND EXTERIOR OF THE BUILDING.

MUST COMPLY WITH SHPO REQUIREMENTS. REFER TO SPECIFICATION FOR DETAILS.

1. THERE ARE MULTIPLE TYPES OF STONE, TERRA-COTTA, AND BRICK MASONRY ON THE

SUBSTANTIAL IMPROVEMENT CALCULATIONS AND MARKET VALUE

			SIGNED
JOB NO_DOC NO	SIGNED OFF DATE	ESTIMATED COST	OFF
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103648992 1	4/17/2020		
103648965 1	1/17/2020		
103648929 1	4/15/2020	\$ -	
103648493 1	1,13,2020	\$ 18,000	
103648055_4	<u> </u>	\$ 554,600	
103648055 3	<u> </u>	\$ 561,000	
103648055 2		\$ 345,000	
103648055_1		\$ 2,732,000	
103646878_3		\$ 2,732,000	
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	2/4/2016		Х
103646878_1	2/4/2016		^
103646011_3	-	\$ -	
103646011_2	2/2/227	\$ -	
103646011_1	2/8/2017	\$ 30,000	
103645370_4		\$ -	
103645370_3		\$ -	
103645370_2	5/16/2016		Х
103645370_1	5/16/2016		Х
103644549_4		\$ -	
103644549_3		\$ -	
103644549_2		\$ -	
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102388284_7		\$ -	
102388284_6		\$ -	
102388284_5		\$ -	
102388284_4		\$ -	
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102388284_1	8/30/2017	\$ 2,000,000	
	10/14/2010		Х
	10/14/2010		Х
	12/11/2013		Х
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102395891_1	12/3/2008		X
102374440 1	12/3/2008		X
102381370 1	3/4/2008		X
102369198_1	2/5/2009		X
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102311222_2	12/8/2006		X
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102277037_2		\$ -	
102277046_3		\$ -	
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102275146_3		\$ -	
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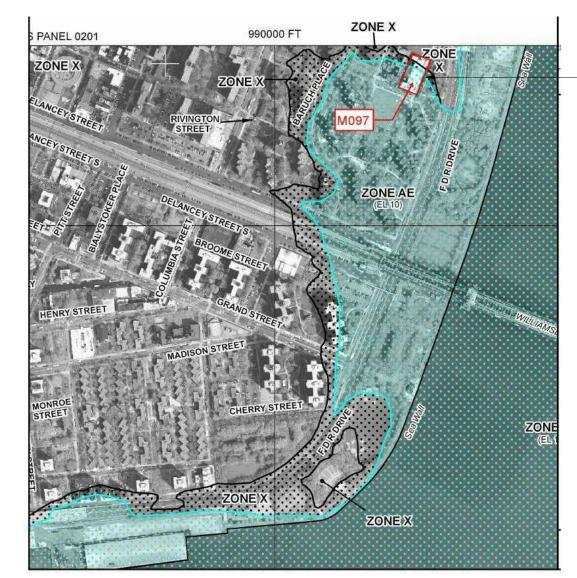
,	
TOTAL EST. COST (APPS SINCE 2/2004)	\$ 9,828,536
SIGNED OFF APPLICATIONS	\$ (2,707,436)
EST. COSTS SINCE 2/2004 -SIGNED OFF	
APPLICATIONS	\$ 7,121,100
ESTIMATED COST OF THIS APPLICATION	\$ 401,633
TOTAL ALL EST. COSTS SINCE 2/2004 &	
CURRENT PROPOSED PROJECT - SIGNED OFF	
APPLICATIONS	\$ 7,522,733
BUILDING APPRAISAL AS OF 8/2015	\$ 27,500,000
(EST. COSTS/BUILDING VALUE) x 100 =	27%

FLOOD MITIGATION ANALYSIS PER NYC BC: APPENDIX G


M097 BUILDING ELEVATIONS						
FLOOR/SPACE	1957 SURVEY (MANHATTAN BORO DATUM)	NGVD29	NAVD88			
BOILER ROOM	3.00'	5.75'	4.65'			
1ST FLOOR	5.00'	7.75'	6.65'			
·						

NOTE: MANHATTAN BORO DATUM IS 1.60' ABOVE NORTH AMERICAN VERTICAL DATUM OF 1988 (NAVD88)

FEMA FIRM ELEVATIONS				
FLOOR/SPACE	NGVD29	NAVD88		
2007 FIRM BFE (ZONE AE10)	10.00'	8.90'		
2007 FIRM DFE: (BFE + 1')	11.00'	9.90'		
2013 PRE—FIRM BFE (ZONE AE11) 2013 PRE—FIRM DFE: (BFE + 1')		11.00' 12.00'		
PROJECT DFE = MAX OF ABOVE	_	12.00		



ZONE AE10 FLOOD LEVEL - 10.0' NGVD (8.9' NAVD)

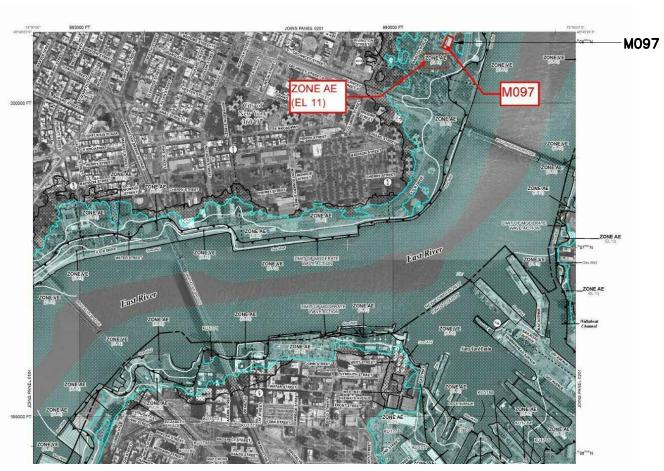

FEMA PRE-FIRM 2013 (BUILDING IN ZONE AE11

SPECIAL INSPECTIONS

SPECIAL INSPECTIONS REQUIRED IN ACCORDANCE WITH CHAPTER 17 AND THE APPLICABLE SECTIONS OF THE NYC CONSTRUCTION CODE ARE LISTED IN THE FOLLOWING TABLES: THE CONTRACTOR MUST NOTIFY THE ARCHITECT OR ENGINEER FOR SPECIAL INSPECTIONS AT LEAST 72 HOURS BEFORE THE SPECIFIC WORK COMMENCES.

THE "SPECIAL INSPECTION AGENCY", HIRED BY THE "AUTHORITY", SHALL BE RESPONSIBLE FOR THE FOLLOWING INSPECTIONS:

M00660122-I1

THE "AUTHORITY" SHALL BE RESPONSIBLE FOR THE FOLLOWING SPECIAL INSPECTIONS: FIRE-RESISTANT PENETRATIONS AND JOINTS 1704.27

M00660122-S1

THE "AUTHORITY" SHALL BE RESPONSIBLE FOR THE FOLLOWING SPECIAL INSPECTIONS: POST-INSTALLED ANCHORS (BB#2014-018, 2014-019) 1704.32 **MASONRY** 1704.5 FLOOD ZONE COMPLIANCE 1704.29, G105

M00660122-S2

THE "AUTHORITY" SHALL BE RESPONSIBLE FOR THE FOLLOWING SPECIAL INSPECTIONS: STRUCTURAL STEEL - WELDING 1704.3.1 STRUCTURAL STEEL - DETAILS 1704.3.2 STRUCTURAL STEEL - HIGH STRENGTH BOLTING 1704.3.3

BUILDING DEPARTMENT NOTES:

WORK SHALL BE EXECUTED IN FULL COMPLIANCE WITH APPLICABLE PROVISIONS OF ALL LAWS, BY-LAWS, STATUTES, ORDINANCES, CODES, RULES, REGULATIONS AND LAWFUL ORDERS OF PUBLIC AUTHORITIES BEARING ON THE PERFORMANCE AND EXECUTION OF THE WORK. THE CONTRACTOR SHALL PROMPTLY NOTIFY THE AUTHORITY OF ANY PORTIONS OF THE WORK IN THE CONTRACT DOCUMENTS THAT ARE AT VARIANCE WITH ABOVE.

THE REVIEW FOR THIS APPLICATION WILL BE UNDER THE 1968 NYC BUILDING CODE.

AVAILABLE RECORDS INDICATE THIS BUILDING WAS CONSTRUCTED APPROXIMATELY IN 1923.

THIS APPLICATION IS FILED UNDER 2014 CODE FOR COMPLIANCE WITH CHAPTERS 1, 17, 32 & 33 REGARDING ADMINISTRATION, INSPECTION AND SAFETY REQUIREMENTS.

2. ALL MATERIALS, ASSEMBLIES, FORMS OF CONSTRUCTION AND SERVICE EQUIPMENT REGULATED BY CODE SHALL MEET ONE OF THE FOLLOWING REQUIREMENTS:

> A). THEY SHALL HAVE BEEN ACCEPTABLE PRIOR TO THE EFFECTIVE DATE OF THE CODE BY THE BOARD OF STANDARDS AND APPEALS OR

THEY SHALL HAVE BEEN ACCEPTED FOR THE USE UNDER THE PRESCRIBED TEST METHODS BY THE COMMISSIONER

C). APPROVED BY THE OFFICE OF TECHNICAL CERTIFICATION AND RESEARCH (OTCR)

> SHALL BE LISTED AND LABELED BY DOB RECOGNIZED AGENCY TO MEET REQUIRED STANDARD.

3. THE CONTRACTOR'S LICENSED PROFESSIONAL IS RESPONSIBLE FOR FILING APPLICATION AND OBTAINING PERMITS FOR SCAFFOLDING, SIDEWALK BRIDGING, ANY OTHER CONSTRUCTION EQUIPMENT OR PUBLIC PROTECTIVES REQUIRED TO ENSURE SAFETY OF OPERATION AND THE PUBLIC AS PER THE 2014 NYC CONSTRUCTION CODE, CHAPTER 33, SECTION BC 3307. THE CONTRACTOR IS ALSO RESPONSIBLE FOR OBTAINING LETTER OF COMPLETION. APPLICATION FOR CONSTRUCTION PERMITS SHALL BE PROCESSED THROUGH THE BUILDING CODE COMPLIANCE (BCC) DIVISION OF THE AUTHORITY.

MASONRY WALLS AND CONSTRUCTION SHALL CONFORM TO RS 10-2 OF THE 1968 BUILDING CODE OR \$28-101.4.3 EXCEPTION 16.

5. THESE DRAWINGS HAVE BEEN PREPARED BY OR AT THE DIRECTION OF THE UNDERSIGNED AND TO THE BEST OF THE UNDERSIGNED'S KNOWLEDGE, BELIEF AND PROFESSIONAL JUDGEMENT ARE IN COMPLIANCE WITH THE 2014 NYC CONSTRUCTION CODES.

6. ALL WORK SHALL COMPLY WITH SECTION BC 1007 AND CHAPTER 11 "ACCESSIBILITY" OF THE 2014 NYC BUILDING CODE AND ICC A117.1-2009.

ALL NEW INTERIOR FINISHES SHALL BE CONSTRUCTED OF MATERIALS MEETING CHAPTER 8 FOR FLAME SPREAD AND SMOKE DEVELOPMENT RATINGS OF THE 2014 NYC BUILDING

8. PER 2014 NYC BUILDING CODE SECTION 3304.4.4 THIS BUILDING IS NOT WITHIN 200'-0" FROM ANY MTA. NYCTA OR PA SUBWAY OR TUNNEL STRUCTURES. LETTER OF NO OBJECTION IS NOT NEEDED.

9. SITE SAFETY PLANS SHALL BE SUBMITTED BY THE CONTRACTOR AND APPROVED BY THE AUTHORITY PRIOR TO APPLYING FOR CONSTRUCTION PERMITS.

10. FOLLOW CHAPTER 33 OF THE 2014 NYC BUILDING CODE FOR PROTECTION OF THE PUBLIC AND ADJACENT PROPERTIES.

11. PROGRESS INSPECTIONS REQUIRED TO BE PERFORMED DURING CONSTRUCTION FOR ANY NEW BUILDING, ADDITION OR ALTERATION PROJECT ARE IDENTIFIED BY THE APPLICANT ACCORDING TO THE SCOPE OF WORK AND LISTED AND DESCRIBED IN THE DRAWINGS. IN ACCORDANCE WITH THE 2014 NYC BUILDING CODE SECTION 109.9, WHERE AN INSPECTION OR TEST FAILS, THE CONSTRUCTION SHALL BE CORRECTED.

12. IN ACCORDANCE WITH ARTICLE 116 OF TITLE 28 AND SECTION BC 109 OF THE 2014 NYC BUILDING CODE. CONSTRUCTION SHALL BE SCHEDULED TO ALLOW REQUIRED PROGRESS INSPECTIONS TO TAKE PLACE, AND THAT ROOFS, CEILINGS, EXTERIOR WALLS, INTERIOR WALLS, FLOORS, FOUNDATIONS, BASEMENTS AND ANY OTHER CONSTRUCTION SHALL NOT BE COVERED OR ENCLOSED UNTIL REQUIRED PROGRESS INSPECTIONS ARE COMPLETED OR THE PROGRESS INSPECTOR INDICATES THAT SUCH COVERING OR ENCLOSURE MAY PROCEED AT EACH STAGE OF CONSTRUCTION, AS APPLICABLE.

13. FIRESTOPPING SHALL BE INSPECTED IN ACCORDANCE WITH ASTM E2174 BY THE SPECIAL INSPECTOR.

14. THIS BUILDING IS IN A FLOOD ZONE AE-11. (NAVD 88)

15. THERE ARE NO VIOLATIONS BEING ADDRESSED UNDER THIS APPLICATION.

16. THERE WILL BE NO CHANGE IN THE USE, EGRESS OR OCCUPANCY BECAUSE OF THE WORK OF THIS APPLICATION.

17. PER THE 2014 NYC BUILDING CODE SECTION 28-113.4.4 ALL MATERIALS OR EQUIPMENT DELIVERED TO JOB SITE SHALL BE LABELED OR SHIPPED WITH MANUFACTURER'S CERTIFICATE, OR M.E.A. OR B.S.A. LABELS. 24. INSULATION SHALL BE LABELED AND SHALL BE EQUAL TO OR GREATER THAN THE R-VALUES AND AN ASSEMBLY U-VALUES IN THE ENERGY ANALYSIS.

18. THE FOLLOWING SHALL BE MADE UNDER SEPARATE APPLICATION BY THE CONTRACTOR'S LICENSED PROFESSIONAL IN ACCORDANCE WITH SECTION 28-104.2.6 OF TITLE 28:

THE ITEMS LISTED IN NOTES ABOVE TO BE FILED UNDER SEPARATE APPLICATION i.e. DEFERRED TO BE FILED, SHALL NOT BE CONSTRUCTED PRIOR TO **OBTAINING SUCH PERMIT.**

19. THE FOLLOWING SHALL BE MADE UNDER SEPARATE APPLICATION BY THE CONTRACTOR TO THE ELECTRICAL ENFORCEMENT UNIT.

> ELECTRICAL WORK PRIOR TO START OF ELECTRICAL WORK

20. ALL NEW WORK SHALL COMPLY WITH THE 2020 NEW YORK CITY ENERGY CONSERVATION CODE.

21. ALL NEW INTERIOR FINISHES SHALL BE CONSTRUCTED OF MATERIALS MEETING SECTION 27-529 OF THE 1968 BUILDING CODE FOR FLAME SPREAD RATINGS.

SITE SAFETY PLANS SHALL BE SUBMITTED BY THE CONTRACTOR AND APPROVED BY THE AUTHORITY PRIOR TO APPLYING FOR CONSTRUCTION PERMITS.

23. HEIGHTS OF PARAPETS/RAIL GUARDS IS TO BE 3'-6" MINIMUM ABOVE ADJACENT ROOF LEVEL IN ACCORDANCE WITH SECTION 27-334 OF THE 1968 BUILDING CODE.

24. HANDRAILS AND GUARDS SHALL BE DESIGNED TO RESIST THE LOADS AND TRANSFER SUCH LOADS TO THE STRUCTURE IN ACCORDANCE WITH SECTION 27-558 (b)(1) OF THE 1968 BUILDING CODE.

25. IN COMPLIANCE WITH APPENDIX G G102(10) G301.1 G304.1(5): WORK PROPOSED THAT IS NOT A SUBSTANTIAL IMPROVEMENT SHALL ALSO NOT INCREASE THE DEGREE OF NONCOMPLIANCE INCLUDING THE INSTALLATION OF NEW SPACES, COMPONENTS, MATERIALS, FINISHES, AND EQUIPMENT.

26. WORK PROPOSED IN THIS APPLICATION IS NOT INCLUDED AS A SUBSTANTIAL IMPROVEMENT AS DEFINED BY SECTION BC G201.2 AND 1RCNY

27. THIS BUILDING HAS BEEN SPECIFICALLY DESIGNATED AS HISTORICALLY SIGNIFICANT BY THE ADOPTING AUTHORITY AND IS LISTED WITH THE NY STATE HISTORIC PRESERVATION OFFICE (SHPO) AND THEREFORE NEED NOT COMPLY WITH THE REQUIREMENTS OF ASHRAE 90.1-4.2.1.3.

Architecture & Engineering María A. Gómez, P.E. LEED AP BD+C, Acting Vice President Senior Director In-House Design Studio

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Aileen del Prado, P.E. LEED AP BD+C, Senior Director

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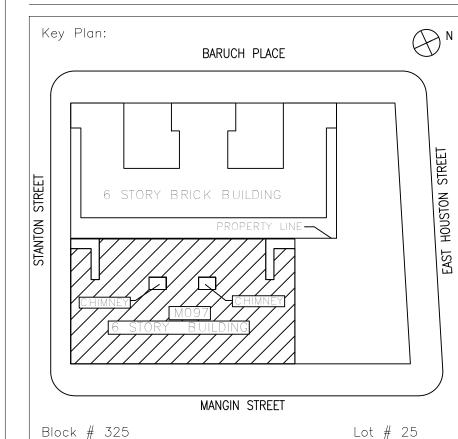
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NOTE: Drawing may be printed at reduced scale

IT IS A VIOLATION OF THE STATE EDUCATION LAW SECTION 7209 (2) FOR ANY PERSON TO ALTER AN ITEM IN ANY WAY UNLESS SUCH PERSON IS ACTING UNDER THE DIRECTION OF A LICENSED PROFESSIONAL ENGINEER, AND THE ENGINEER STAMPS SUCH CHANGES

ISSUED FOR BID No. Date Revision



NASER HAMOUDEH, P.E. SCA Design Manager: JEFFREY RABINER, P.E. Project Architect/Engineer: JOHN HIGGINS, P.E. Discipline Lead: DANIEL GIANNOTTA Designer: DANIEL GIANNOTTA Drawn by: JOHN HIGGINS, P.E. Checked by:

Design No or LLW No.: | Building ID:

BARD COLLEGE HS, MANHATTAN WASTE SYSTEM

525 EAST HOUSTON STREET NEW YORK, NY 10002

BUILDING DEPARTMENT NOTES, FEMA FIRM ELEVATIONS AND FIRM MAPS

DOB NOW JOB #M00660122-I1


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Sheets in Contract Set: 03 of 42

05/09/2023

03 of 37



ZONE OF PUBLIC PROTECTION PLAN

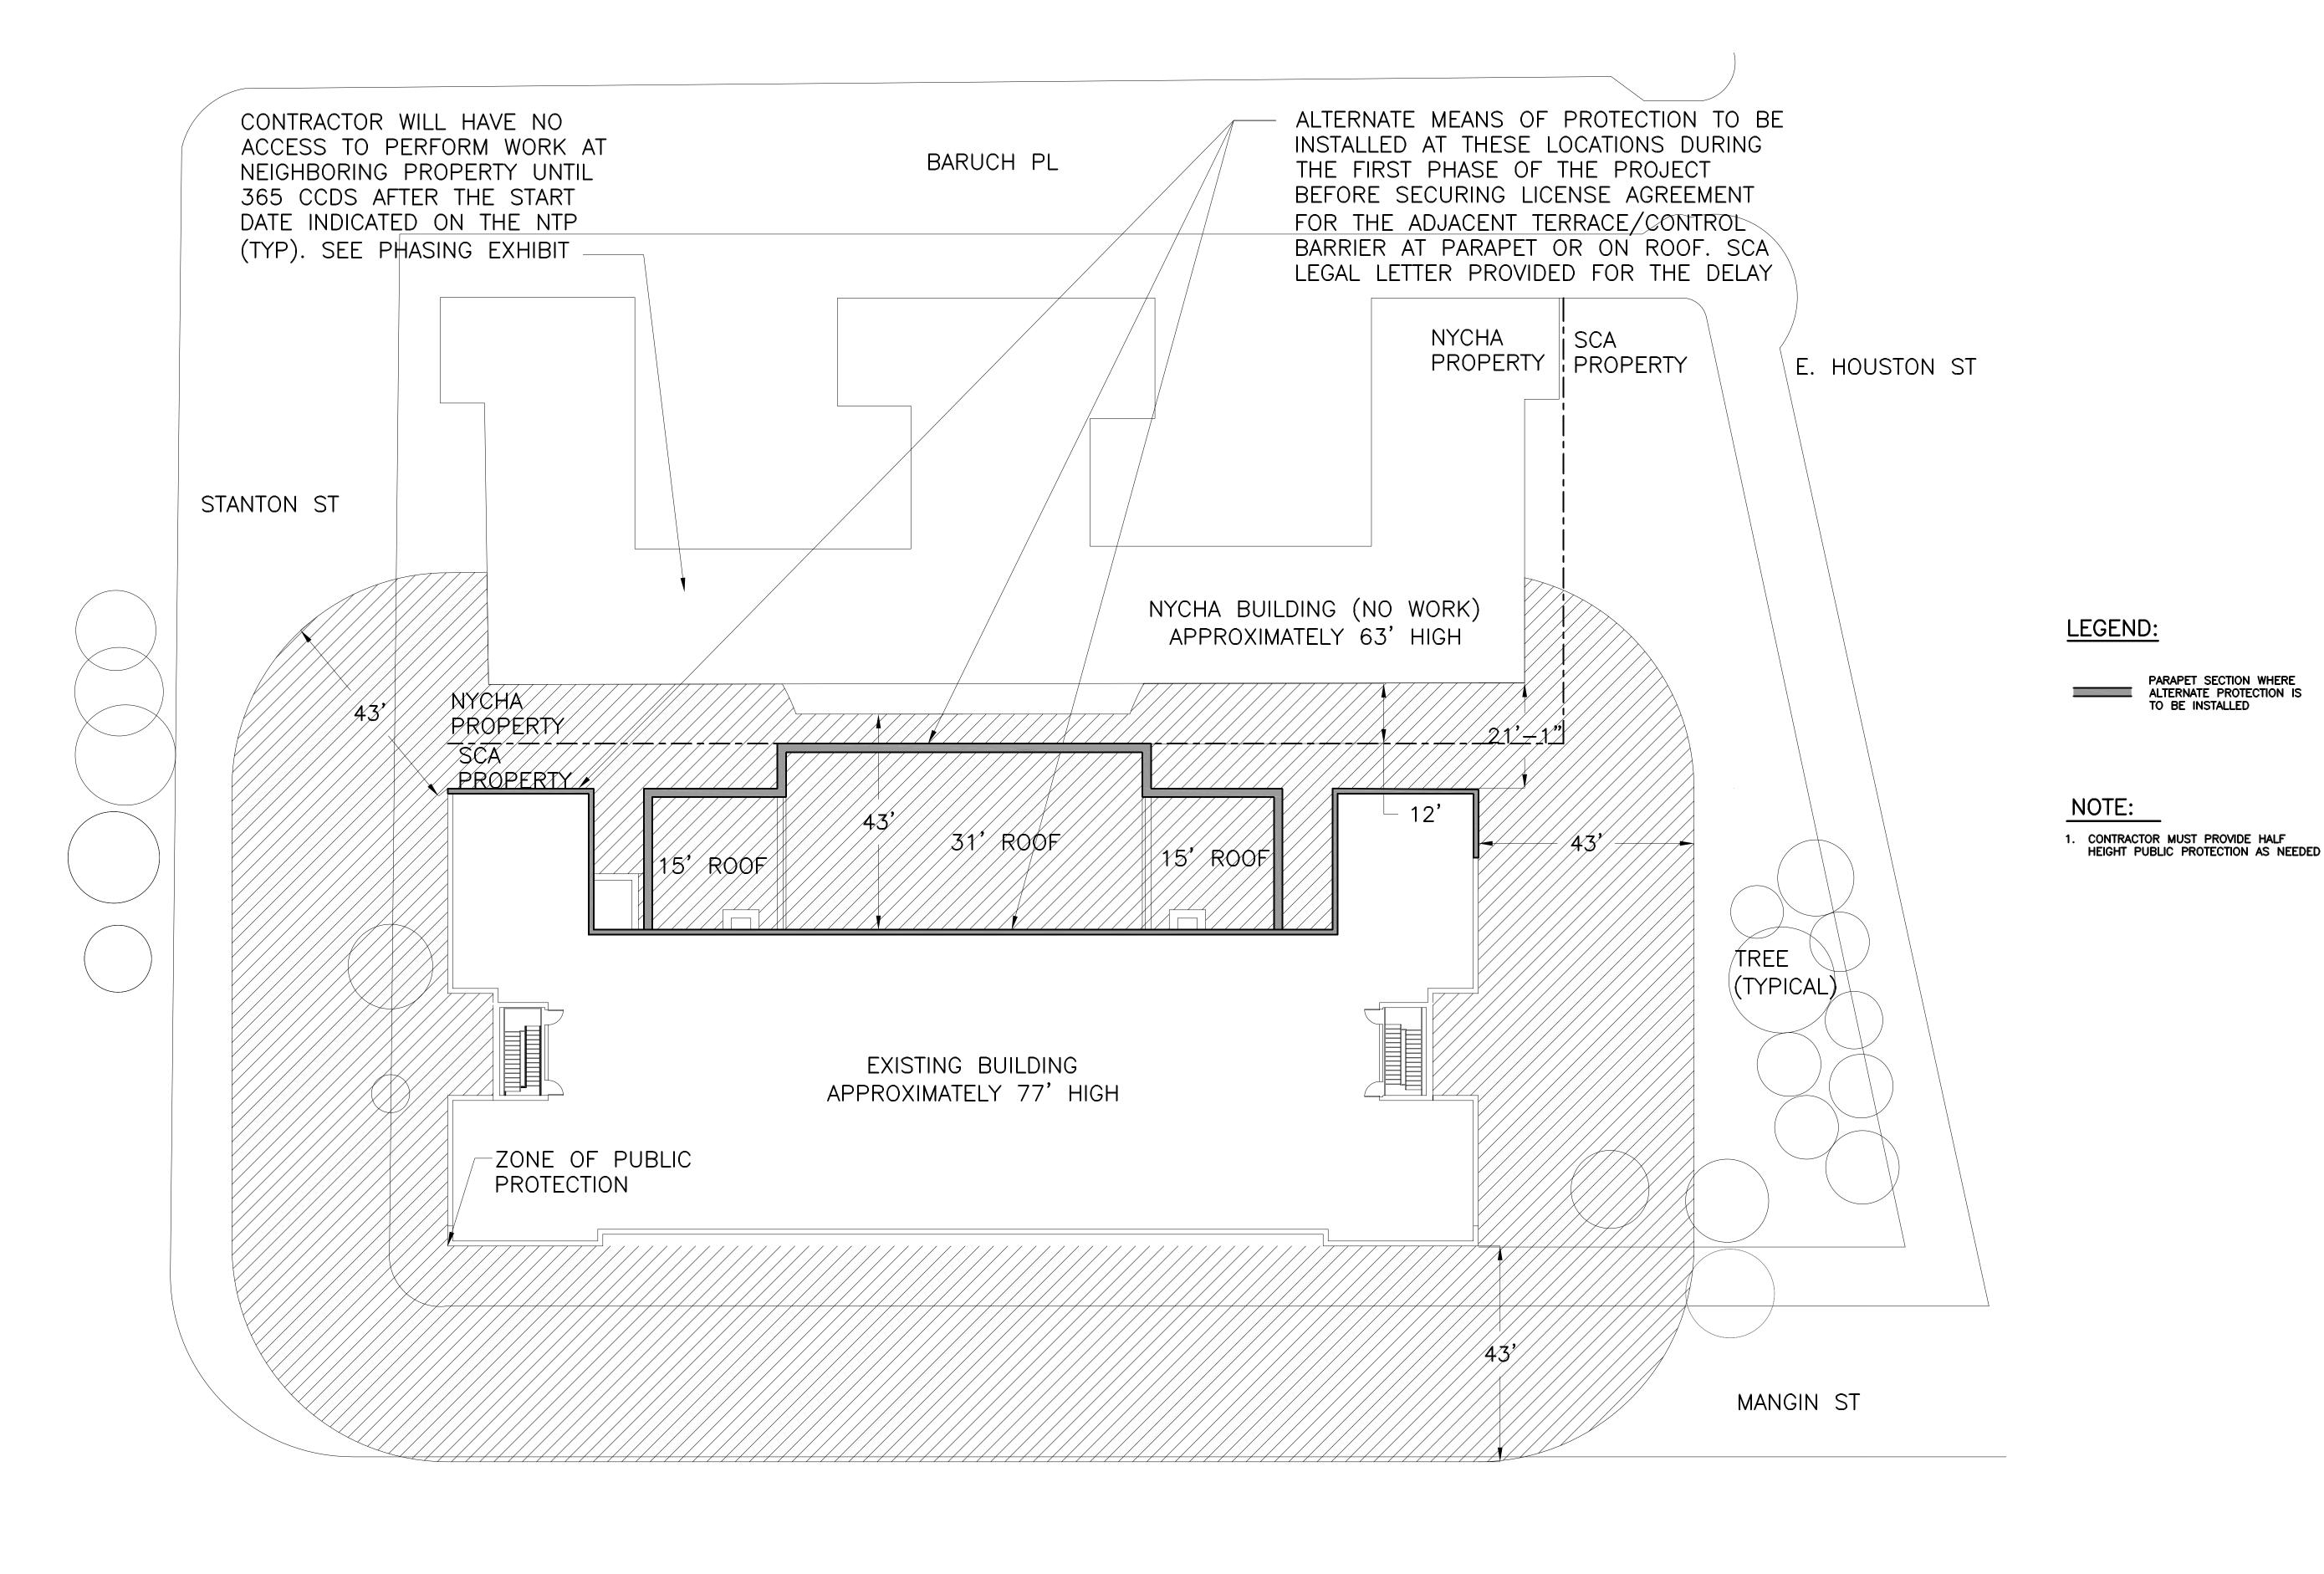SCALE IN FEET: 1 8 16

President & CEO
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Lorraine Grillo



Architecture & Engineering
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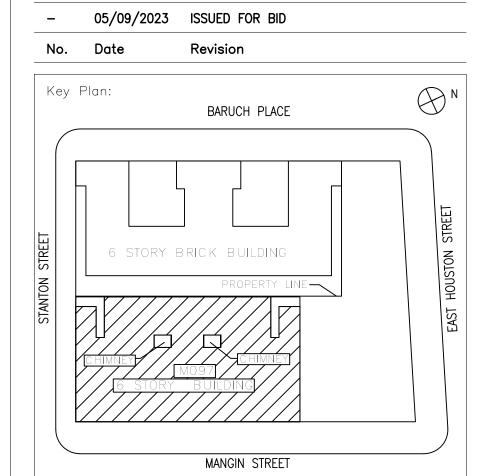
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SCA Design Manager:

Project Architect/Engineer:

Discipline Lead:

Designer:

BRIAN HIGGINS

Lot # 25

Lot # 25

 $\begin{array}{|c|c|c|c|c|c|} \hline \textbf{Drawn by:} & \textbf{BRIAN HIGGINS} \\ \hline \textbf{Checked by:} & \textbf{JOHN HIGGINS, P.E.} \\ \hline \textbf{Design No or LLW No.:} & \textbf{Building ID:} & \textbf{Date:} \\ \hline \textbf{D019998} & \textbf{M097} & \textbf{05/09/2023} \\ \hline \end{array}$

BARD COLLEGE HS, MANHATTAN WASTE SYSTEM

Address: 525 EAST HOUSTON STREET NEW YORK, NY 10002

ZONE OF PUBLIC PROTECTION PLAN

DOB NOW JOB #M00660122-I1



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